
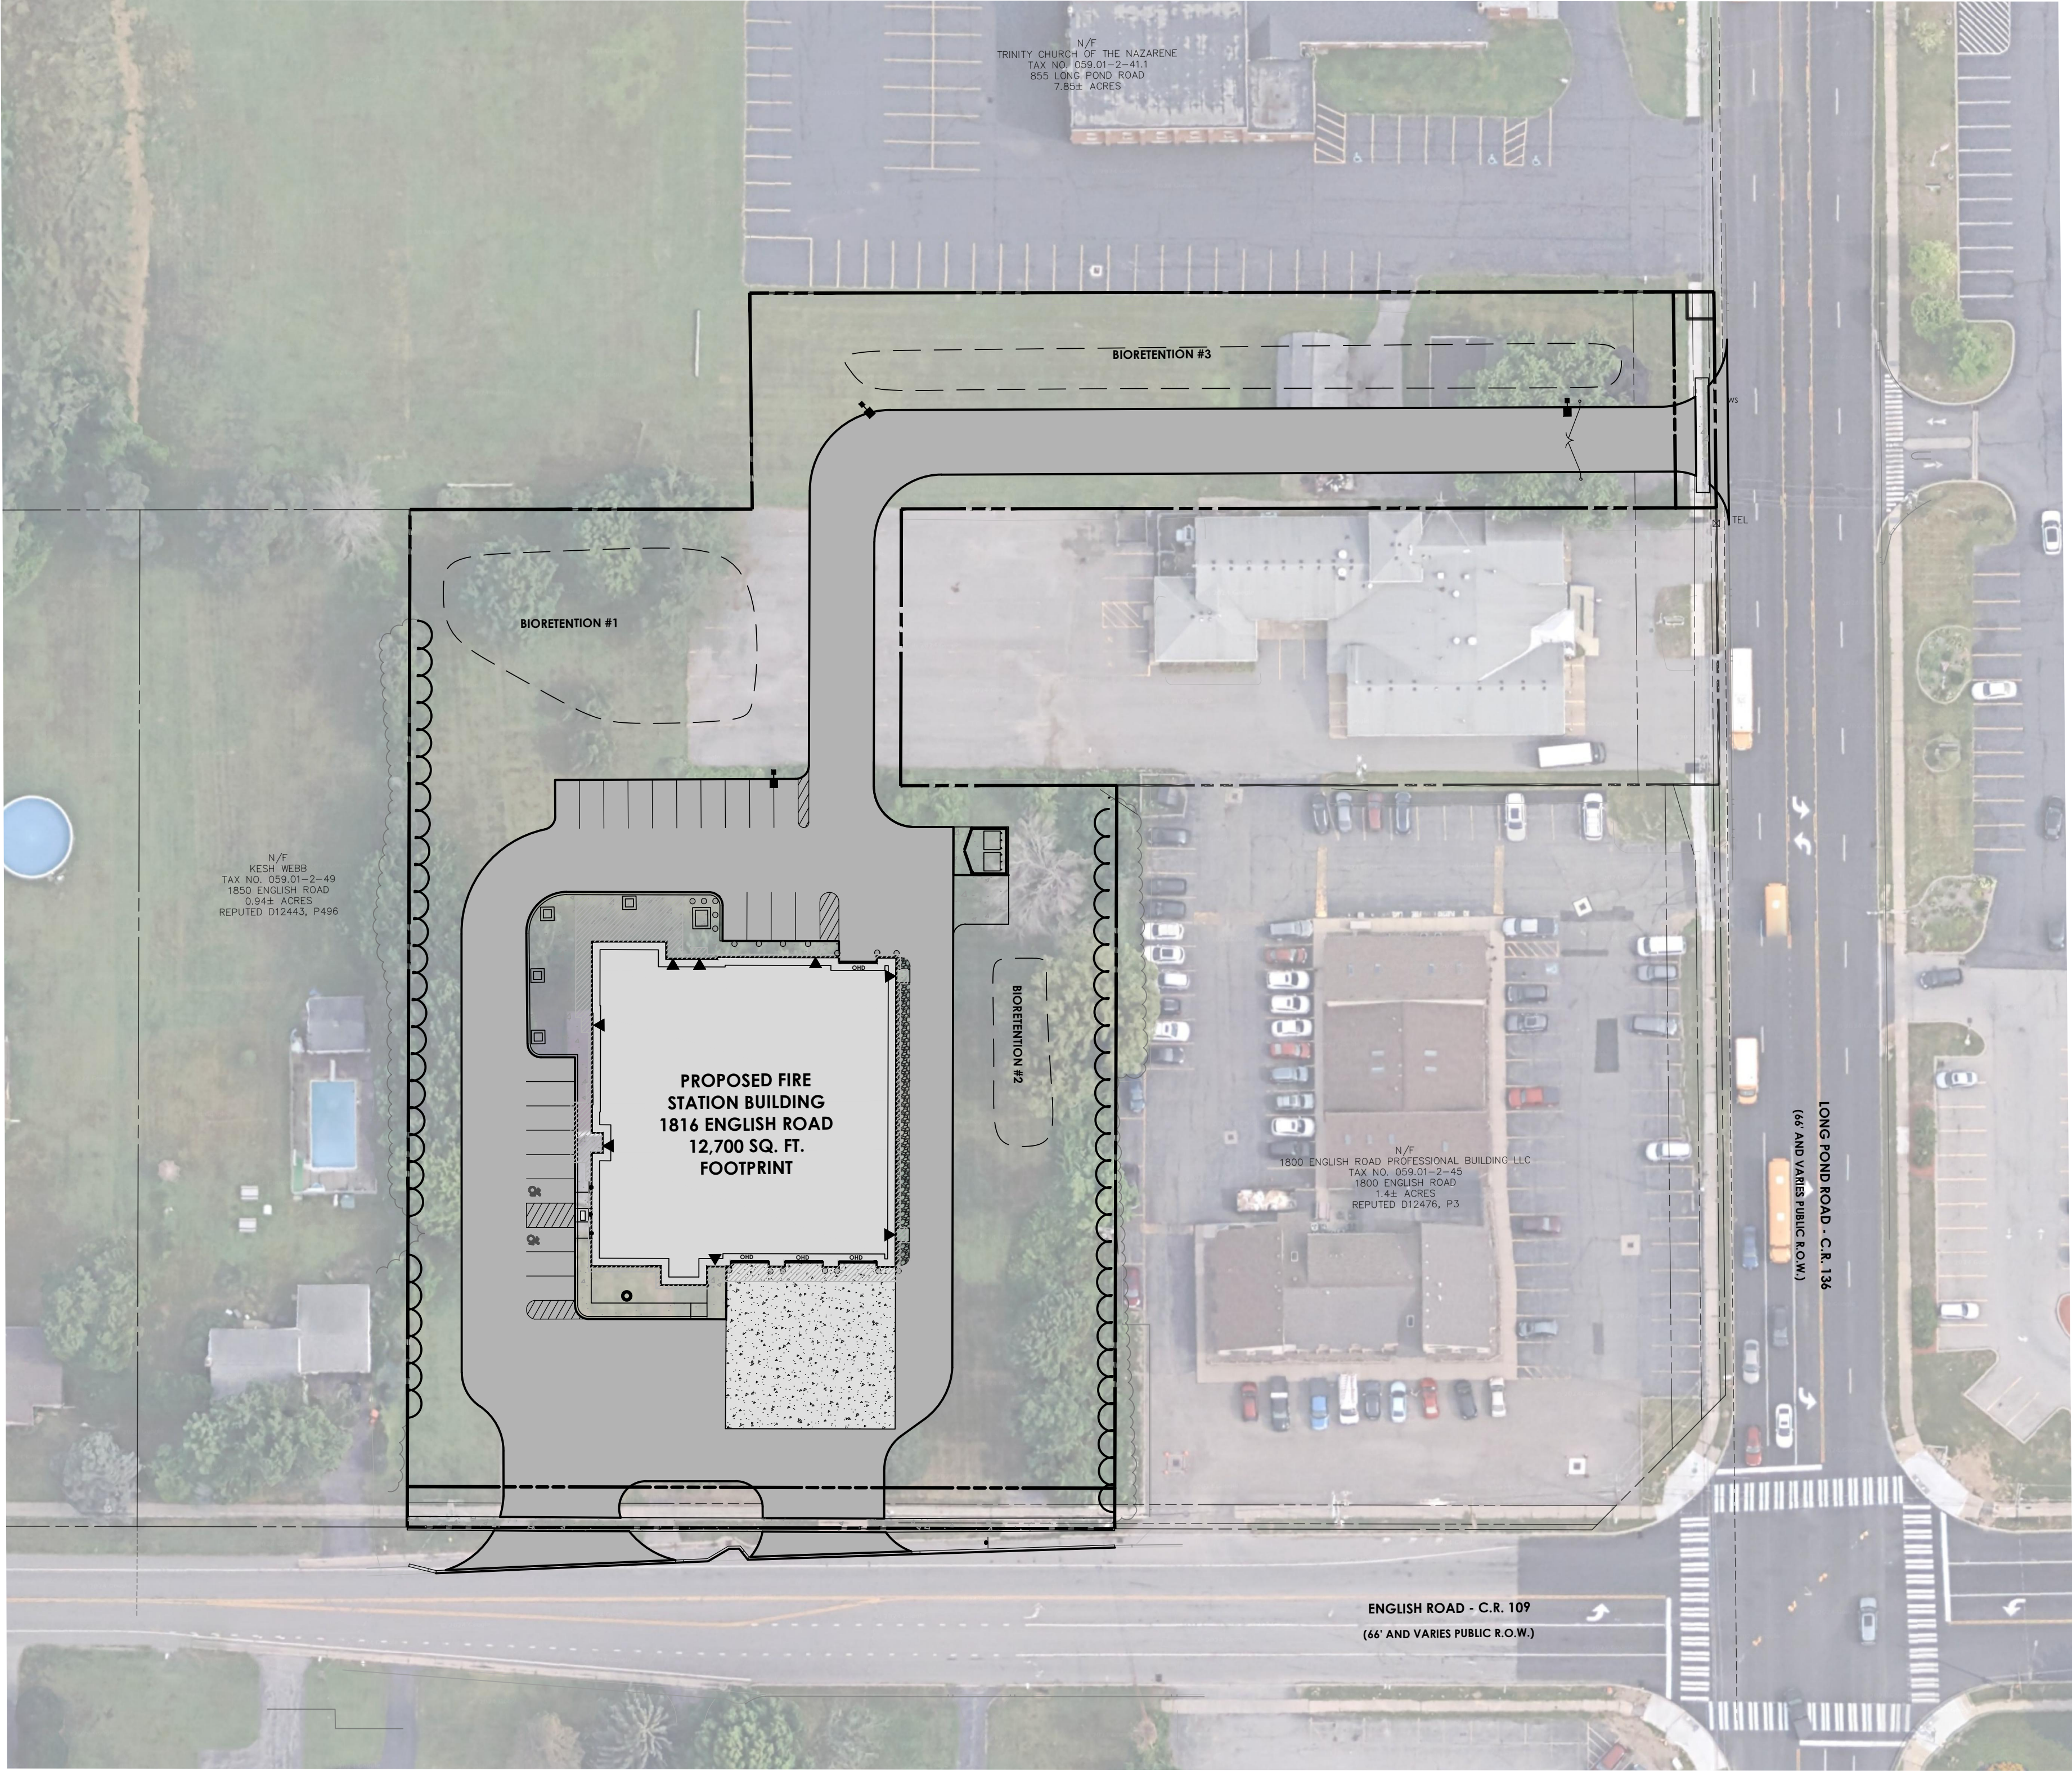


SITE DEVELOPMENT PLANS FOR
NORTH GREECE FIRE DISTRICT
TOWN OF GREECE, MONROE COUNTY, NEW YORK
P.N. 20233530.0002

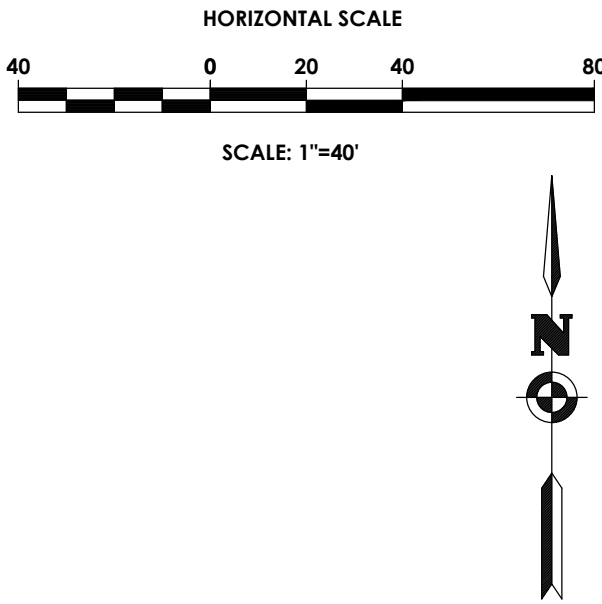

MONROE COUNTY
DEPT. OF TRANSPORTATION

APPROVED _____

DATE _____

APPLICATIONS FOR PERMITS WILL NOW BE ACCEPTED
THIS PROJECT APPROVAL IS VALID FOR TWO (2) YEARS


DRAWING INDEX

C 101	COVER
C 102	SITE PLAN
C 103	EXISTING CONDITIONS & DEMOLITION PLAN
C 104	UTILITY PLAN
C 105	GRADING & EROSION CONTROL PLAN
C 106	LANDSCAPING & LIGHTING PLAN
C 201	NOTES
C 202-205	DETAILS

BID SET

PASSERO
architecture engineering

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Client:
NORTH GREECE
FIRE DISTRICT
1766 LATTI ROAD
ROCHESTER, NY 14612

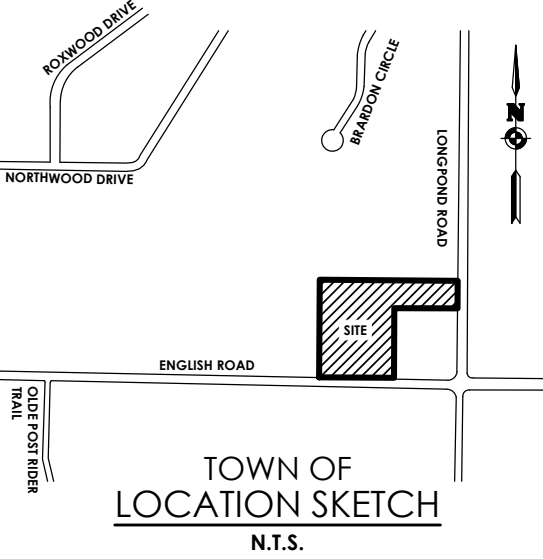PASSERO ASSOCIATES

242 West Main Street Suite 100
Rochester, New York 14614
(585) 325-1000
Fax: (585) 325-1691
Principal-in-Charge: DAVID COX, PE
Project Manager: ANDREW BURNS, PE
Designed by: JACOB LEWIS



Revisions				
No.	Date	By	Description	
1				

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COVER
NORTH GREECE
FIRE DISTRICT


Town: GREECE
County: MONROE State: NY

Project No.
20233530.0002

Drawing No.
C-101

Scale:
1" = 40'

Date
NOVEMBER 4, 2024

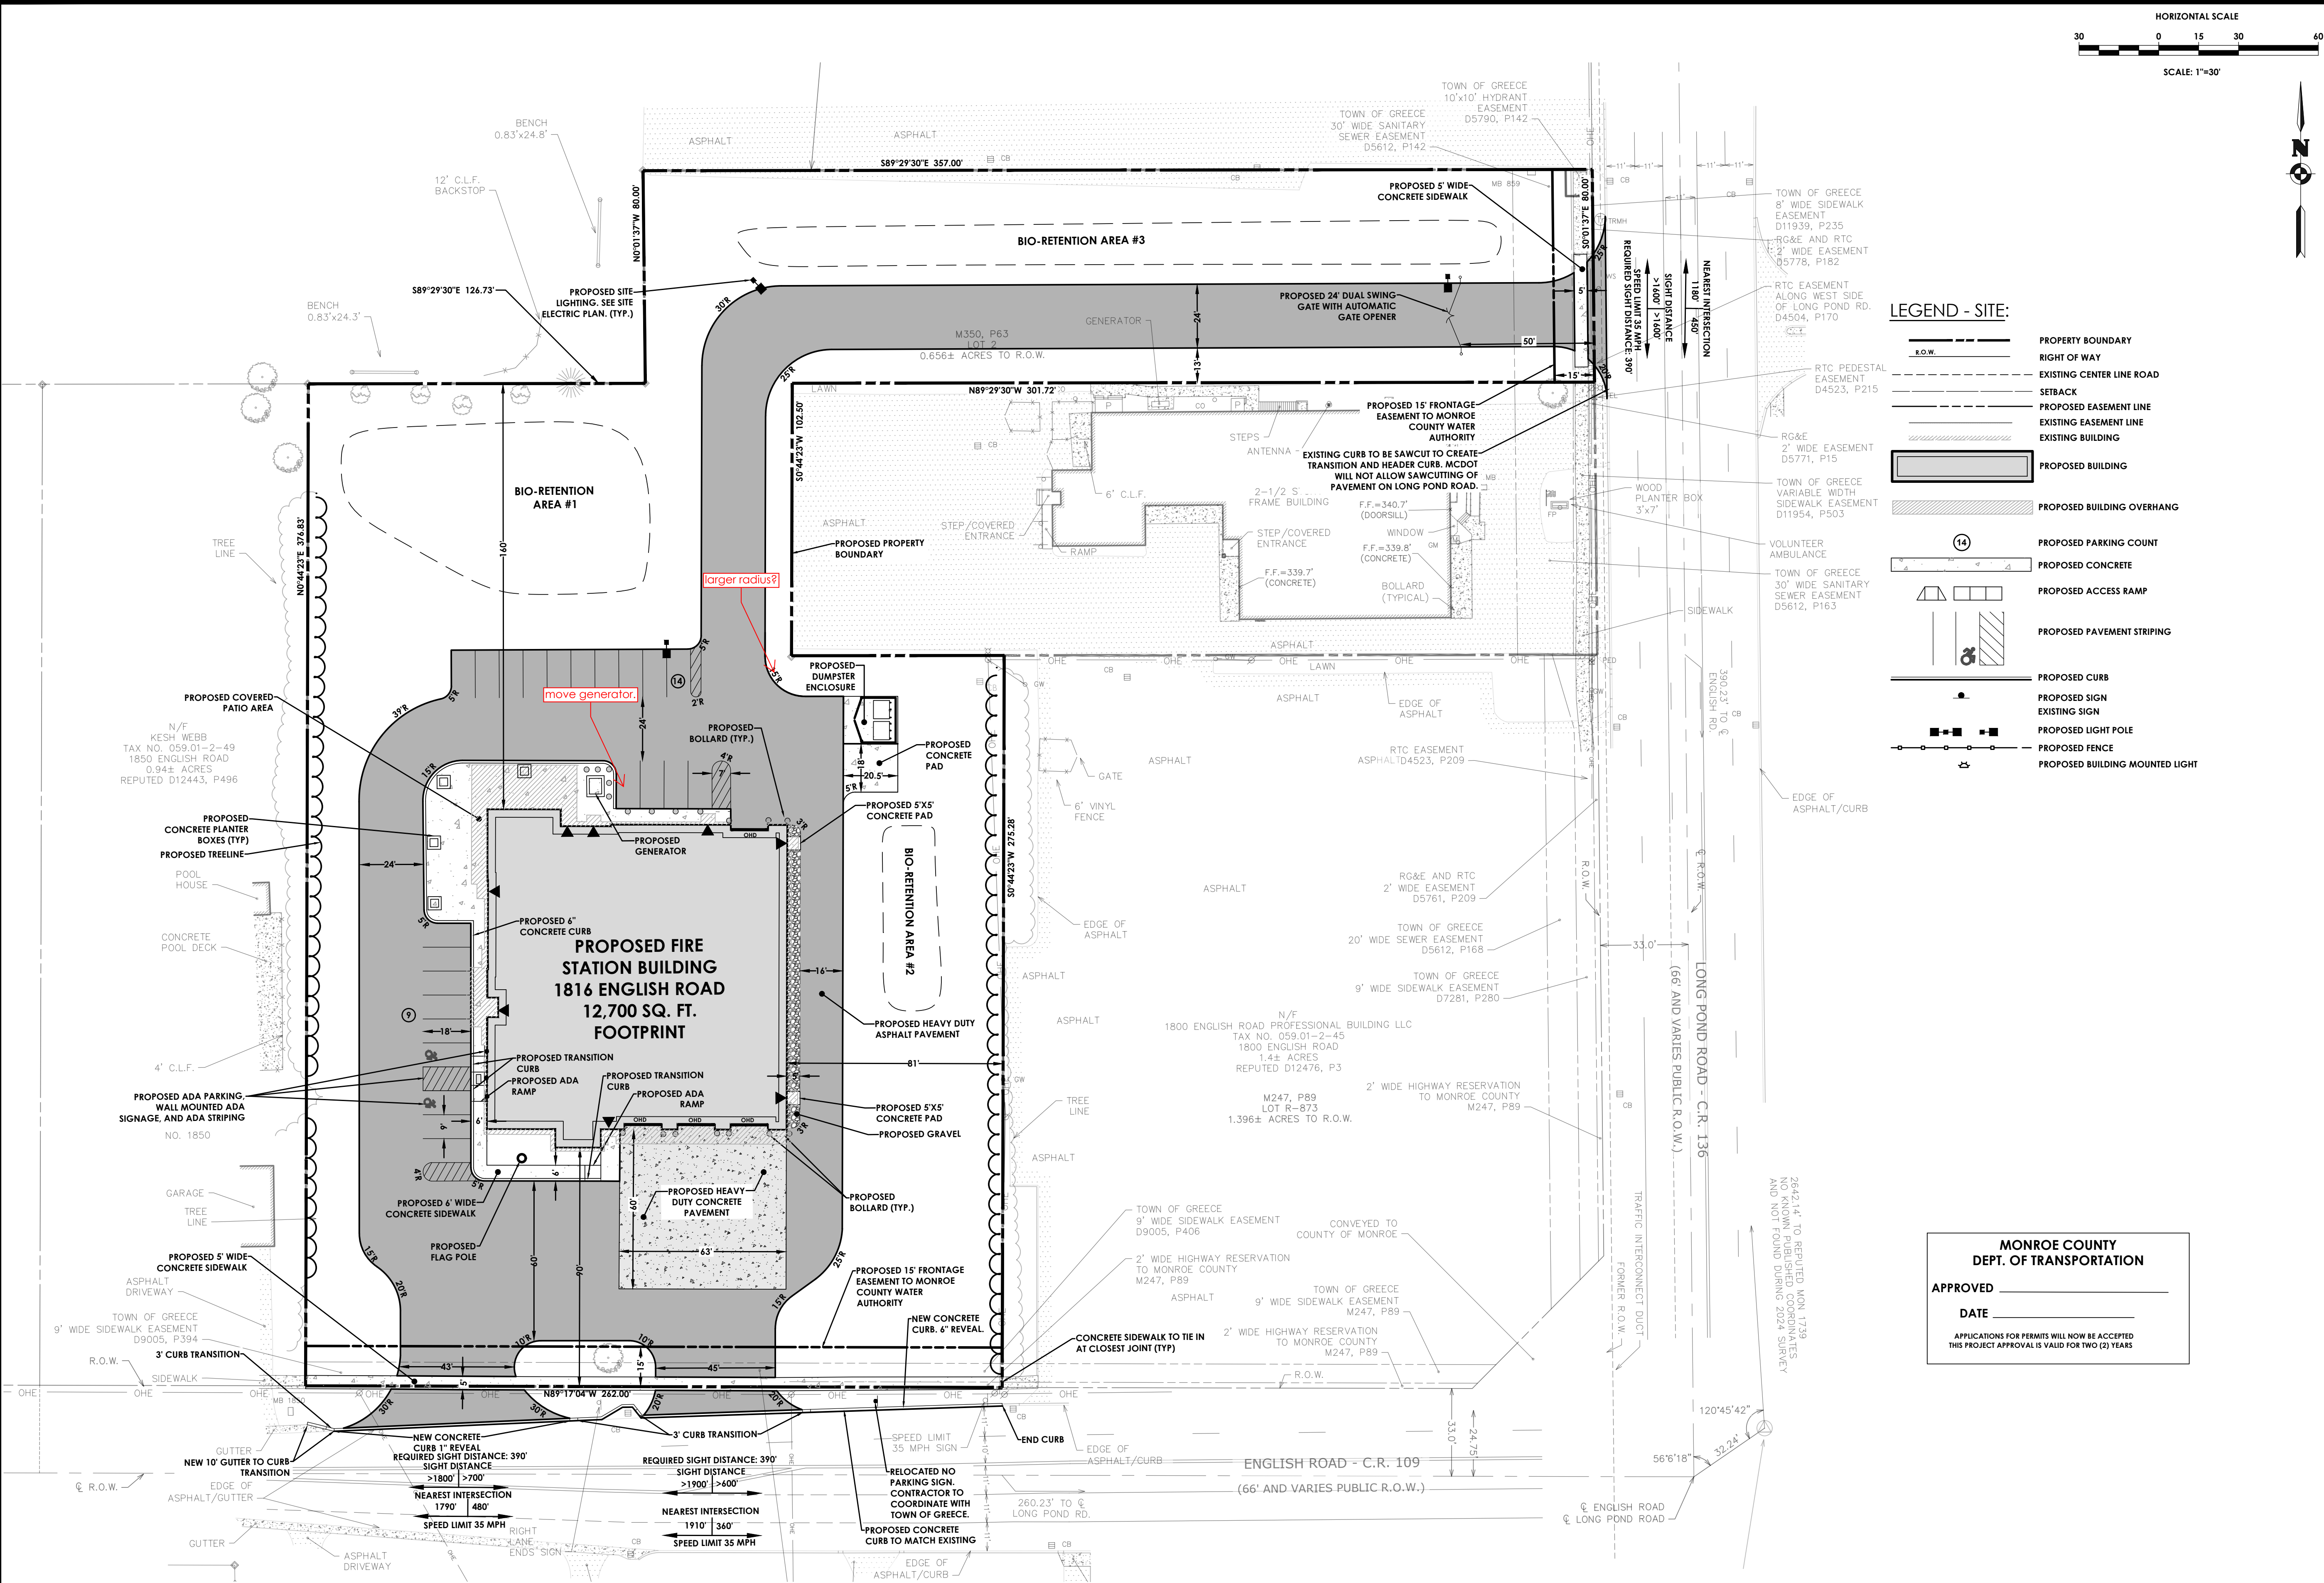

LEGEND - SITE:

- PROPERTY BOUNDARY
- RIGHT OF WAY
- EXISTING CENTER LINE ROAD
- SETBACK
- PROPOSED EASEMENT LINE
- EXISTING EASEMENT LINE
- EXISTING BUILDING
- PROPOSED BUILDING
- PROPOSED BUILDING OVERHANG
- PROPOSED PARKING COUNT
- PROPOSED CONCRETE
- PROPOSED ACCESS RAMP
- PROPOSED PAVEMENT STRIPING
- PROPOSED CURB
- PROPOSED SIGN
- EXISTING SIGN
- PROPOSED LIGHT POLE
- PROPOSED FENCE
- PROPOSED BUILDING MOUNTED LIGHT


MONROE COUNTY
DEPT. OF TRANSPORTATION

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Client:
**NORTH GREECE
FIRE DISTRICT**
1766 LATTA ROAD
ROCHESTER, NY 14612

PASSERO ASSOCIATES

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SITE PLAN

**NORTH GREECE
FIRE DISTRICT**

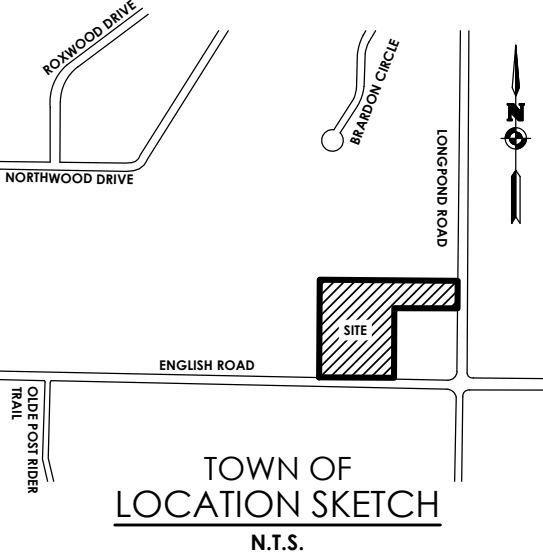County: MONROE State: NY

Project No.
20233530.0002


Drawing No.

C-102

Scale:
1" = 30'

Date
NOVEMBER 4, 2024

BID SET

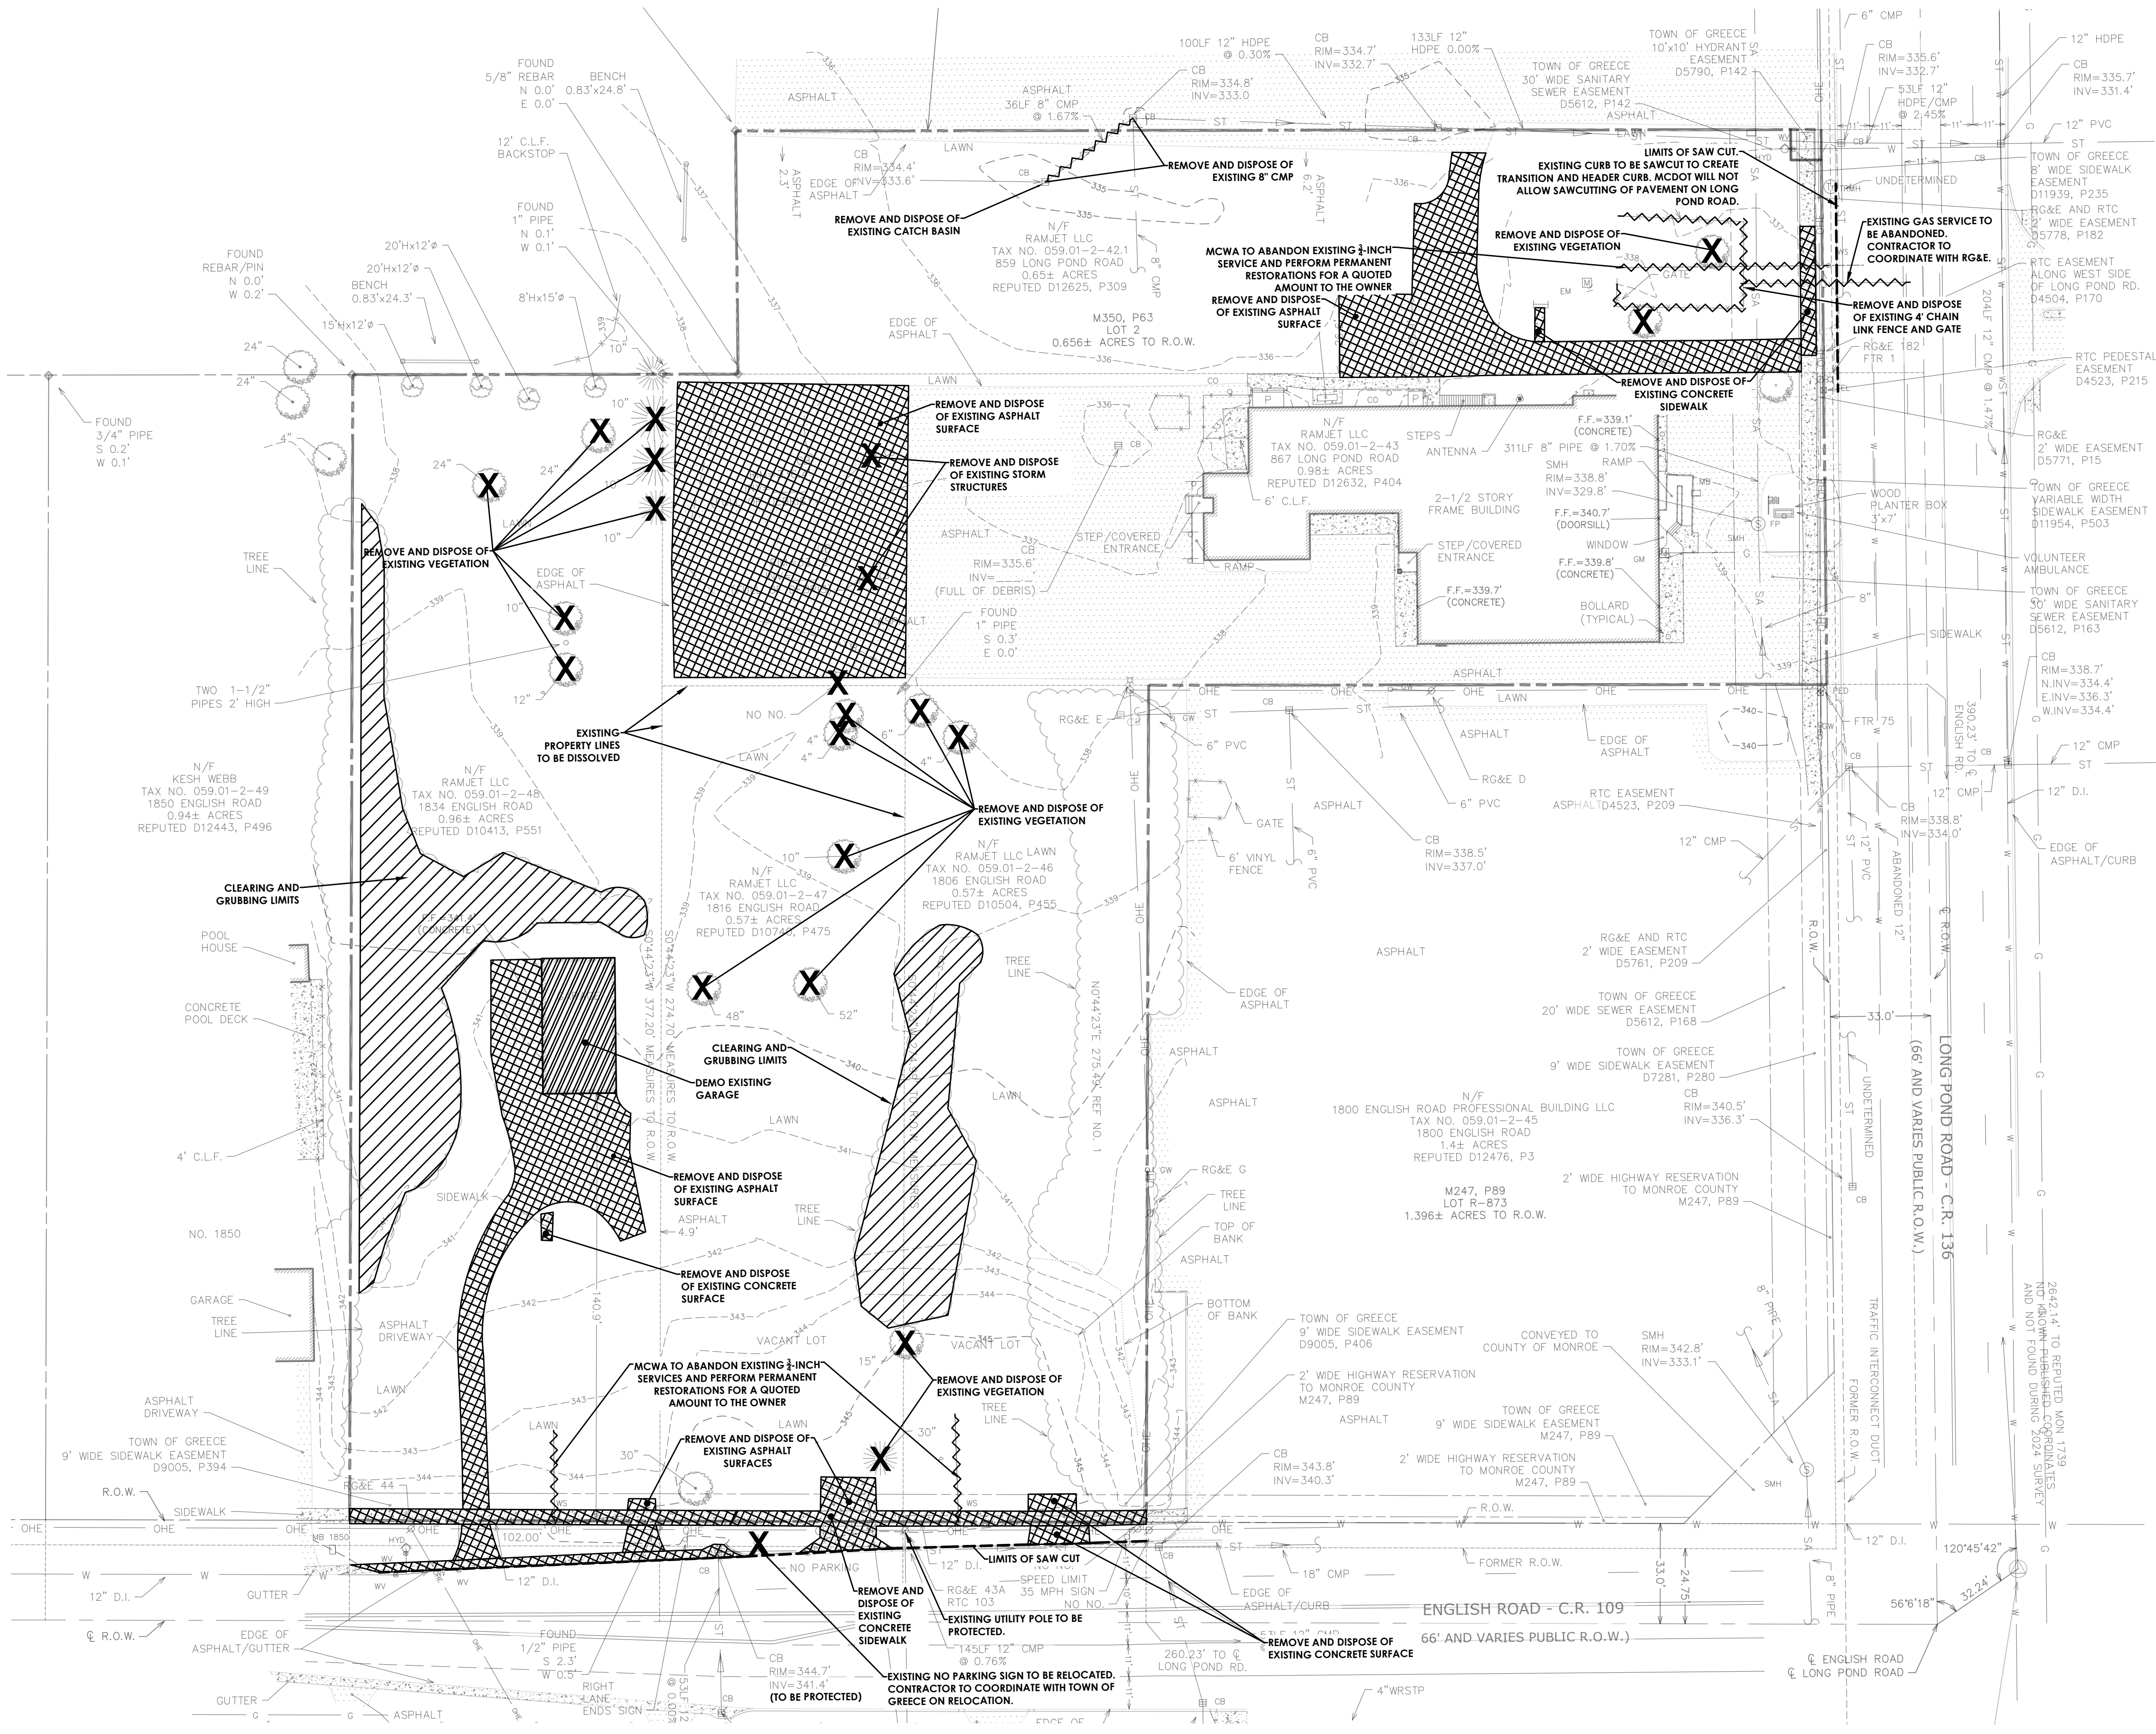

LEGEND - EXISTING:

- R.O.W.
- EXISTING CENTER LINE ROAD
- EXISTING BUILDING
- EXISTING FENCE
- EXISTING EASEMENT LINE
- SETBACK
- EXISTING MAJOR CONTOUR
- EXISTING MINOR CONTOUR
- EXISTING STORM SEWER & MH
- EXISTING WATER SERVICE & VALVE
- EXISTING SIGN
- EXISTING SANITARY SEWER AND MANHOLE
- EXISTING ELECTRIC LINE & POLE
- EXIST. LIGHT POLE
- EXIST. ELECTRIC MANHOLE
- EXIST. ELECTRIC HANDHOLE
- EXIST. GAS VALVE
- EXIST. GAS MAIN
- EXIST. WATER MAIN
- EXIST. ELECTRIC LINE
- EXISTING TREE/BRUSH LINE
- EXISTING ASPHALT AND CONCRETE TO BE REMOVED
- CLEARING AND GRUBBING LIMITS
- EXISTING BUILDING TO BE REMOVED
- EXISTING FEATURE TO BE REMOVED

MCDOT NOTES:

- MCDOT WILL NOT ALLOW SAWCUTS IN PAVEMENT PLACED WITHIN THE LAST FIVE (5) YEARS.

MONROE COUNTY
DEPT. OF TRANSPORTATION

APPROVED _____

DATE _____

APPLICATIONS FOR PERMITS WILL NOW BE ACCEPTED
THIS PROJECT APPROVAL IS VALID FOR TWO (2) YEARS

BID SET

DATE _____

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TOWN OF
LOCATION SKETCH
N.T.S.

Client:
NORTH GREECE
FIRE DISTRICT
1766 LATTA ROAD
ROCHESTER, NY 14612

PASSERO ASSOCIATES

242 West Main Street Suite 100
Rochester, New York 14614
(585) 325-1000
Fax: (585) 325-1691
Principal-in-Charge
Project Manager
Designed by
DAVID COX, PE
ANDREW BURNS, PE
JACOB LEWIS



Revisions

No.	Date	By	Description
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EXISTING CONDITIONS
& DEMOLITION PLAN
NORTH GREECE
FIRE DISTRICT

Town: GREECE
County: MONROE State: NY



Project No.
20233530.0002

Drawing No.

C 103

Scale:
1" = 30'

Date
NOVEMBER 4, 2024

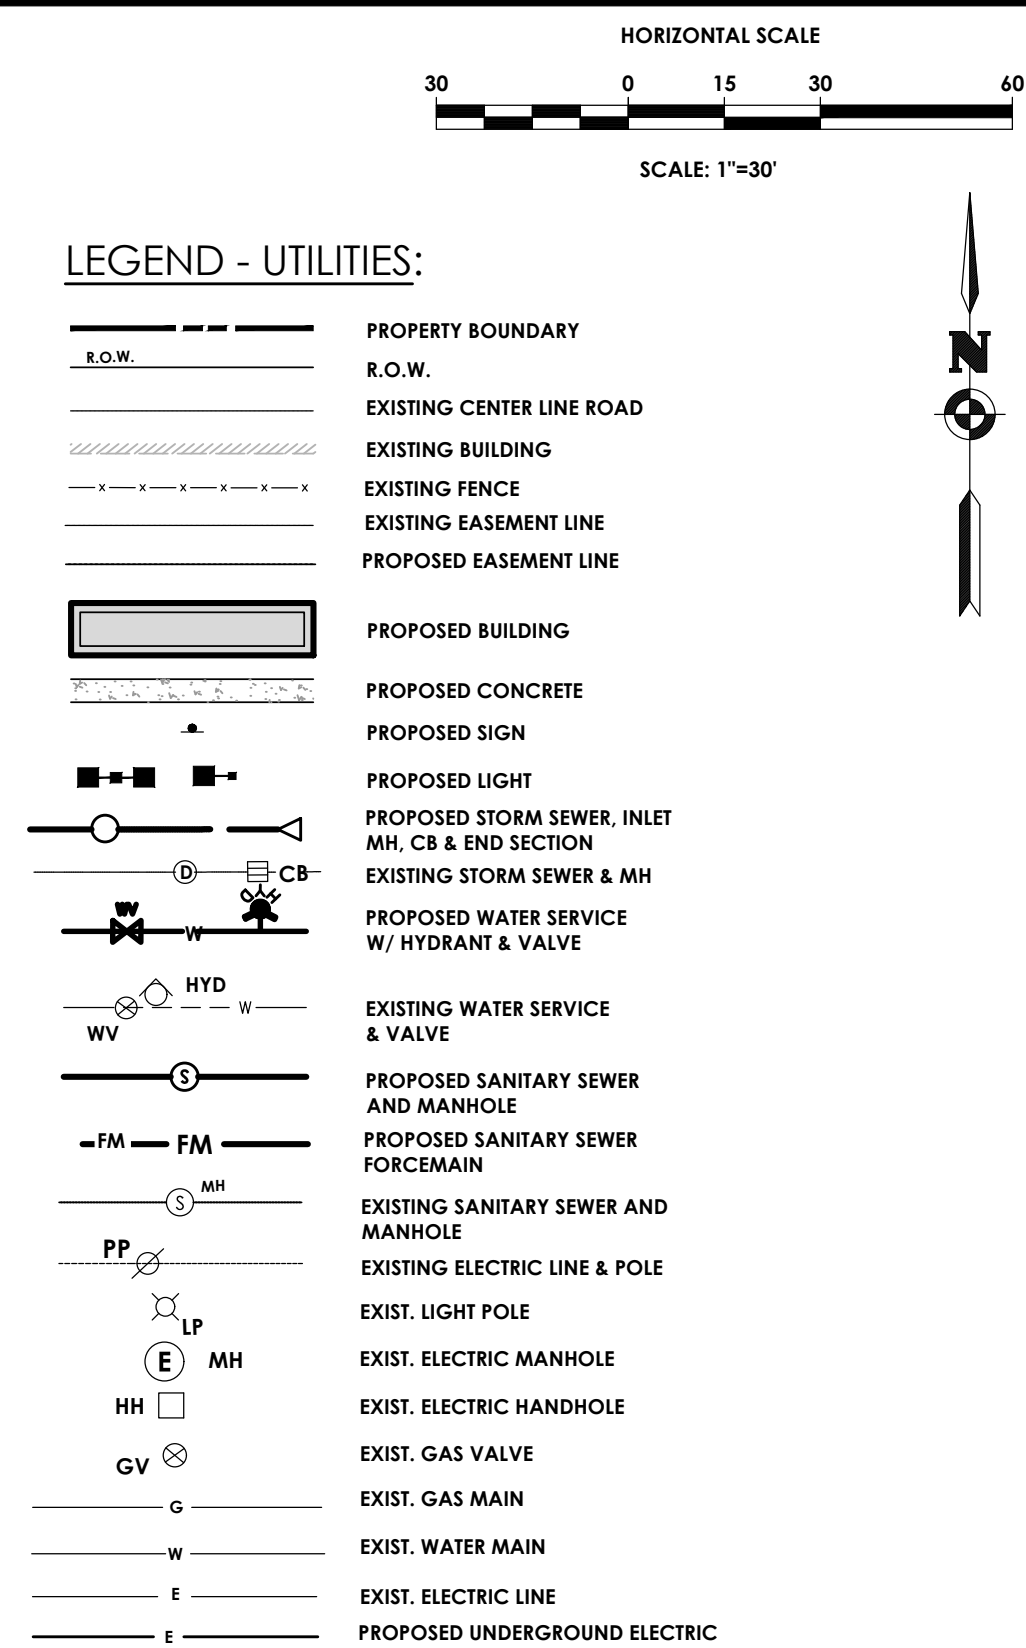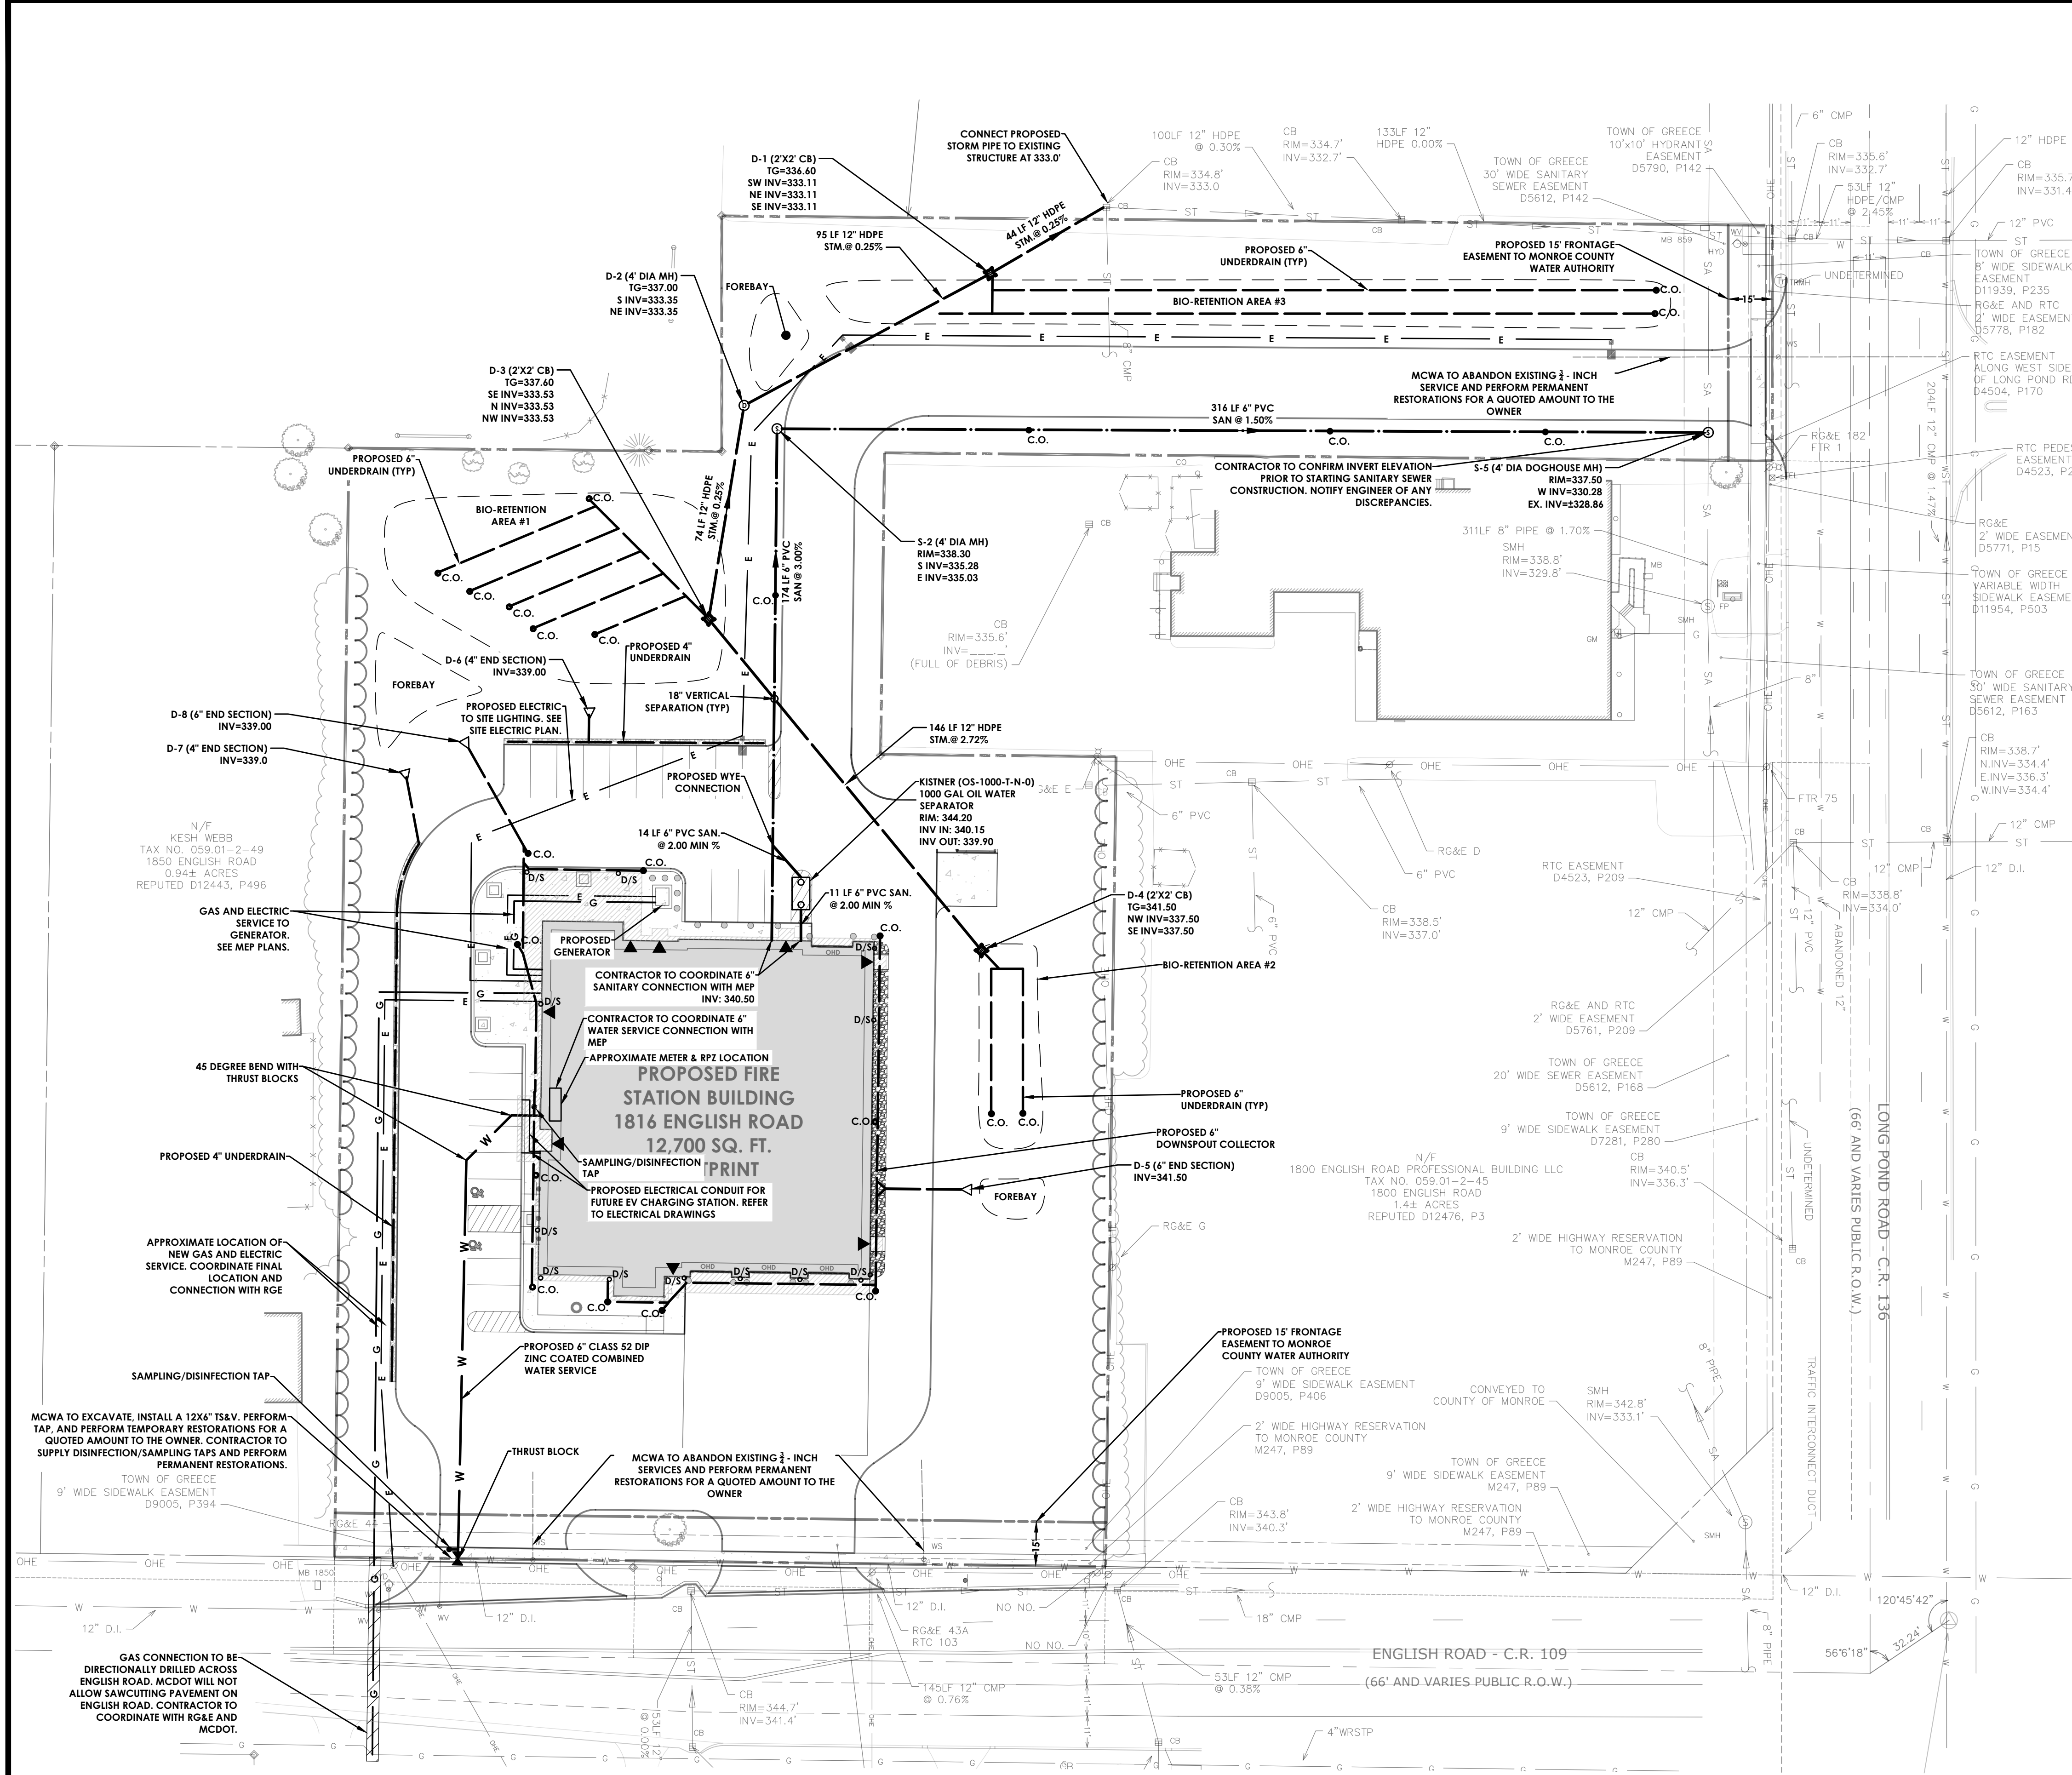

MCDOT NOTES:

1. MCDOT WILL NOT ALLOW SAWCUTS IN PAVEMENT PLACED WITHIN THE LAST FIVE (5) YEARS.

Watermain Approval

Monroe County Department of Public Health

These plans for Public Water System Extension / Improvement are hereby approved pursuant to 10NYCRRS of the State Sanitary Code subject to conditions of Approval

Director of Public Health

By	Public Health Engineer	Date
----	------------------------	------

**If you excavate anywhere in
New York State,
except NYC or Long Island, call**

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New York**

1-800-962-7962

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MONROE COUNTY
DEPT. OF TRANSPORTATION

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APPLICATIONS FOR PERMITS WILL NOW BE ACCEPTED
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Northwest Quadrant Pure Waters District



Review Number _____

Conforms to Monroe County
Pure Waters Master Plan

Signature Date

APPROVED BY _____ DATE _____
MONROE COUNTY WATER AUTHORITY

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MONROE COUNTY
DEPT. OF TRANSPORTATION
APPROVED _____
DATE _____
APPLICATIONS FOR PERMITS WILL NOW BE ACCEPTED
THIS PROJECT APPROVAL IS VALID FOR TWO (2) YEARS

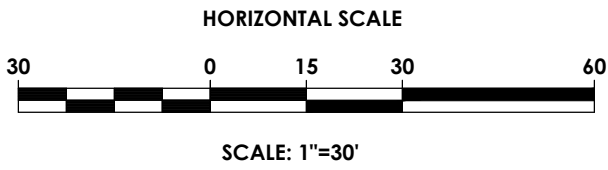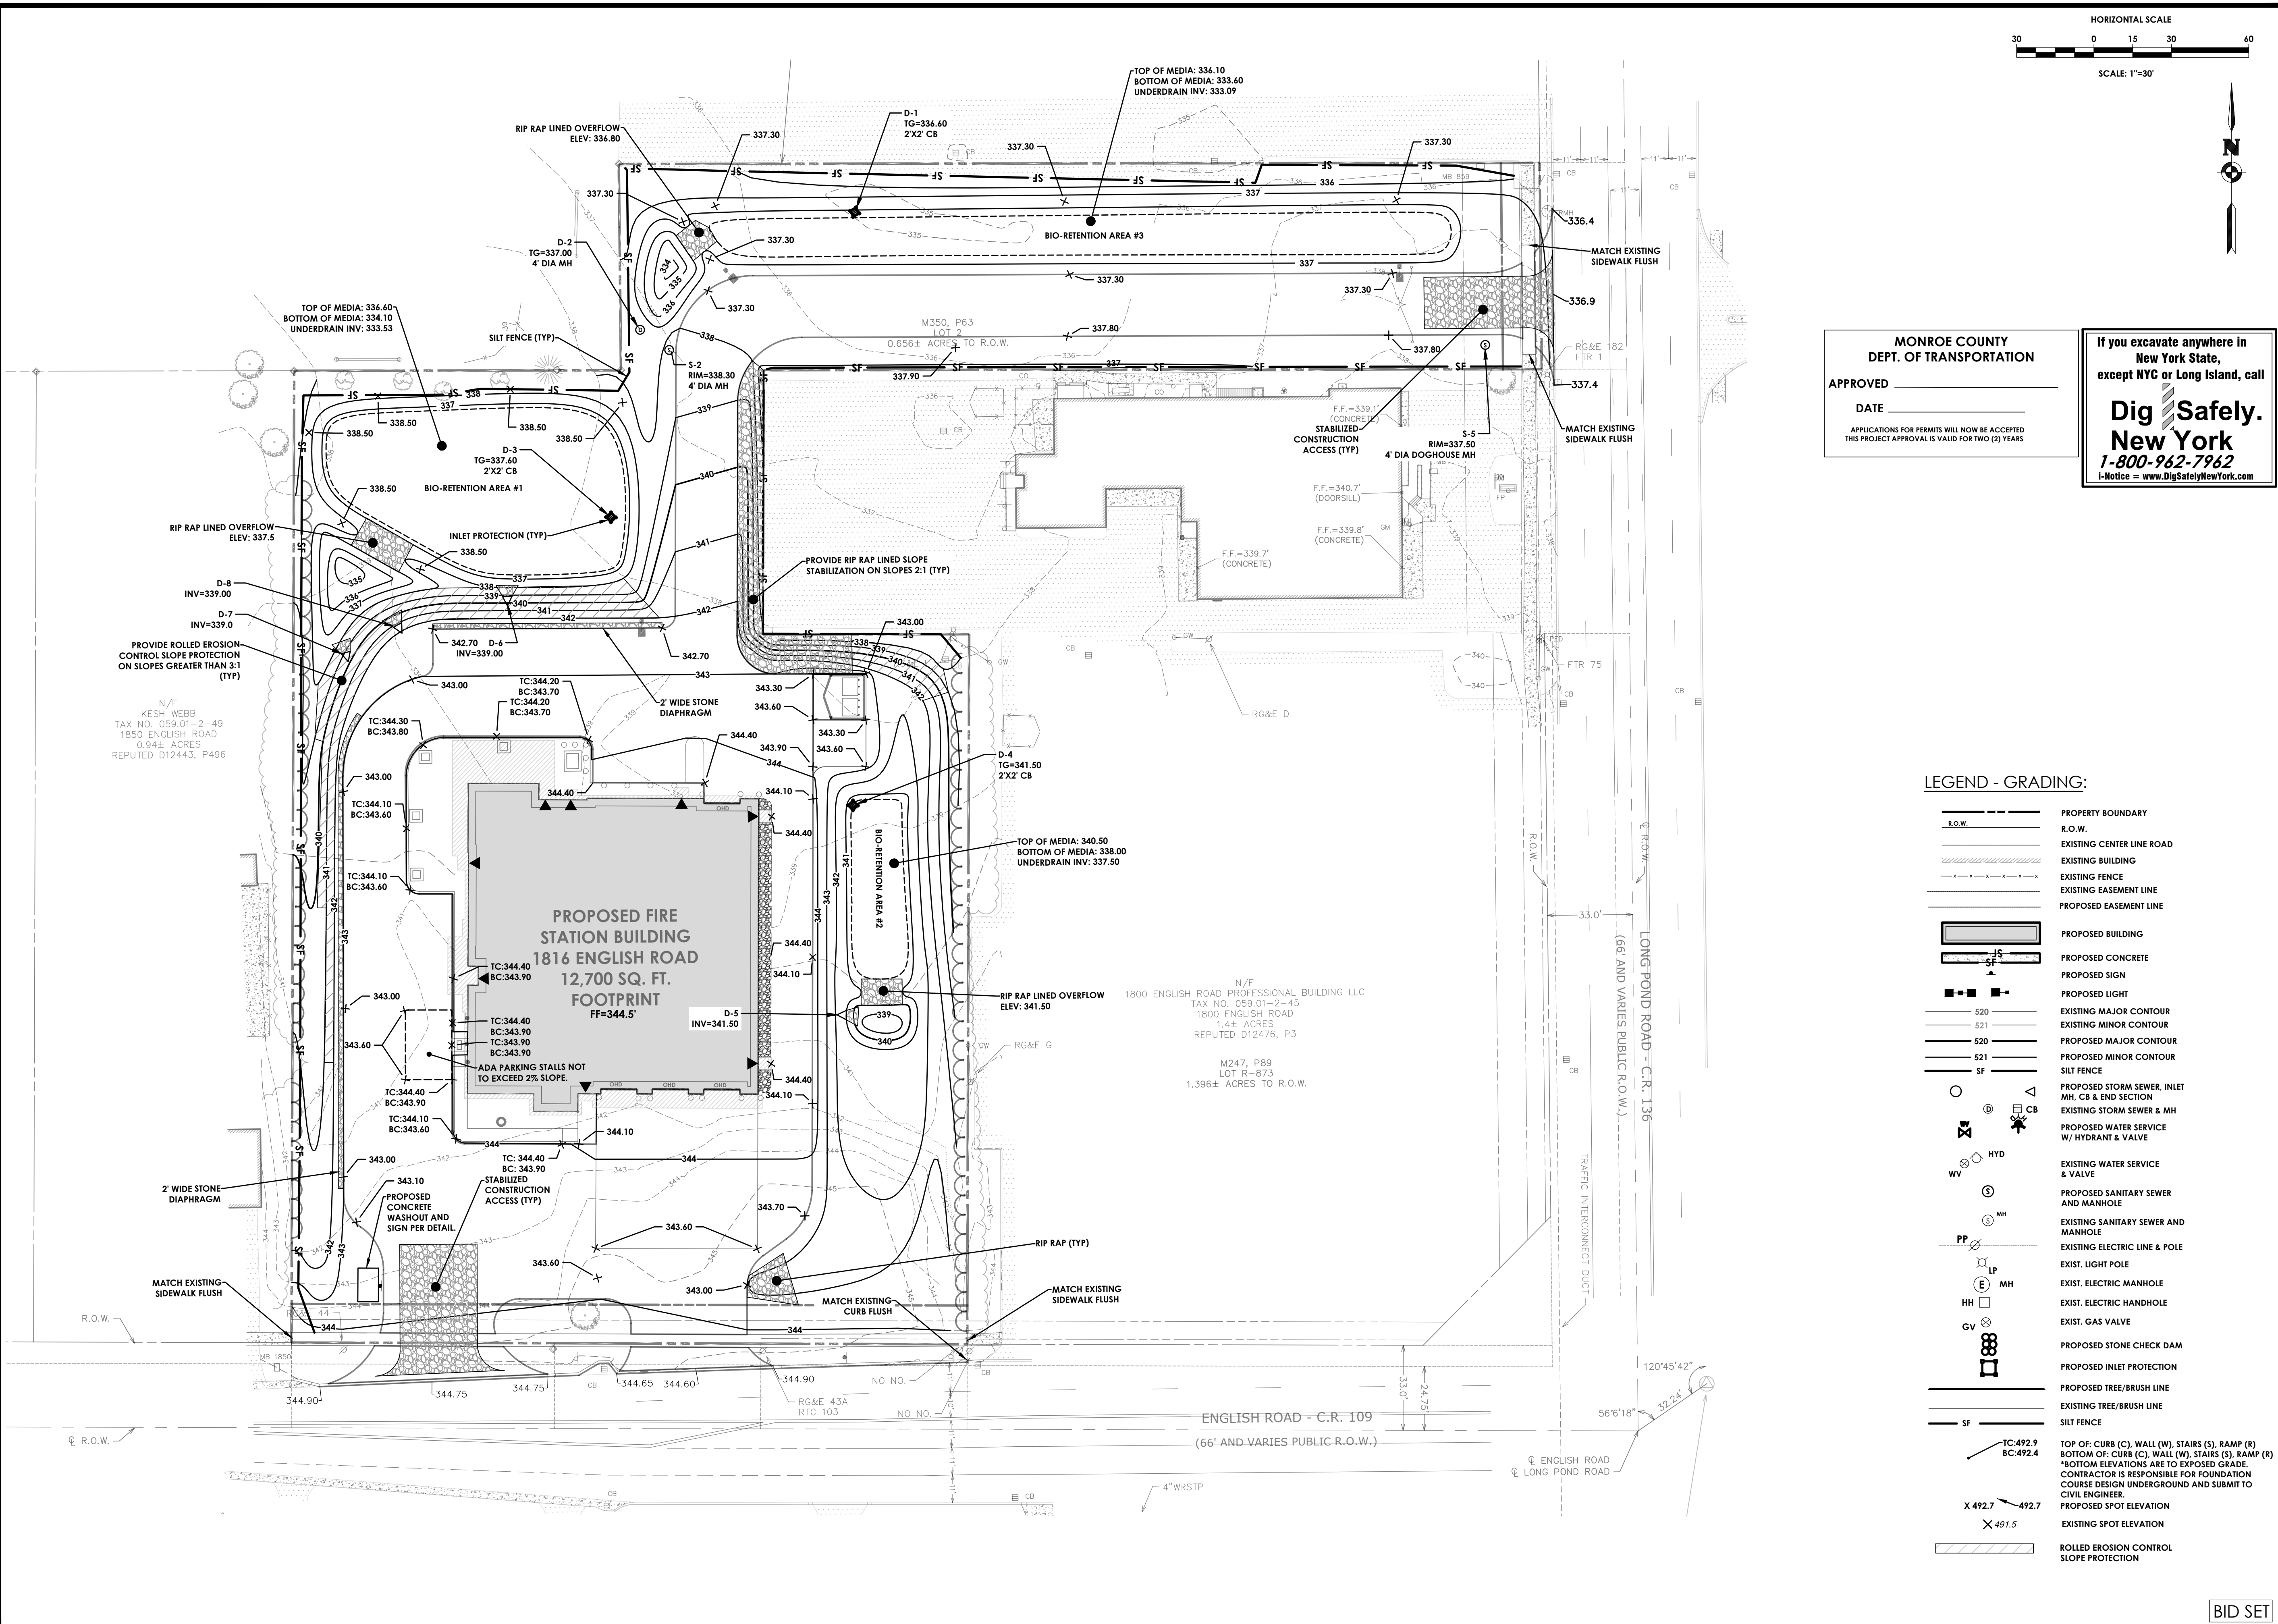
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except NYC or Long Island, call
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New York
1-800-962-7962
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LEGEND - GRADING:

- R.O.W.
- R.O.W.
- EXISTING CENTER LINE ROAD
- EXISTING BUILDING
- EXISTING FENCE
- EXISTING EASEMENT LINE
- PROPOSED EASEMENT LINE
- PROPOSED BUILDING
- PROPOSED CONCRETE
- PROPOSED SIGN
- PROPOSED LIGHT
- EXISTING MAJOR CONTOUR
- EXISTING MINOR CONTOUR
- PROPOSED MAJOR CONTOUR
- PROPOSED MINOR CONTOUR
- SILT FENCE
- PROPOSED STORM SEWER, INLET
- MH, CB & END SECTION
- EXISTING STORM SEWER & MH
- PROPOSED WATER SERVICE
- W/ HYDRANT & VALVE
- EXISTING WATER SERVICE
- & VALVE
- PROPOSED SANITARY SEWER
- AND MANHOLE
- EXISTING SANITARY SEWER AND
- MANHOLE
- EXISTING ELECTRIC LINE & POLE
- EXIST. LIGHT POLE
- EXIST. ELECTRIC MANHOLE
- EXIST. ELECTRIC HANDHOLE
- EXIST. GAS VALVE
- PROPOSED STONE CHECK DAM
- PROPOSED INLET PROTECTION
- PROPOSED TREE/BRUSH LINE
- EXISTING TREE/BRUSH LINE
- SILT FENCE
- TC:492.9 BC:492.4
- X 492.7
- X 491.5
- ROLLED EROSION CONTROL
- SLOPE PROTECTION

PASSERO
architecture engineering

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Client:
**NORTH GREECE
FIRE DISTRICT**
1766 LATTA ROAD
ROCHESTER, NY 14612

PASSERO ASSOCIATES

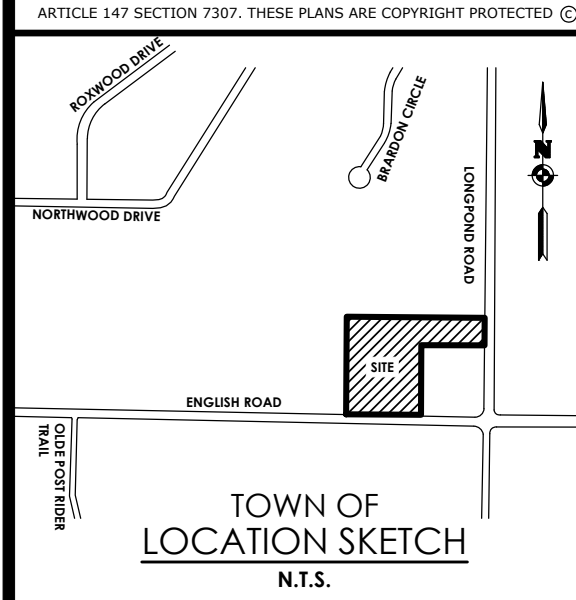242 West Main Street Suite 100
Rochester, New York 14614
(585) 325-1000
Fax: (585) 325-1691
Principal-in-Charge: DAVID COX, PE
Project Manager: ANDREW BURNS, PE
Designed by: JACOB LEWIS



Revisions

No.	Date	By	Description
1			

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**GRADING & EROSION
CONTROL PLAN**
**NORTH GREECE
FIRE DISTRICT**

Town: GREECE
County: MONROE State: NY


Project No.
2023530.0002

Drawing No.
C-105

Scale:
1" = 30'

Date
NOVEMBER 4, 2024

BID SET

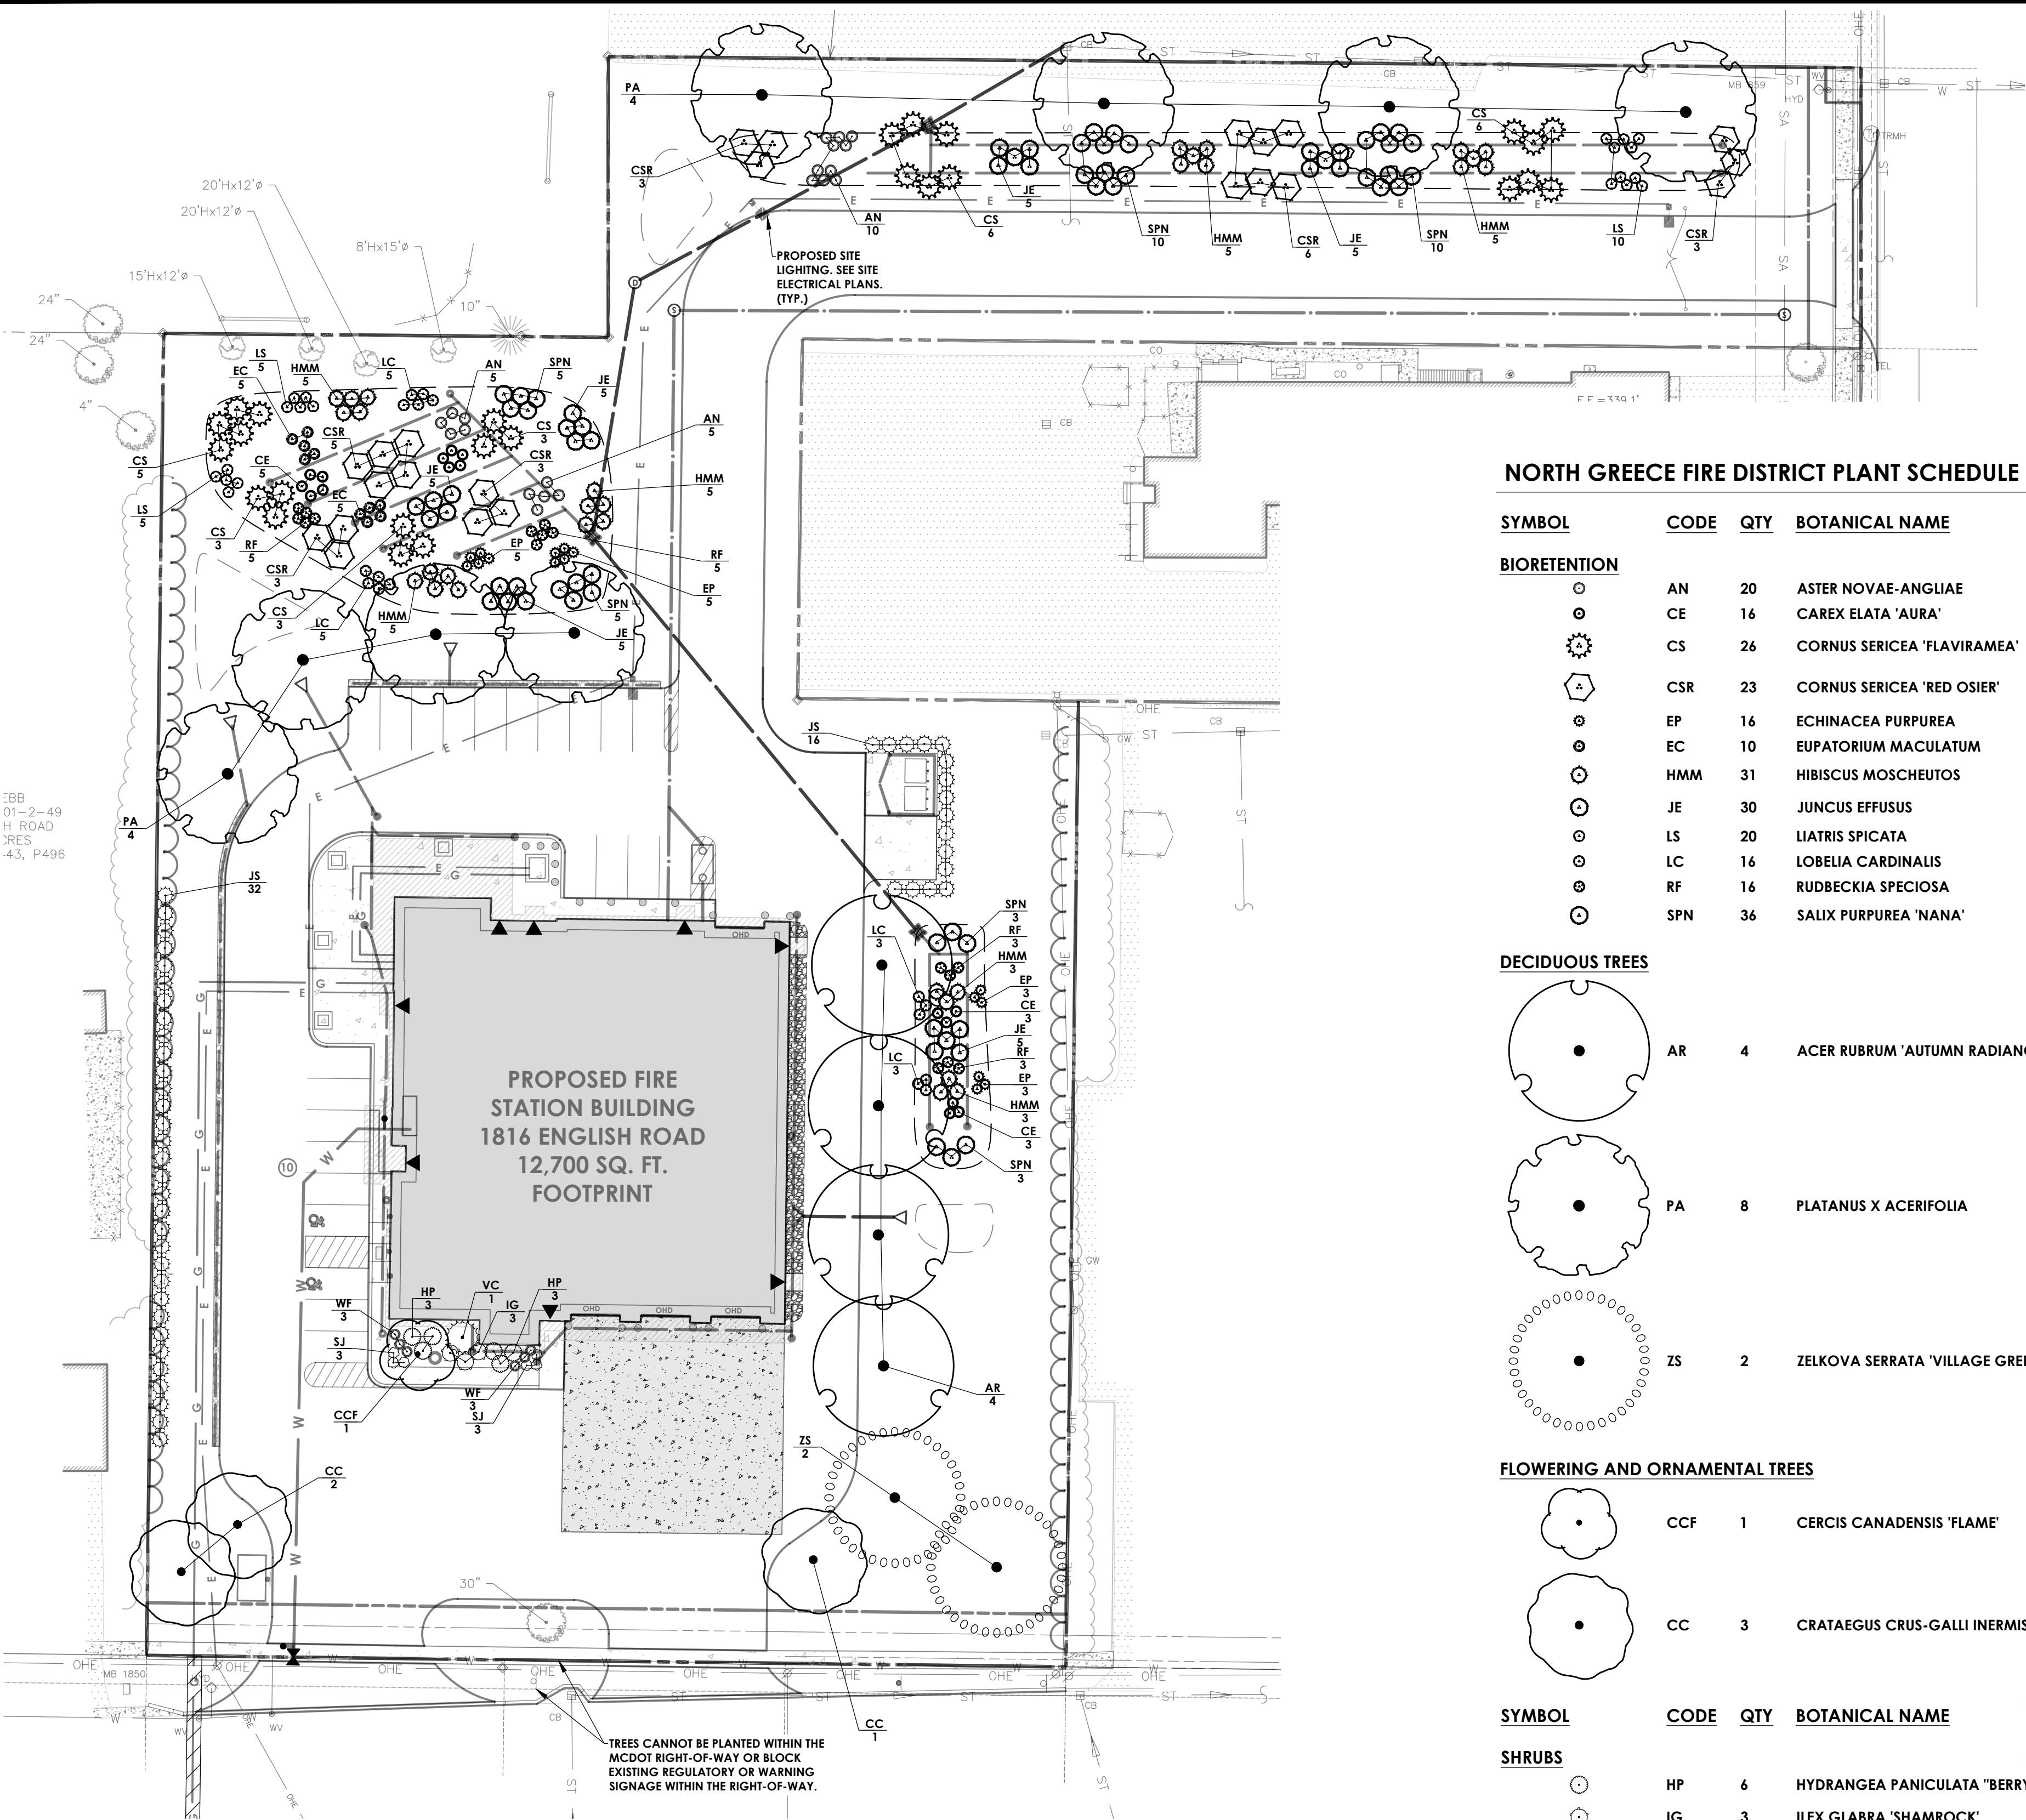

LANDSCAPING NOTES:

- ALL PLANTS SHALL MEET OR EXCEED THE MINIMUM REQUIREMENTS AS NOTED IN THE LATEST EDITION OF THE AMERICAN STANDARD FOR NURSERY STOCK BY AMERICAN NURSERY AND LANDSCAPE ASSOCIATION.
- THE CONTRACTOR SHALL BE RESPONSIBLE FOR HIS OWN QUANTITY TAKEOFF.
- CONTRACTOR SHALL STAKEOUT PLANTINGS FOR OWNER'S APPROVAL PRIOR TO BEGINNING WORK.
- THE CONTRACTOR IS HEREBY NOTIFIED THAT UNDERGROUND UTILITIES EXIST AND HE SHOULD CALL FOR A COMPLETE UTILITY STAKEOUT BEFORE COMMENCING WORK.
- SHOULD LOCATION OF TREES BE WITHIN 5' OF UNDERGROUND UTILITIES, RELOCATE SAID TREES TO MIN. OF 5' FROM BALL TO UTILITIES.
- SHOULD LOCATIONS OF TREES BE WITHIN 20' OF OVERHEAD WIRES, RELOCATE SAID TREES TO MINIMUM OF 20' FROM WIRES.
- PLANTING BACKFILL MIXTURE:
4 PARTS TOPSOIL, 1 PART PEAT MOSS, 10 LBS. 5-0-5 PLANTING FERTILIZER THOROUGHLY MIXED PER CUBIC YARD.
- STAKE TREES IMMEDIATELY AFTER PLANTING.
- PROVIDE BLACK HARD RUBBER EDGING AT ALL PLANTING AREAS.
- ALL SEEDED AREAS SHALL RECEIVE 10:0:10 COMMERCIAL FERTILIZER APPLIED AT A RATE OF 20LBS./1000 S.F. NO FERTILIZER CONTAINING PHOSPHORUS IS PERMITTED ON SITE.
- ALL NEWLY SEEDED AREA SHALL RECEIVE STRAW AT A RATE OF 2000 LBS/ACRE OR HYDROSEED METHOD MAY BE UTILIZED.
- FINE GRADE & HAND RAKE SOIL IN AREAS TO RECEIVE NEW SEED
- ALL AREAS TO BE SEEDED SHALL RECEIVE 6" DEPTH OF TOPSOIL.
- ANY PROPOSED DEVIATION TO THIS PLAN MUST FIRST BE REVIEWED AND APPROVED BY THE PLANNING BOARD AND TOWN ENGINEER, PRIOR TO THE INSTALLATION OF THOSE PROPOSED LANDSCAPE CHANGES.

MCDOT NOTES:

- TREES CANNOT BE PLANTED WITHIN THE MCDOT RIGHT-OF-WAY.
- TREES CANNOT BLOCK EXISTING REGULATORY OR WARNING SIGNAGE WITHIN THE MCDOT RIGHT-OF-WAY.

NORTH GREECE FIRE DISTRICT PLANT SCHEDULE

SYMBOL	CODE	QTY	BOTANICAL NAME	COMMON NAME	SIZE	ROOT	MATURE HT	SPACING	REMARKS
BIORETENTION									
	AN	20	ASTER NOVAE-ANGLIAE	NEW ENGLAND ASTER	10-12"	1 QT	3-4'	1.5-2'	BIORETENTION AREAS
	CE	16	CAREX ELATA 'AURA'	BOWLES GOLDEN SEDGE	10-12"	1 QT	1.5-2.5'	1.5-2.5'	BIORETENTION AREAS
	CS	26	CORNUS SERICEA 'FLAVIRAMEA'	YELLOW TWIG DOGWOOD	18-24"	B.R.	6-8'	6-8'	BIORETENTION AREAS
	CSR	23	CORNUS SERICEA 'RED OSIER'	RED OSIER DOGWOOD	18-24"	B.R.	5-6'	5-6'	BIORETENTION AREAS
	EP	16	ECHINACEA PURPUREA	PURPLE CONEFLOWER	10-12"	1 QT	2.5-3'	1.5-2'	BIORETENTION AREAS
	EC	10	EUPATORIUM MACULATUM	SPOTTED JOE-PYE WEED	---	1 QT	1-2'	1.5-2'	BIORETENTION AREAS
	HMM	31	HIBISCUS MOSCHEUTOS	MARCH MALLOW	2-3'	#2 CONT.	3-6'	2-4'	BIORETENTION AREAS
	JE	30	JUNCUS EFFUSUS	COMMON SOFT RUSH	12-15"	#2 CONT.	2-4'	2-4'	BIORETENTION AREAS
	LS	20	LIATRIS SPICATA	BLAZING STAR	10-12"	1 QT	2-4'	1-1.5'	BIORETENTION AREAS
	LC	16	LOBELIA CARDINALIS	CARDINAL FLOWER	---	1 QT	2-3'	1.5-2'	BIORETENTION AREAS
	RF	16	RUDBECKIA SPECIOSA	BLACK-EYED SUSAN	---	1 QT	2'	1.5-2'	BIORETENTION AREAS
	SPN	36	SALIX PURPUREA 'NANA'	PURPLE WILLOW	2-3'	#2 CONT.	3-5'	3-5'	BIORETENTION AREAS

DECIDUOUS TREES

	AR	4	ACER RUBRUM 'AUTUMN RADIANCE'	AUTUMN RADIANCE RED MAPLE	3-3-1/2"	B&B	35-40'	AS SHOWN	FALL PLANTING HAZARD
	PA	8	PLATANUS X ACERIFOLIA	LONDON PLANE TREE	3-3-1/2"	B&B	75' H.	AS SHOWN	FALL PLANTING HAZARD
	ZS	2	ZELKOVA SERRATA 'VILLAGE GREEN'	VILLAGE GREEN JAPANESE ZELKOVA	3-3-1/2"	B&B	50-65'	AS SHOWN	FALL PLANTING HAZARD

FLOWERING AND ORNAMENTAL TREES

	CCF	1	CERCIS CANADENSIS 'FLAME'	FLAME EASTERN REDBUD	1-3/4-2"	B&B	20-25'	AS SHOWN	FALL PLANTING HAZARD - TREE FROM
	CC	3	CRATAEGUS CRUS-GALLI INERMIS	THORNLESS COCKSPUR HAWTHORN	2-2-1/2"	B&B	20-25'	AS SHOWN	FALL PLANTING HAZARD - TREE FROM


SYMBOL	CODE	QTY	BOTANICAL NAME	COMMON NAME	SIZE	ROOT	MATURE HT	SPACING	REMARKS
SHRUBS									
	HP	6	HYDRANGEA PANICULATA 'BERRY WHITE'	BERRY WHITE HYDRANGEA	3-4'	B&B	6-7'	5' OC	
	IG	3	ILEX GLABRA 'SHAMROCK'	SHAMROCK HOLLY	24-30" H	#3 CONT.	3-4'	3-4' OC	EVERGREEN - 1 MALE/5 FEMALE
	JS	48	JUNIPERUS CHINENSIS 'SPARTAN'	SPARTAN JUNIPER	7-8' H	B&B	10-15'	5' OC	SCREENING
	SJ	6	SPIRAEA CHINENSIS 'SPARTAN'	SPARTAN JUNIPER	24-30" H	#3 CONT.	3'	3-4' OC	
	VC	1	VIBURNUM CARLESII	KOREAN SPICE VIBURNUM	3-4' H	#10 CONT.	8'	5-6' OC	
	WF	6	WEIGELA FLORIDA 'DARK HORSE'	DARK HORSE WEIGELA	24-30" H	#3 CONT.	3'	3-4' OC	

BIORETENTION SEED MIX *


11,964 SF ERNST SEED - BIORETENTION BASIN MIX ERNMX-126 (1.0 LBS/1,000 SF) BIORETENTION AREAS

LANDSCAPING CONTRACT NOTES:

- LANDSCAPING PLANT PROCUREMENT AND INSTALLATIONS BY OTHERS.
- SITE CONTRACTOR TO ESTABLISH FINAL SITE GRADE AND PROVIDE TOPSOIL PER SPECIFICATIONS.
- SITE CONTRACTOR TO STABILIZE AND ESTABLISH GRASS IN ALL DISTURBED AREAS.

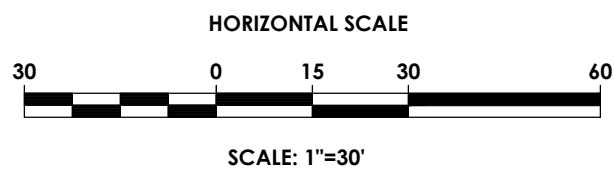

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Client:
NORTH GREECE
FIRE DISTRICT
1766 LATTA ROAD
ROCHESTER, NY 14612

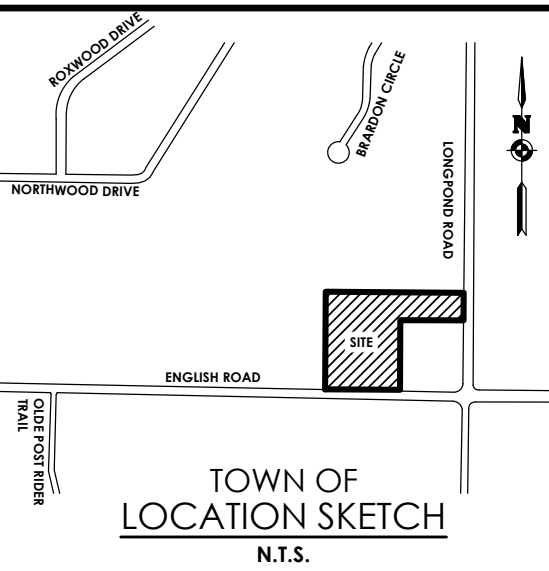PASSERO ASSOCIATES

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Rochester, New York 14614
(585) 325-1000
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Revisions

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LANDSCAPING
& LIGHTING PLAN
NORTH GREECE
FIRE DISTRICT

Town: GREECE
County: MONROE State: NY

Project No.
20233530.0002


















Drawing No.

C-106

Scale:
1" = 30'

Date
NOVEMBER 4, 2024

BID SET

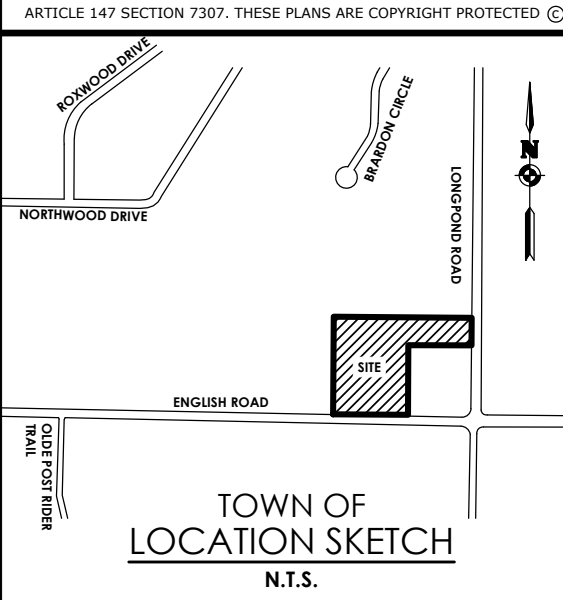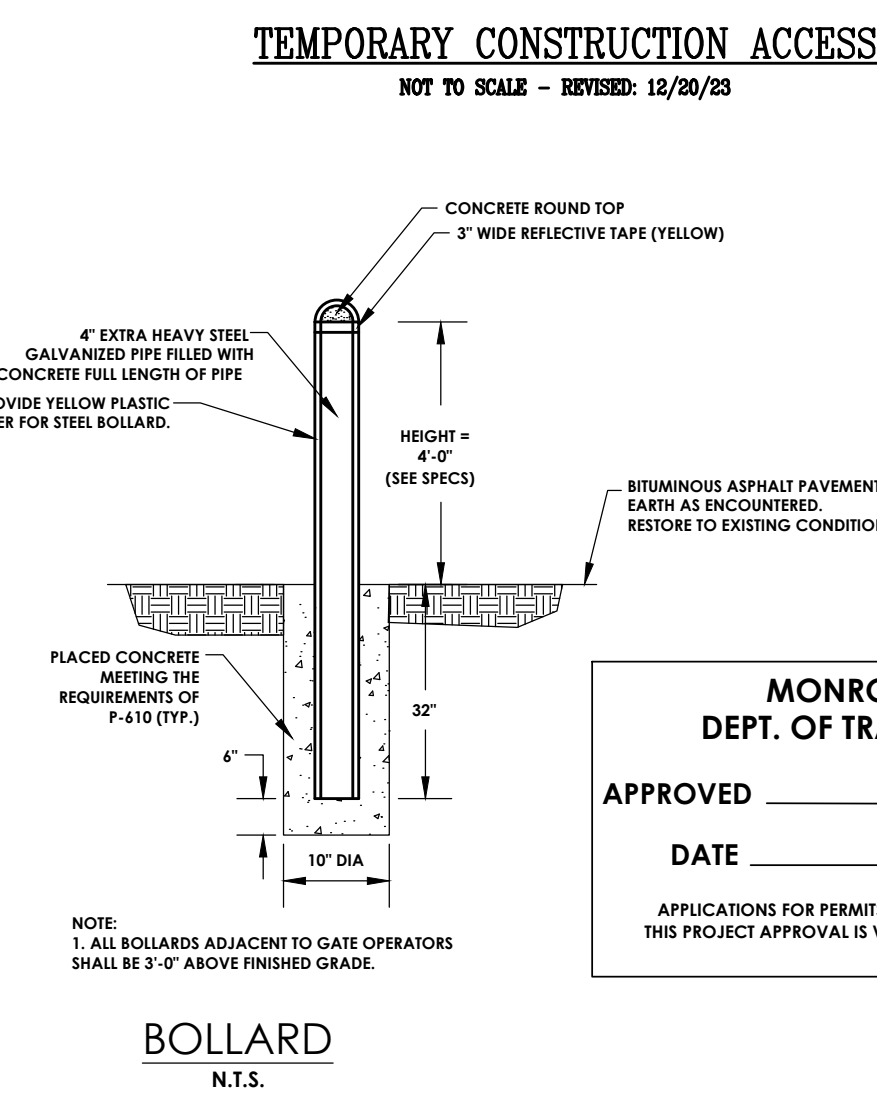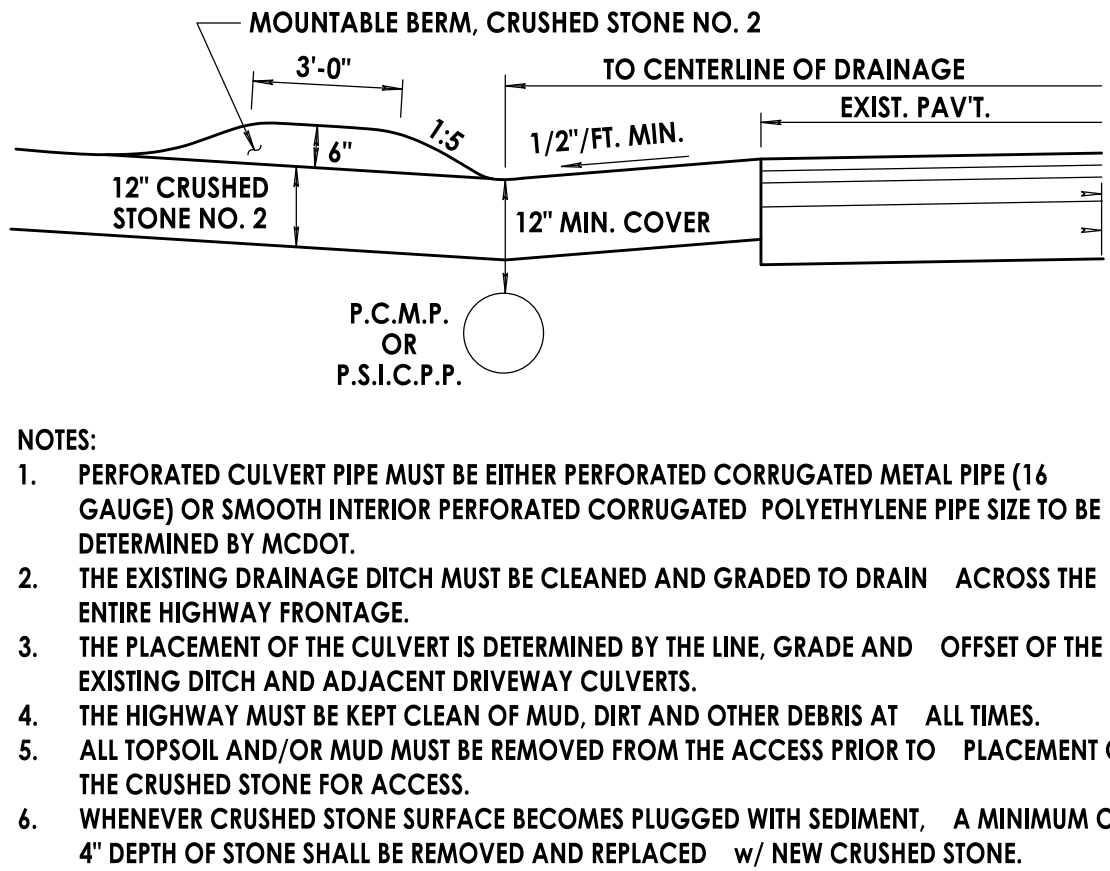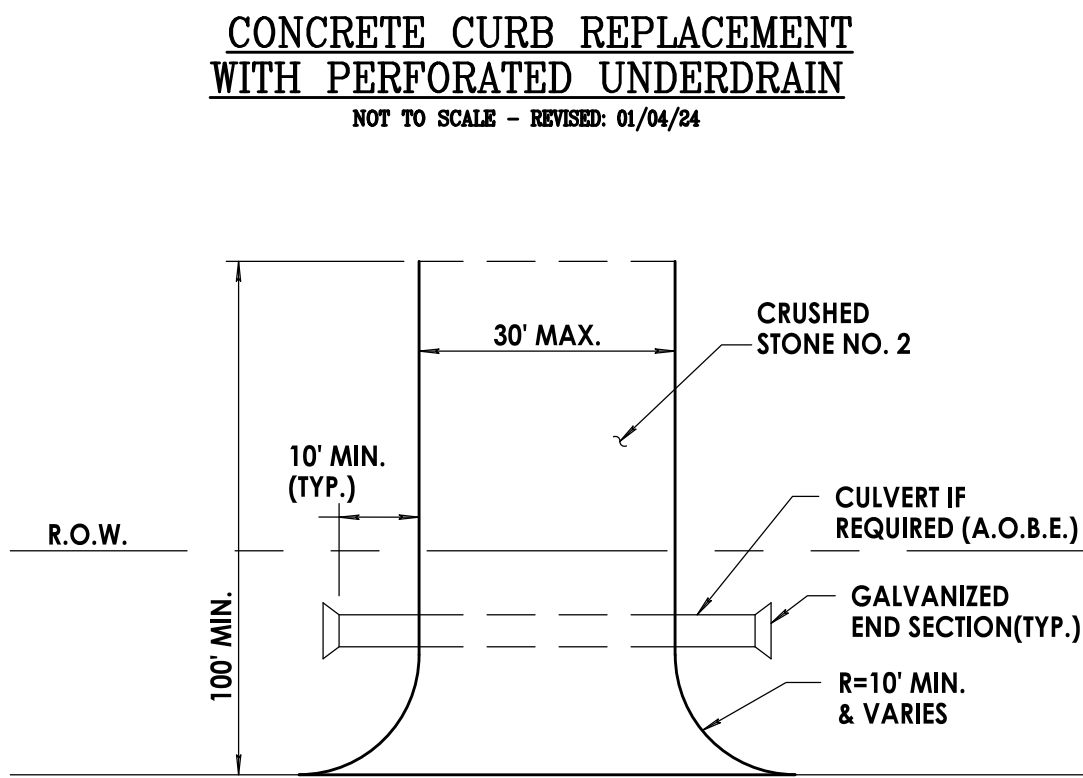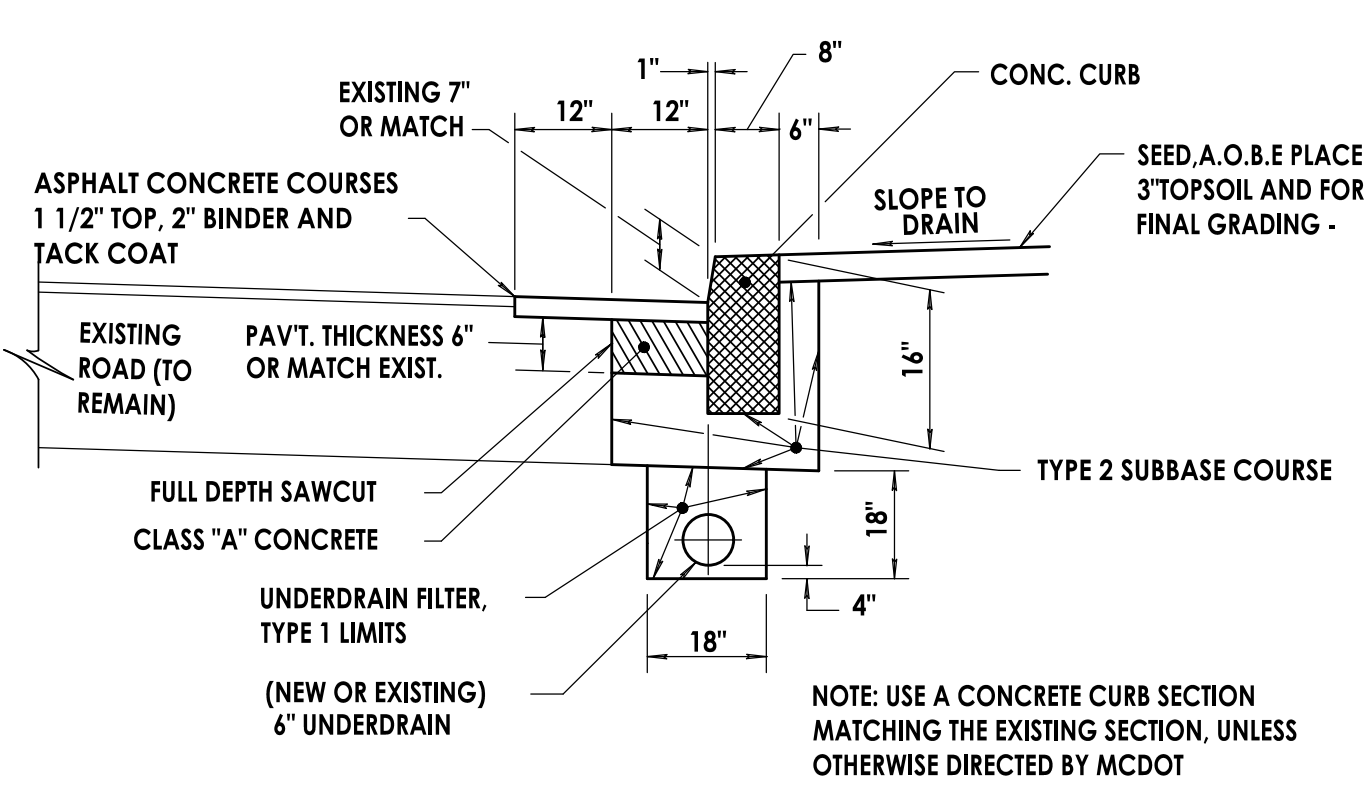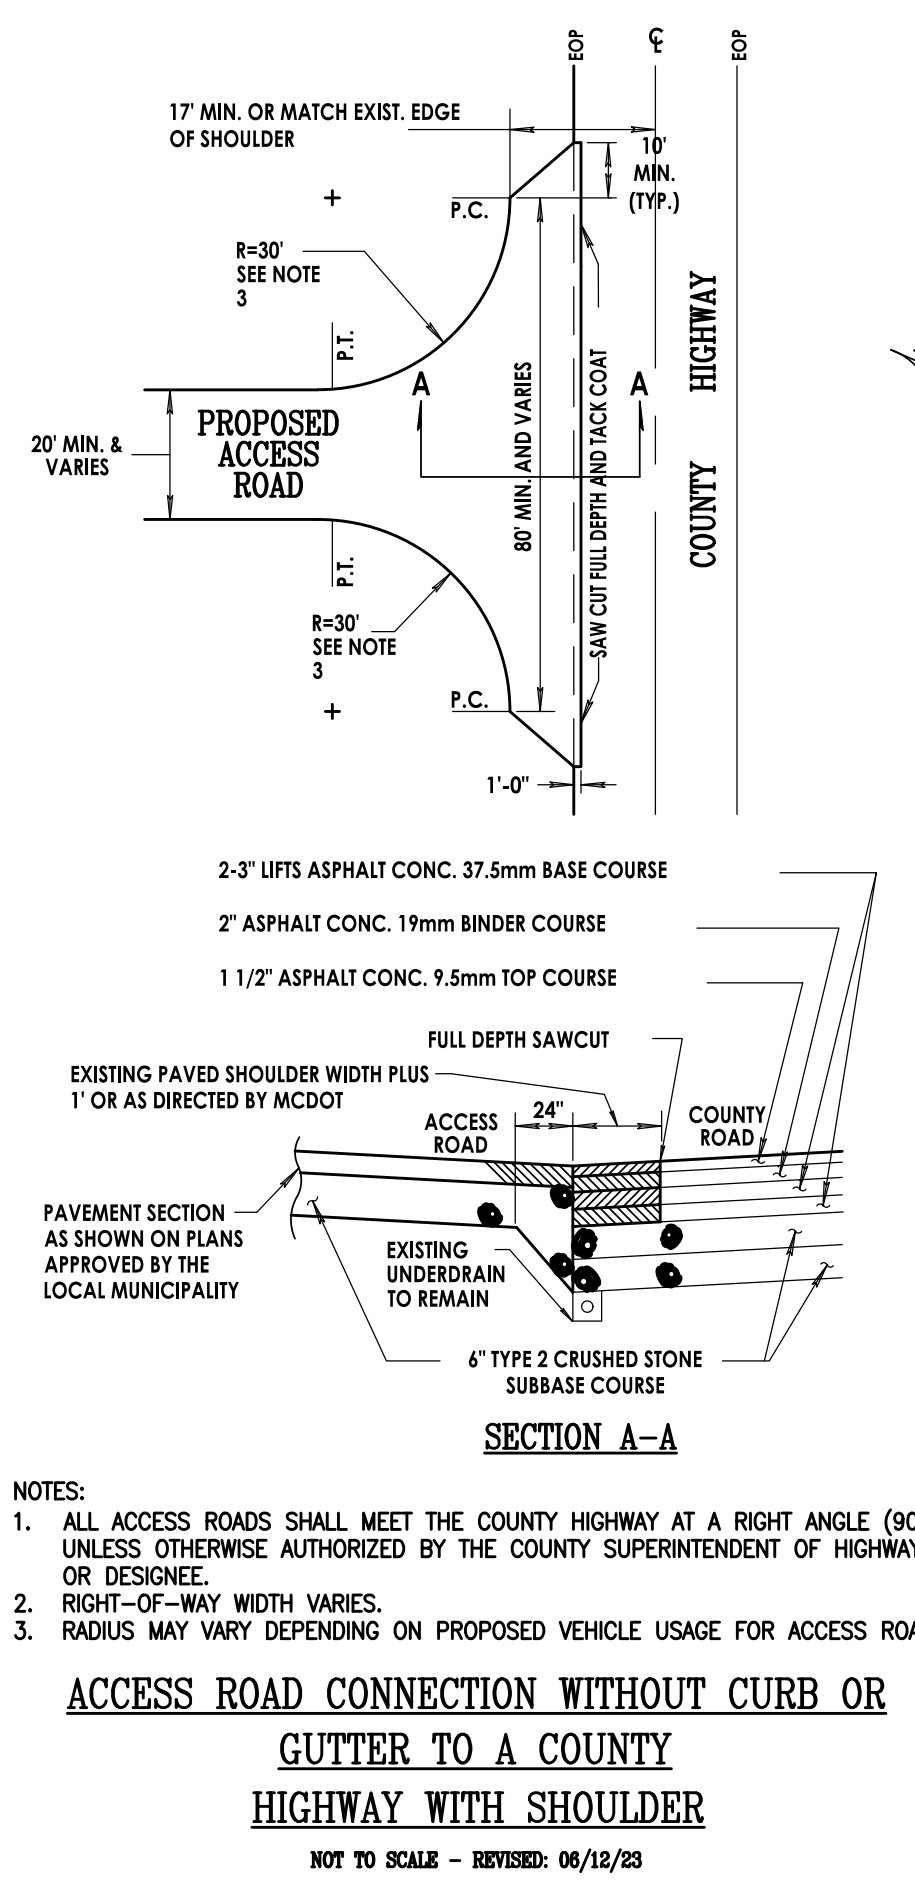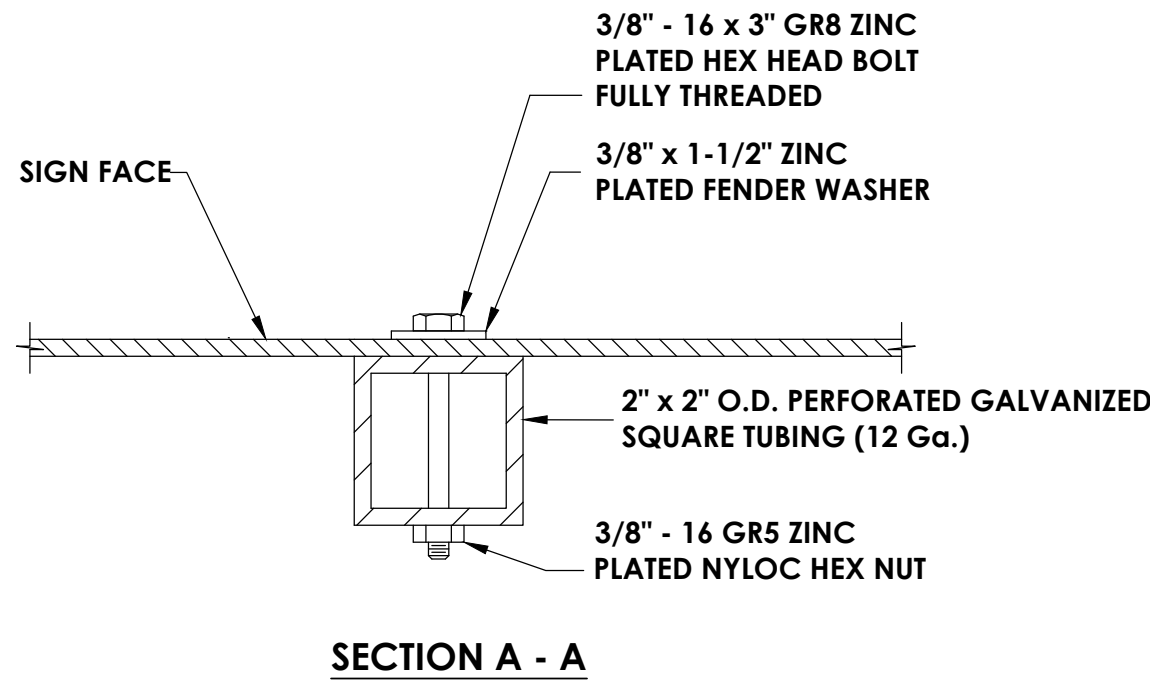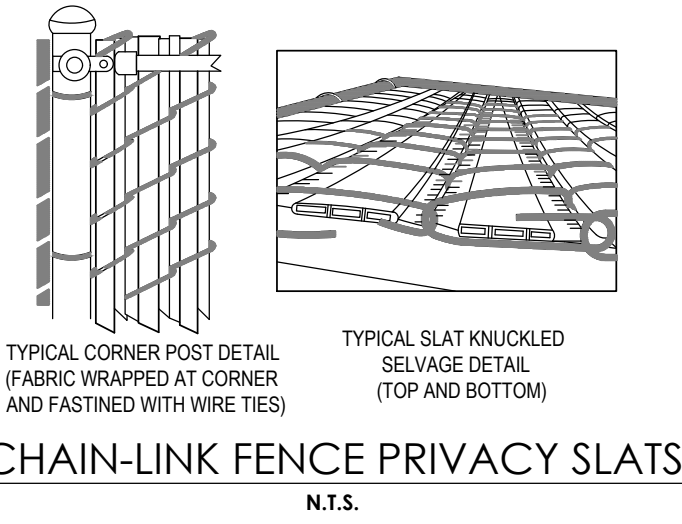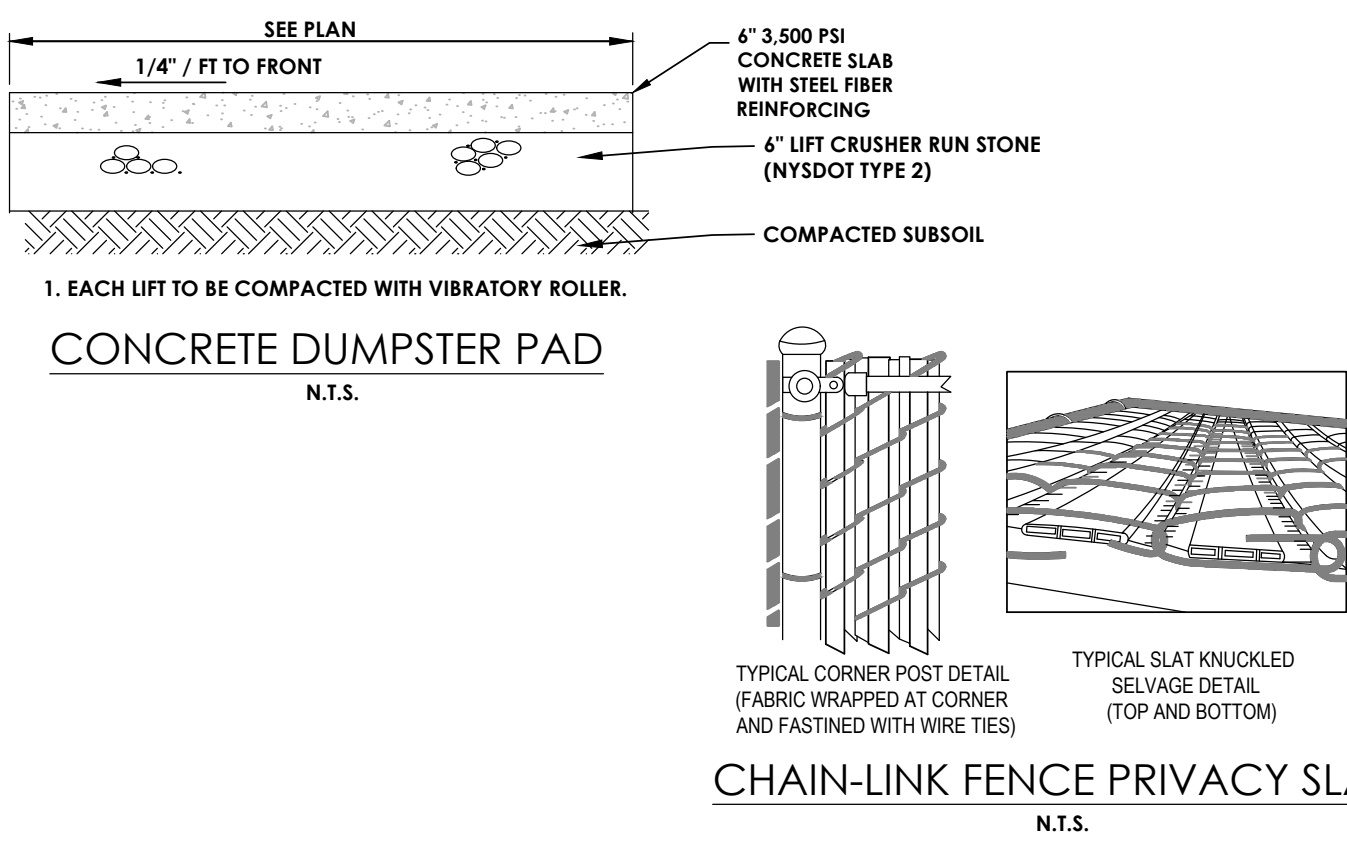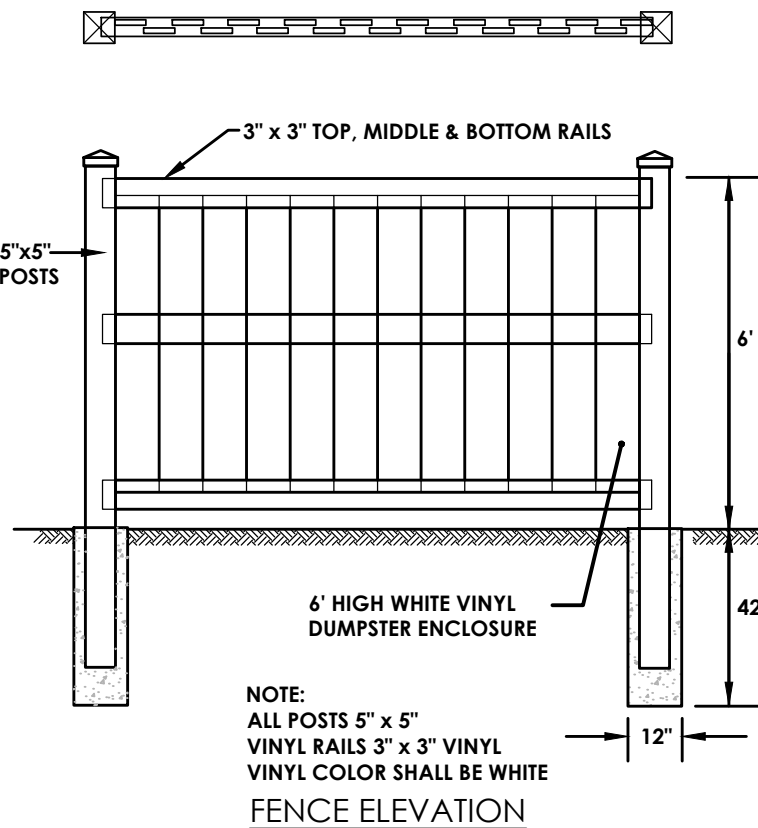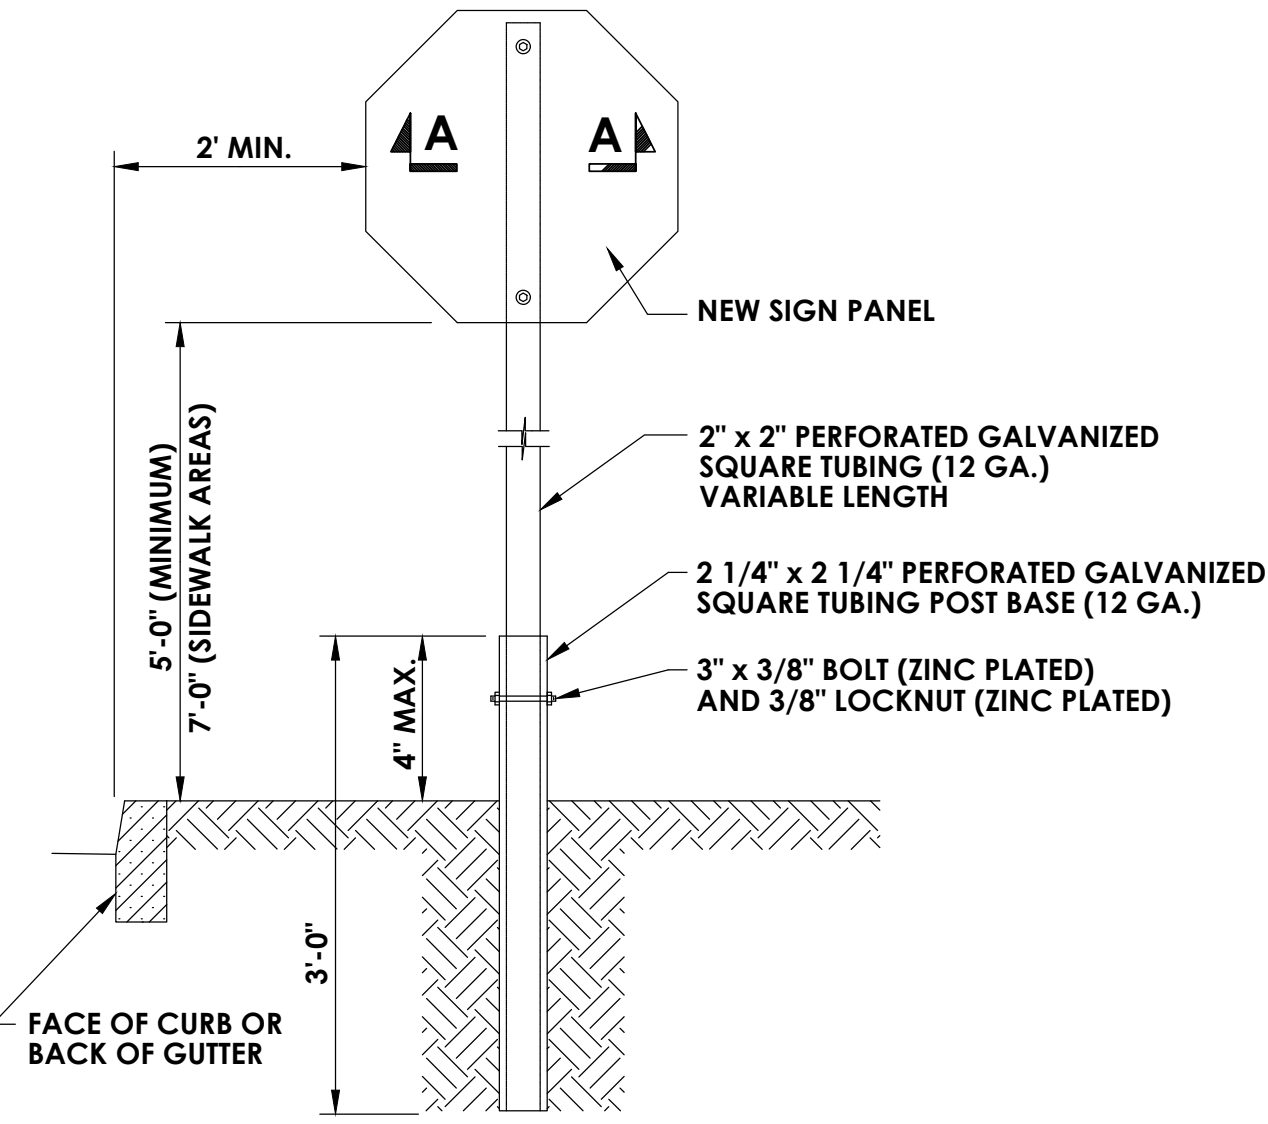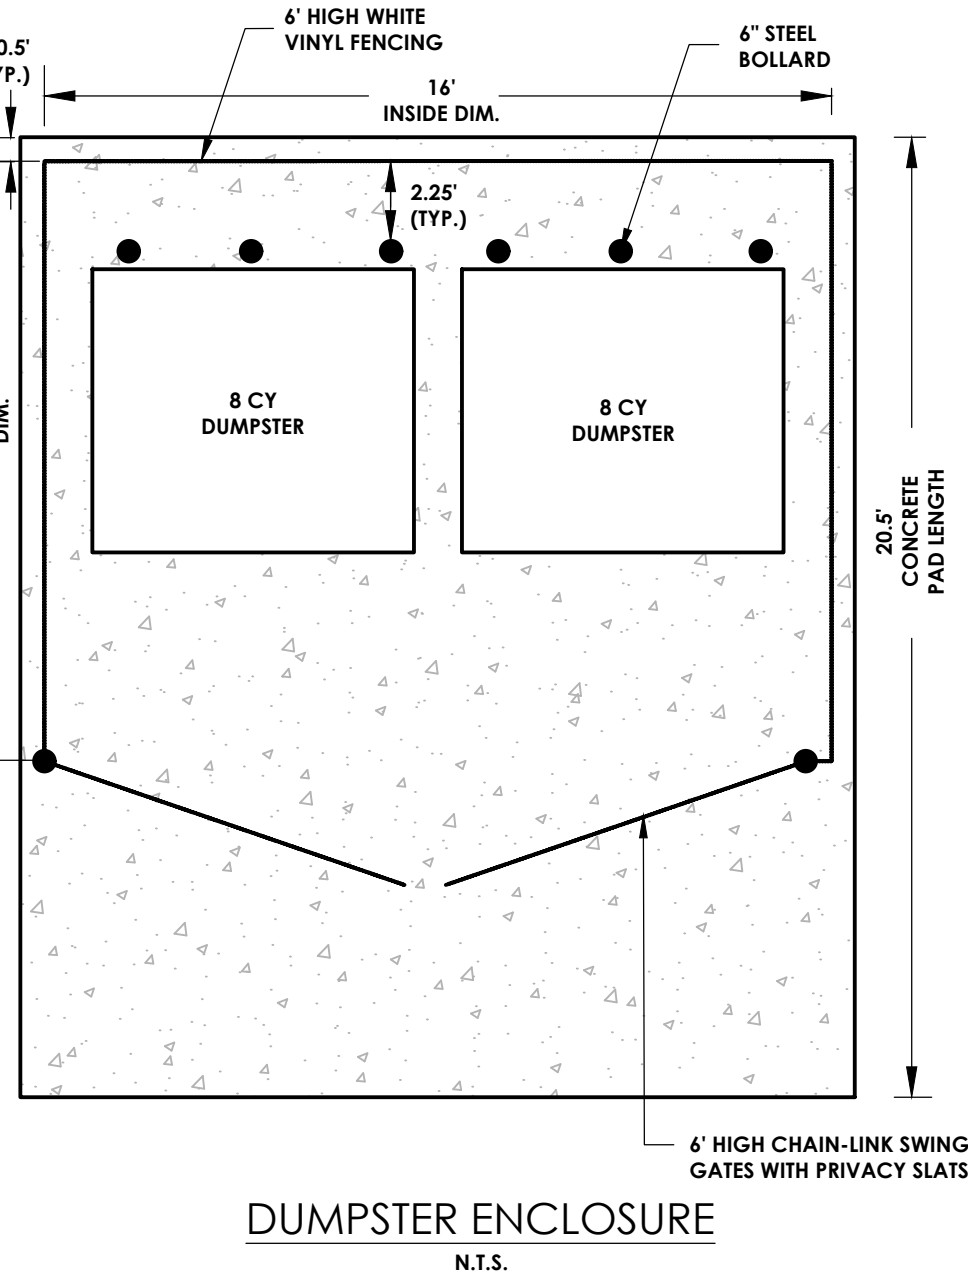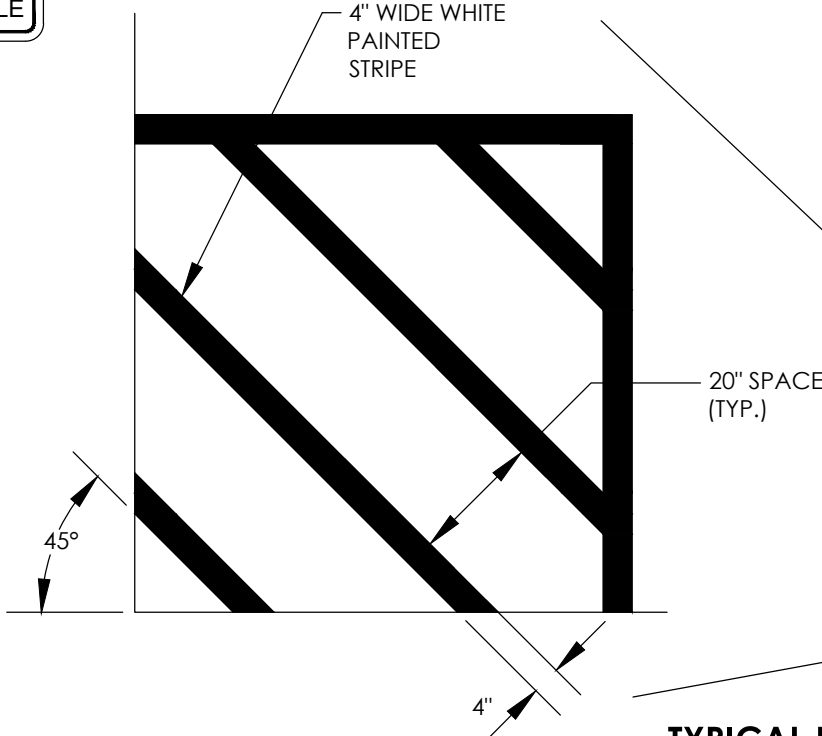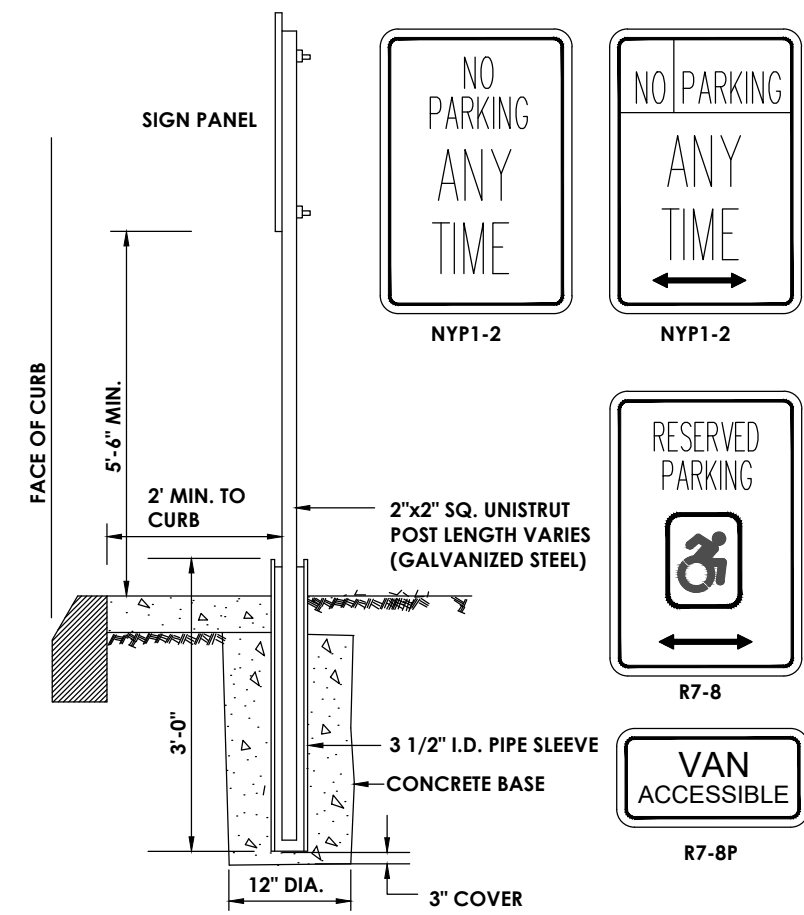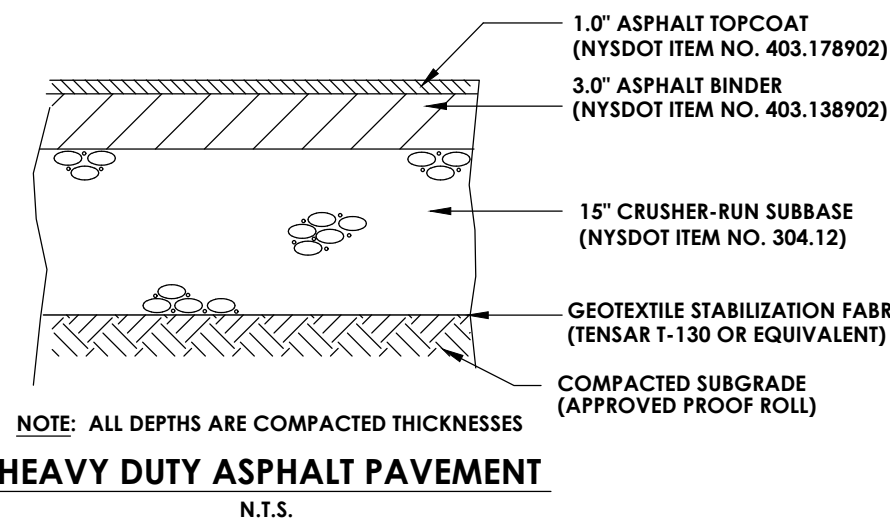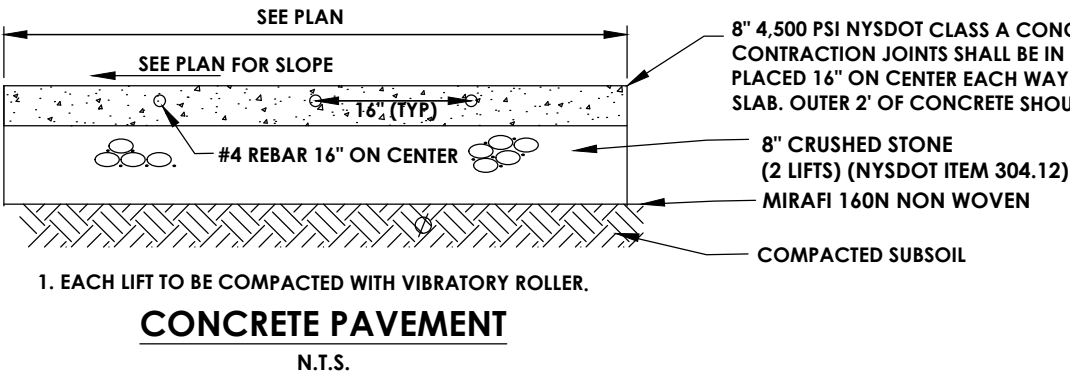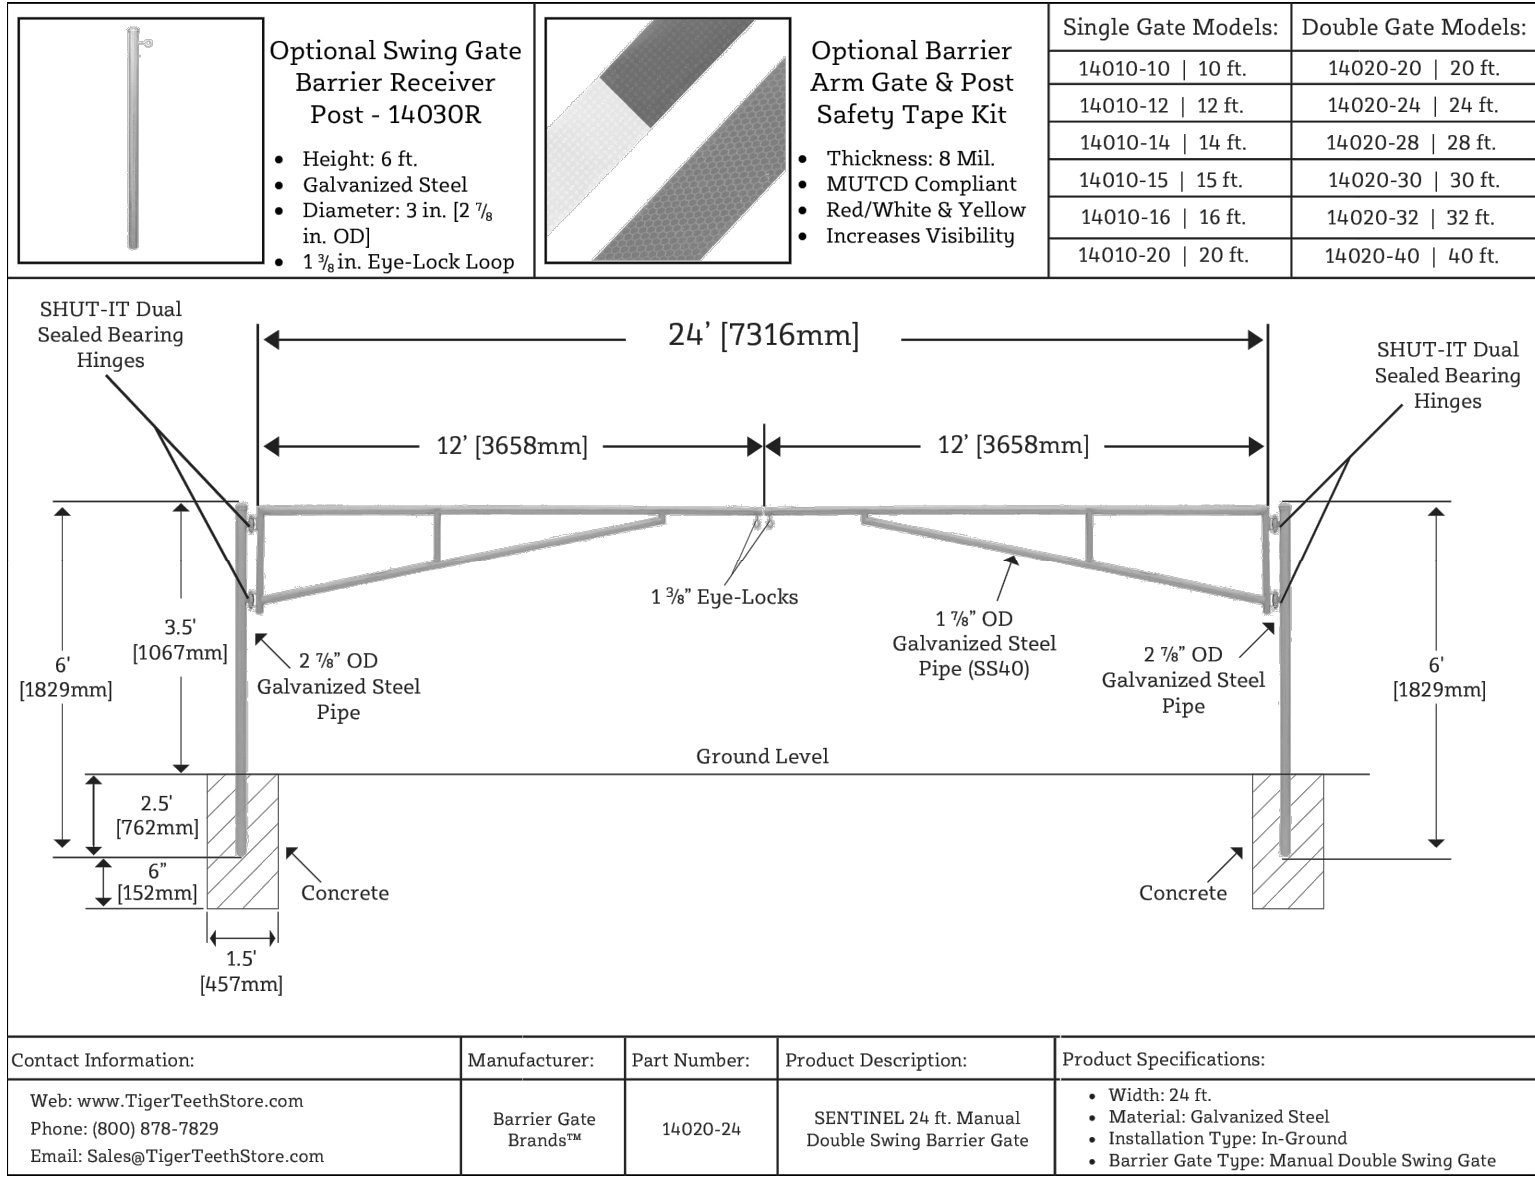

Client:
NORTH GREECE FIRE DISTRICT
1766 LATTA ROAD
ROCHESTER, NY 14612














PASSERO ASSOCIATES
242 West Main Street Suite 100
Rochester, New York 14614
Principal-in-Charge: DAVID COX, PE
Project Manager: ANDREW BURNS, PE
Designed by: JACOB LEWIS



Revisions			
No.	Date	By	Description
1			

DETAILS
NORTH GREECE FIRE DISTRICT
County: MONROE State: NY
Project No.: **20233530.0002**
Drawing No.: **C-202**
Scale: **N.T.S.**
Date: **NOVEMBER 4, 2024**

BID SET

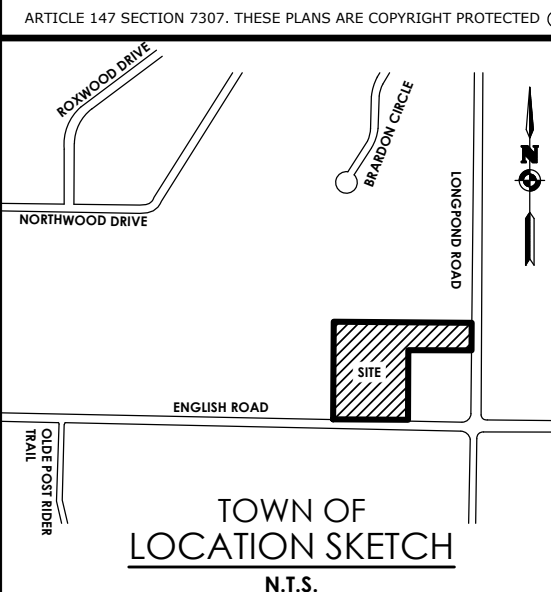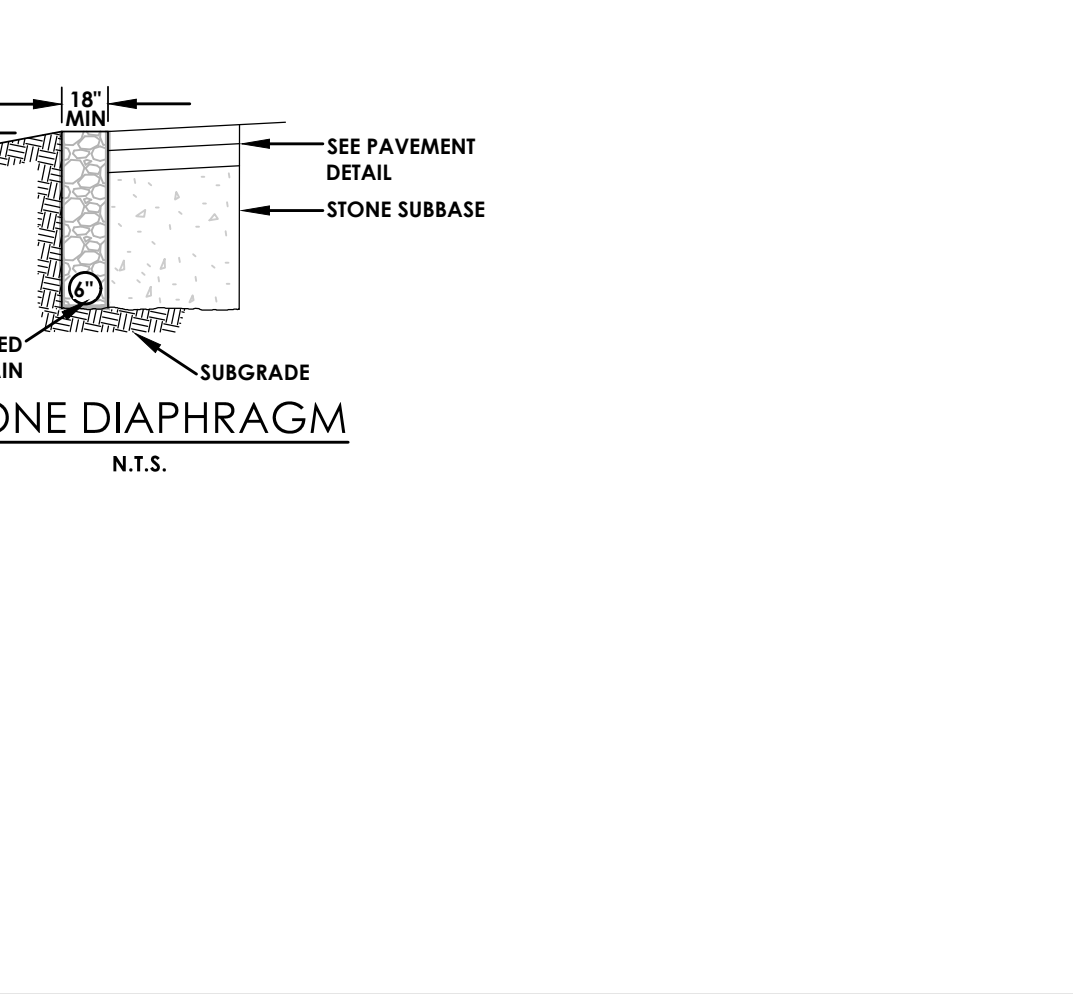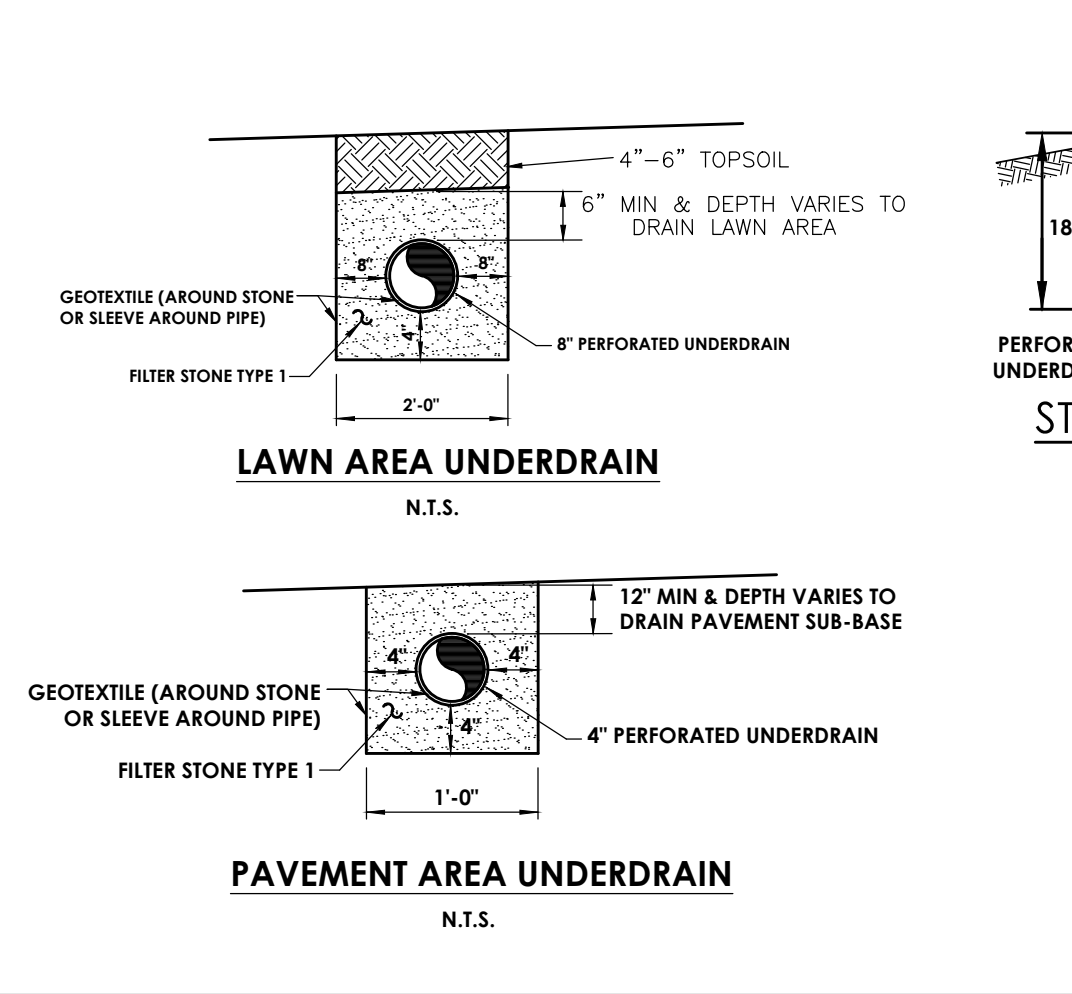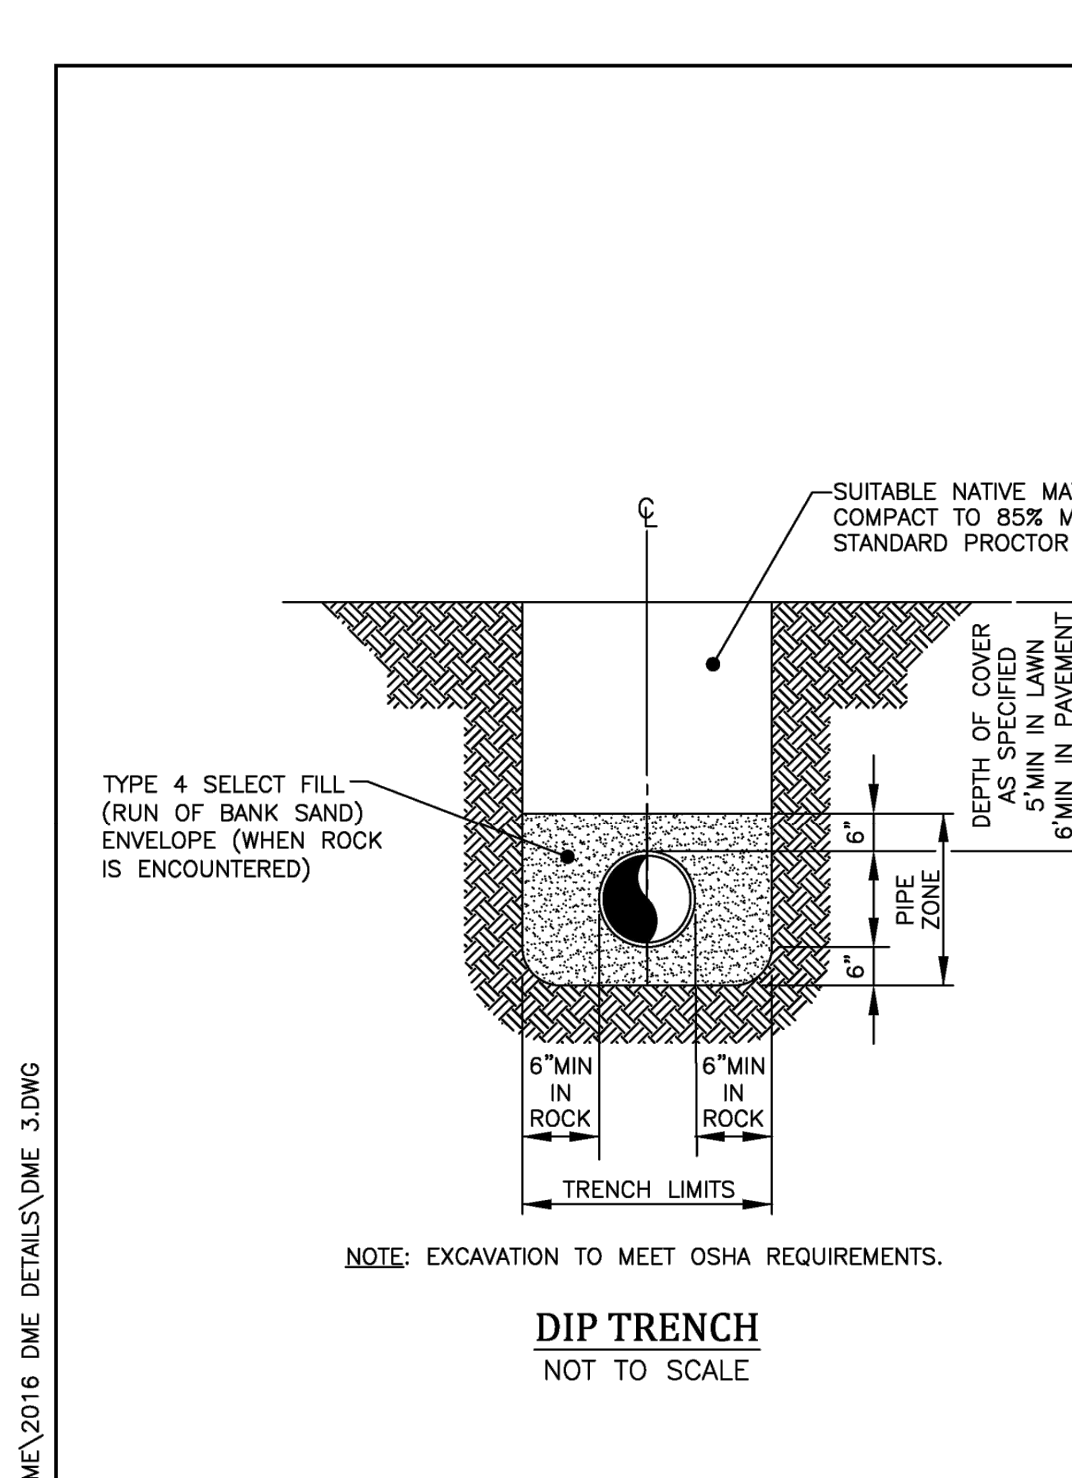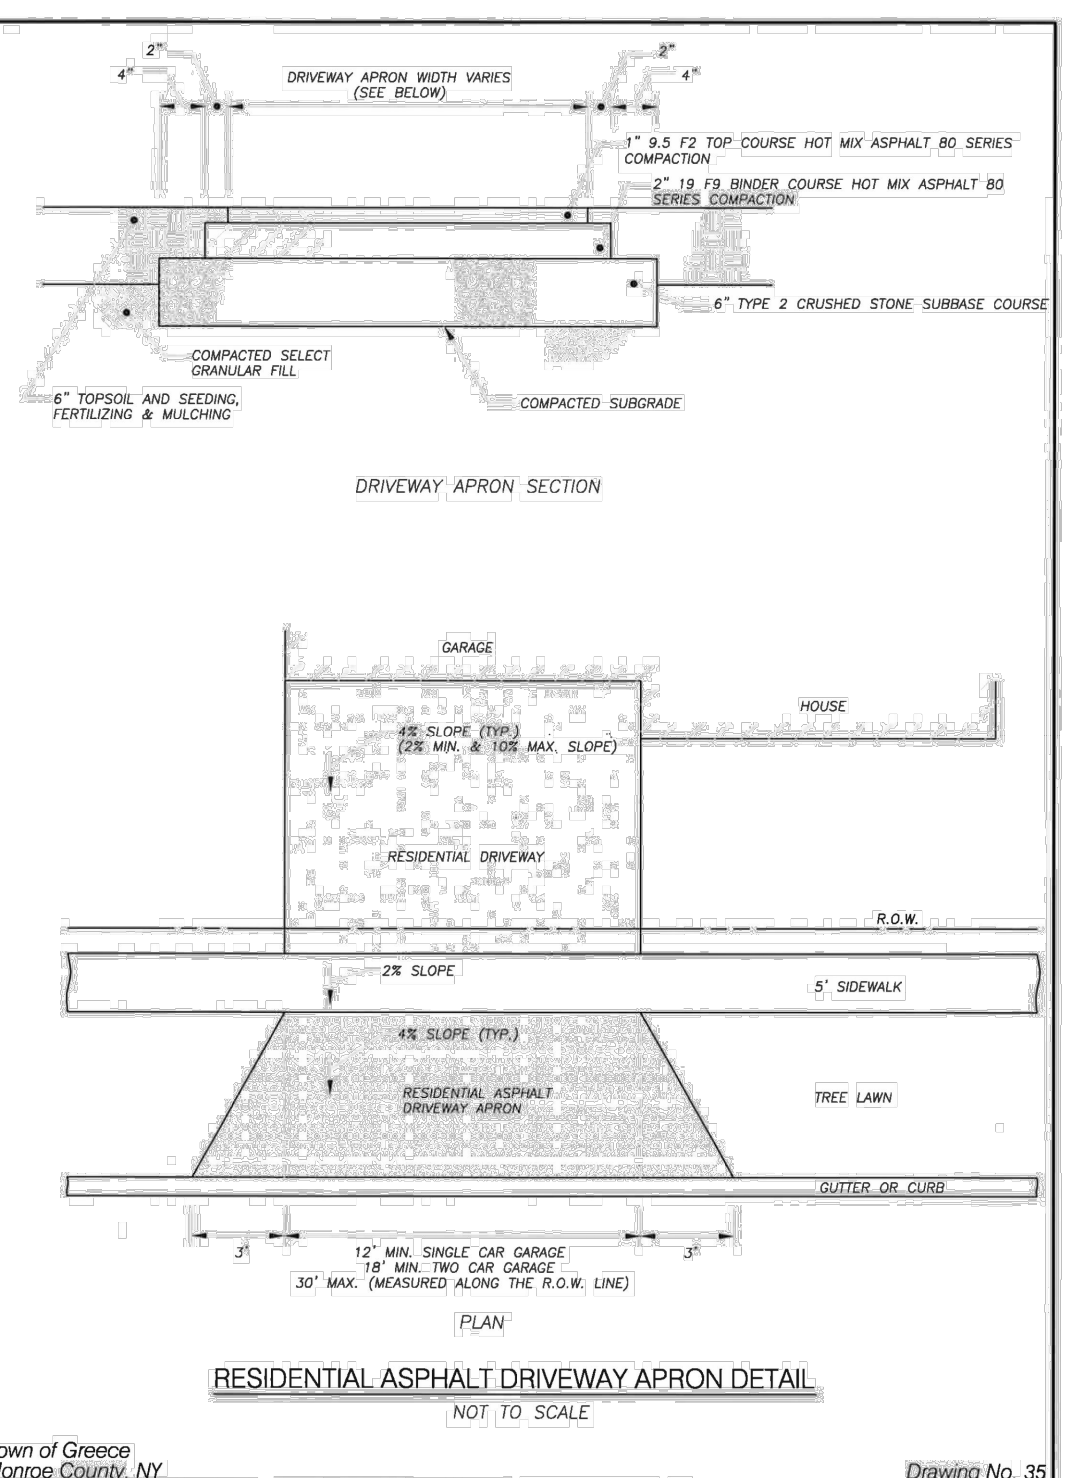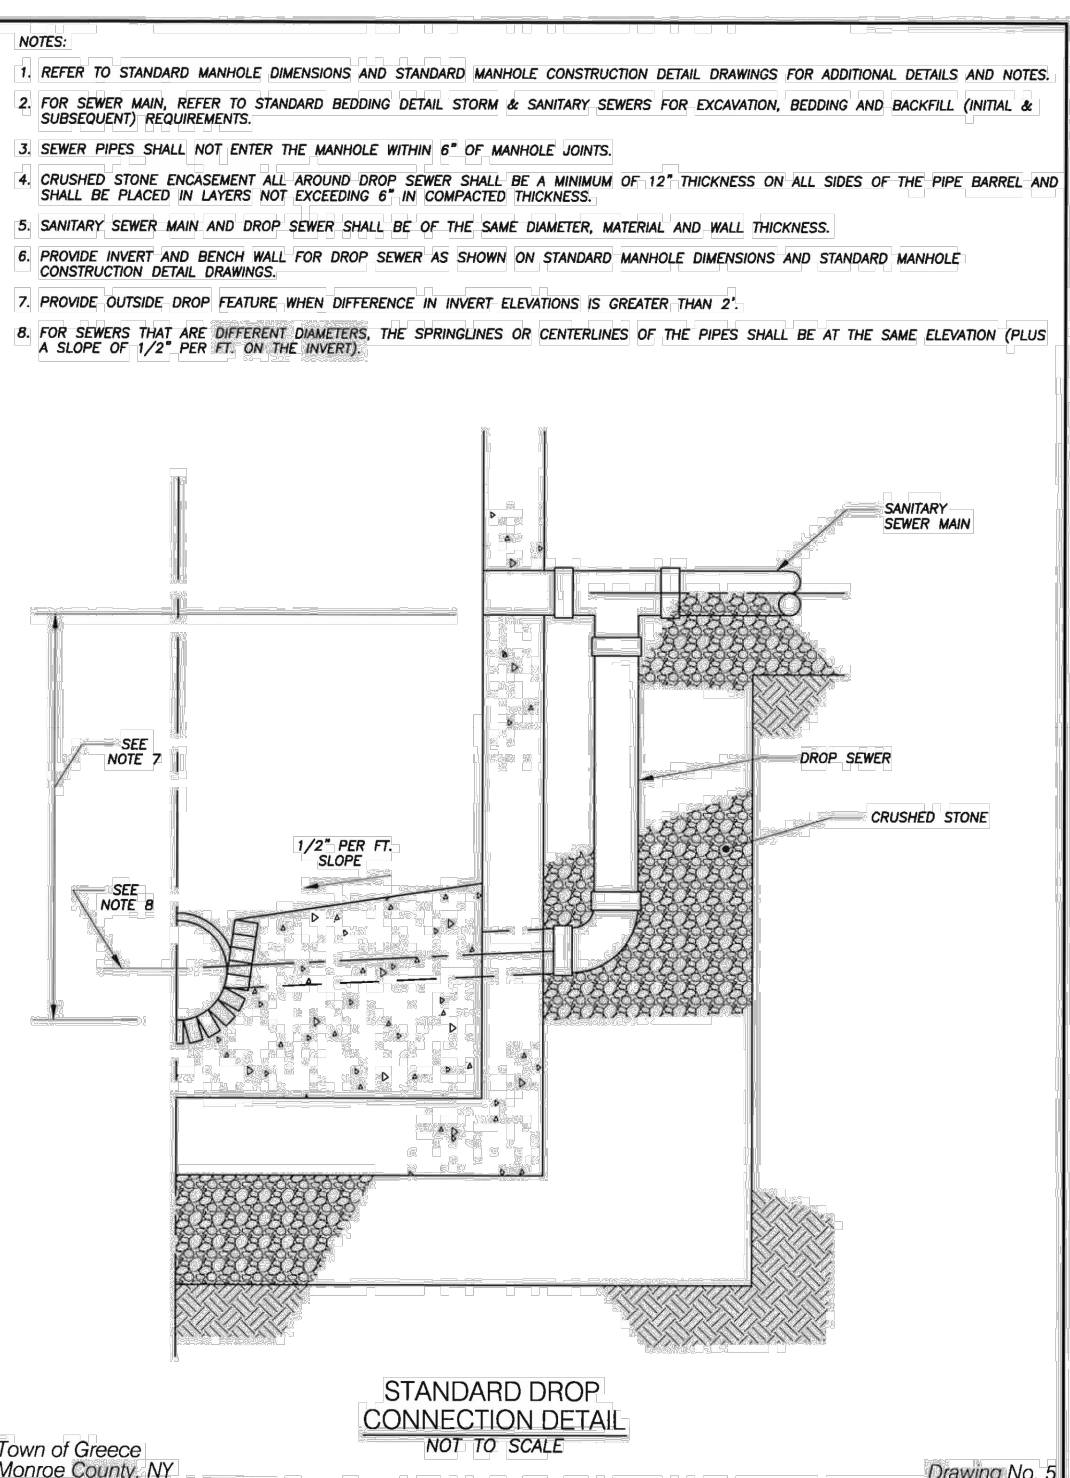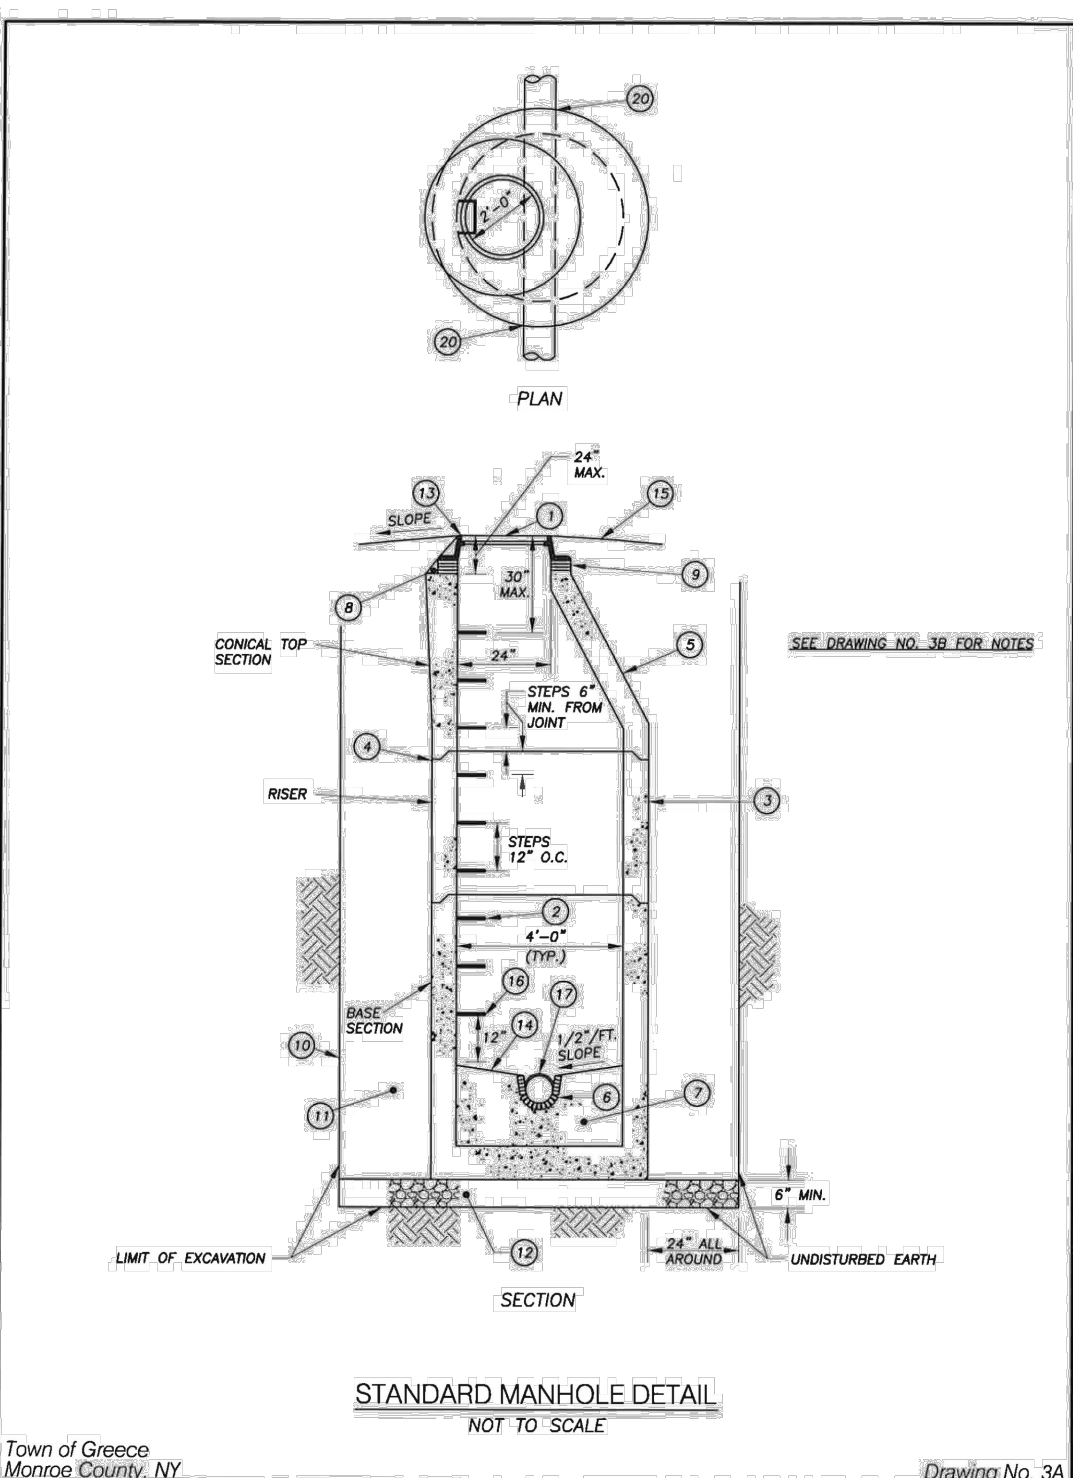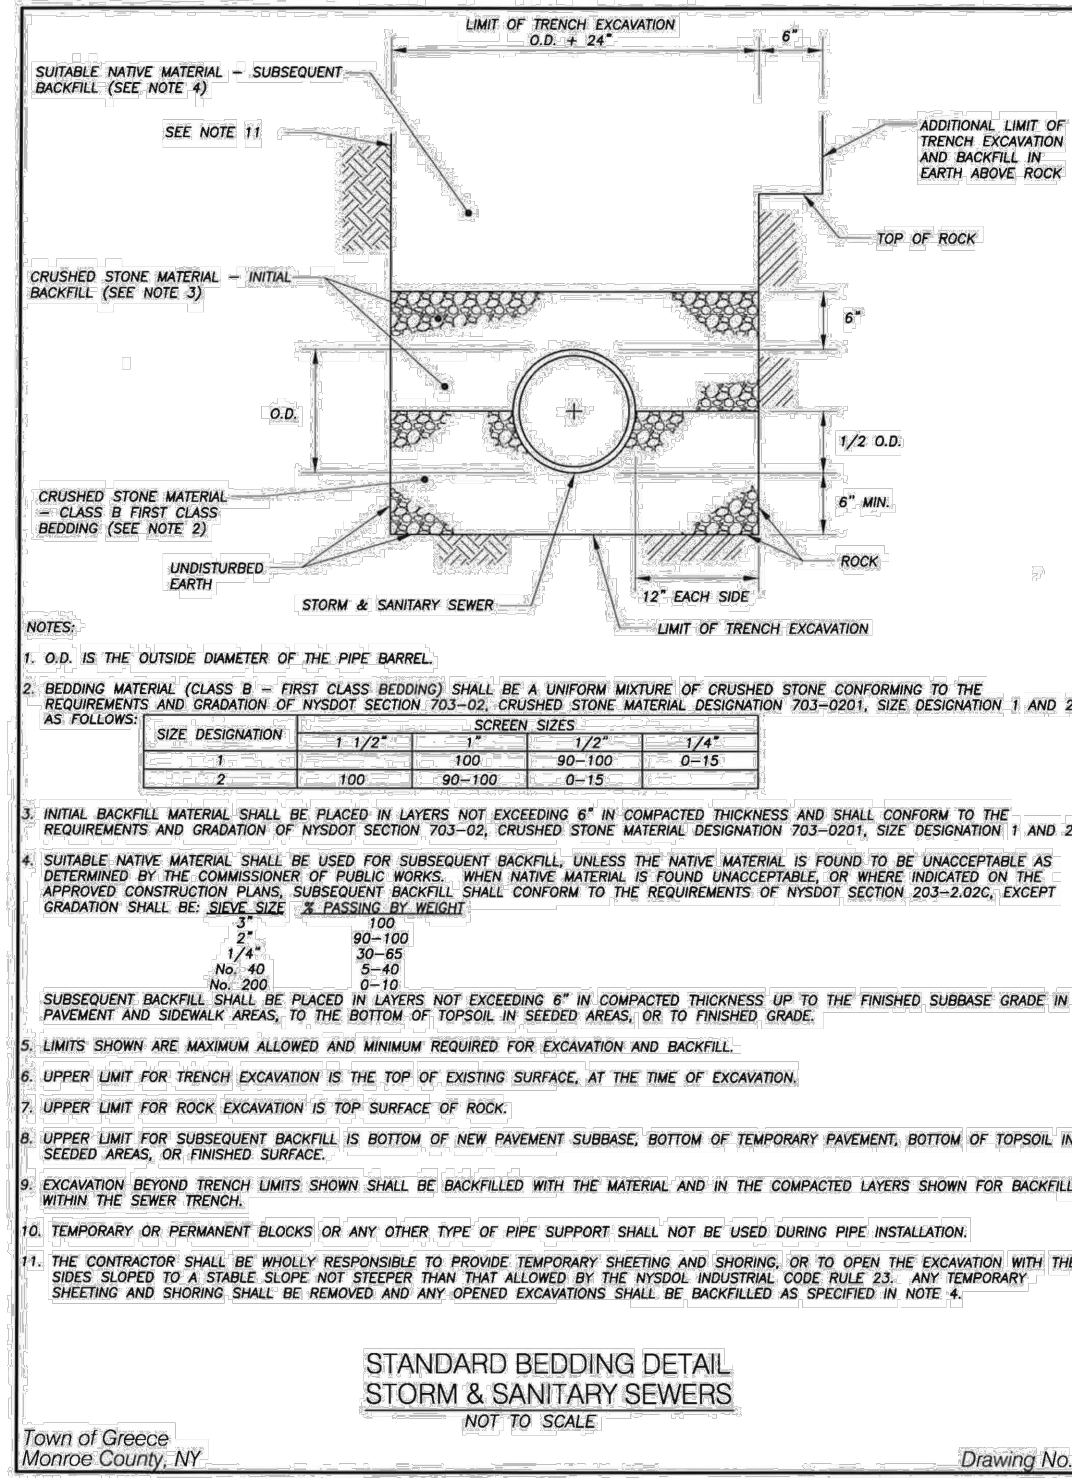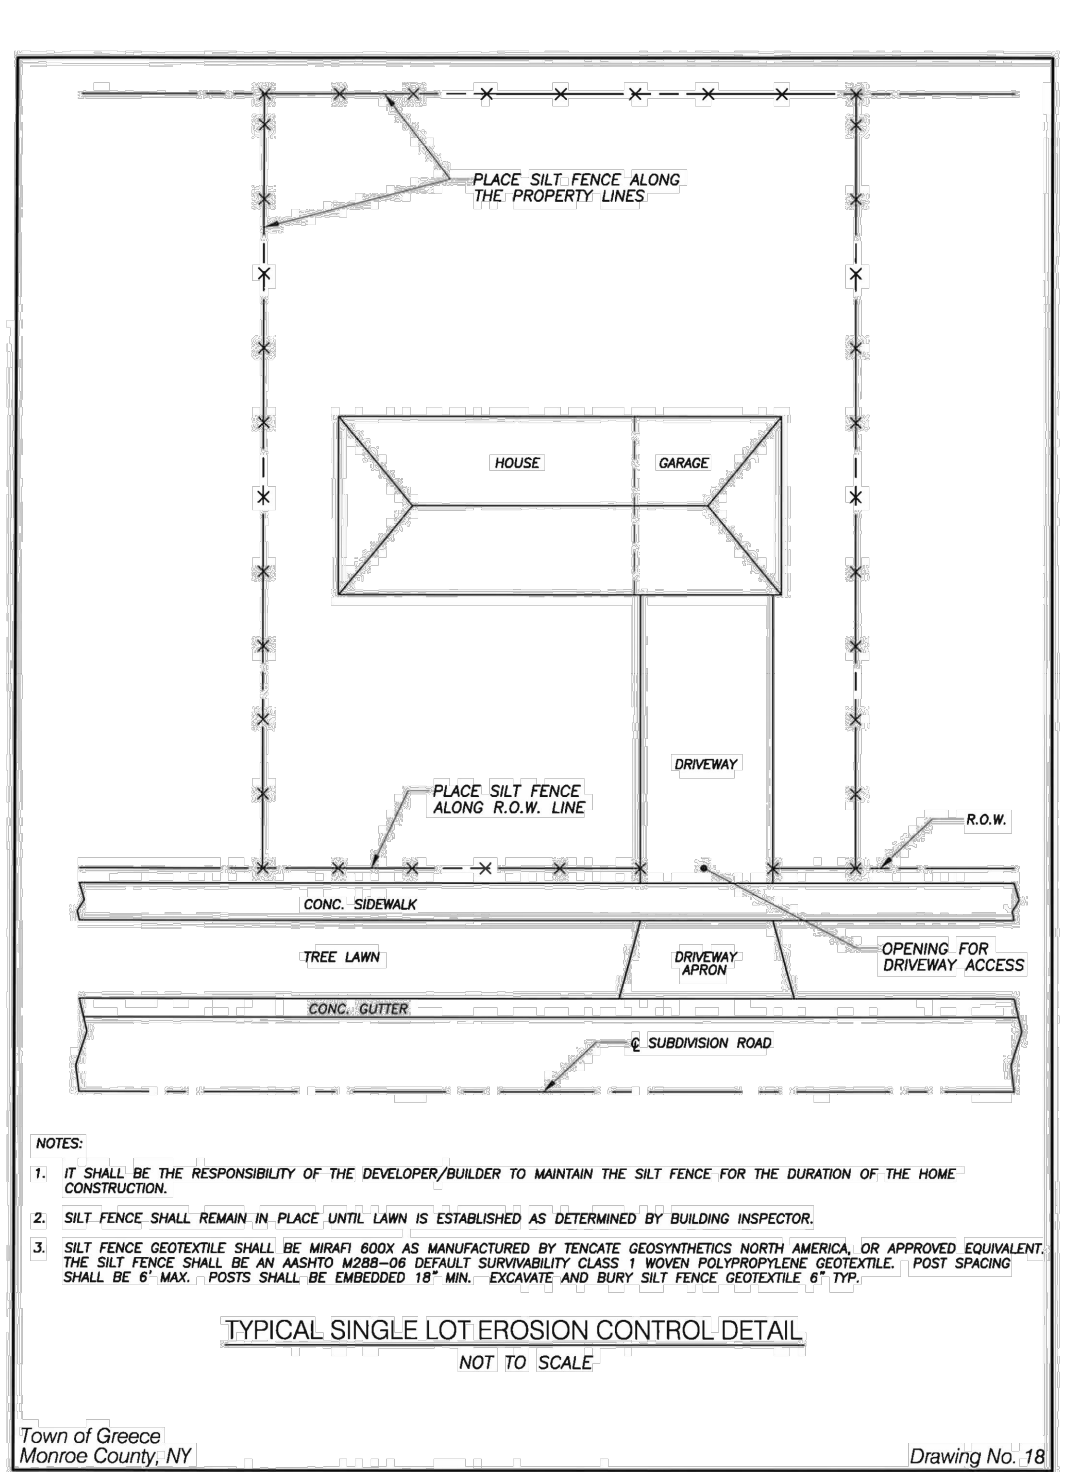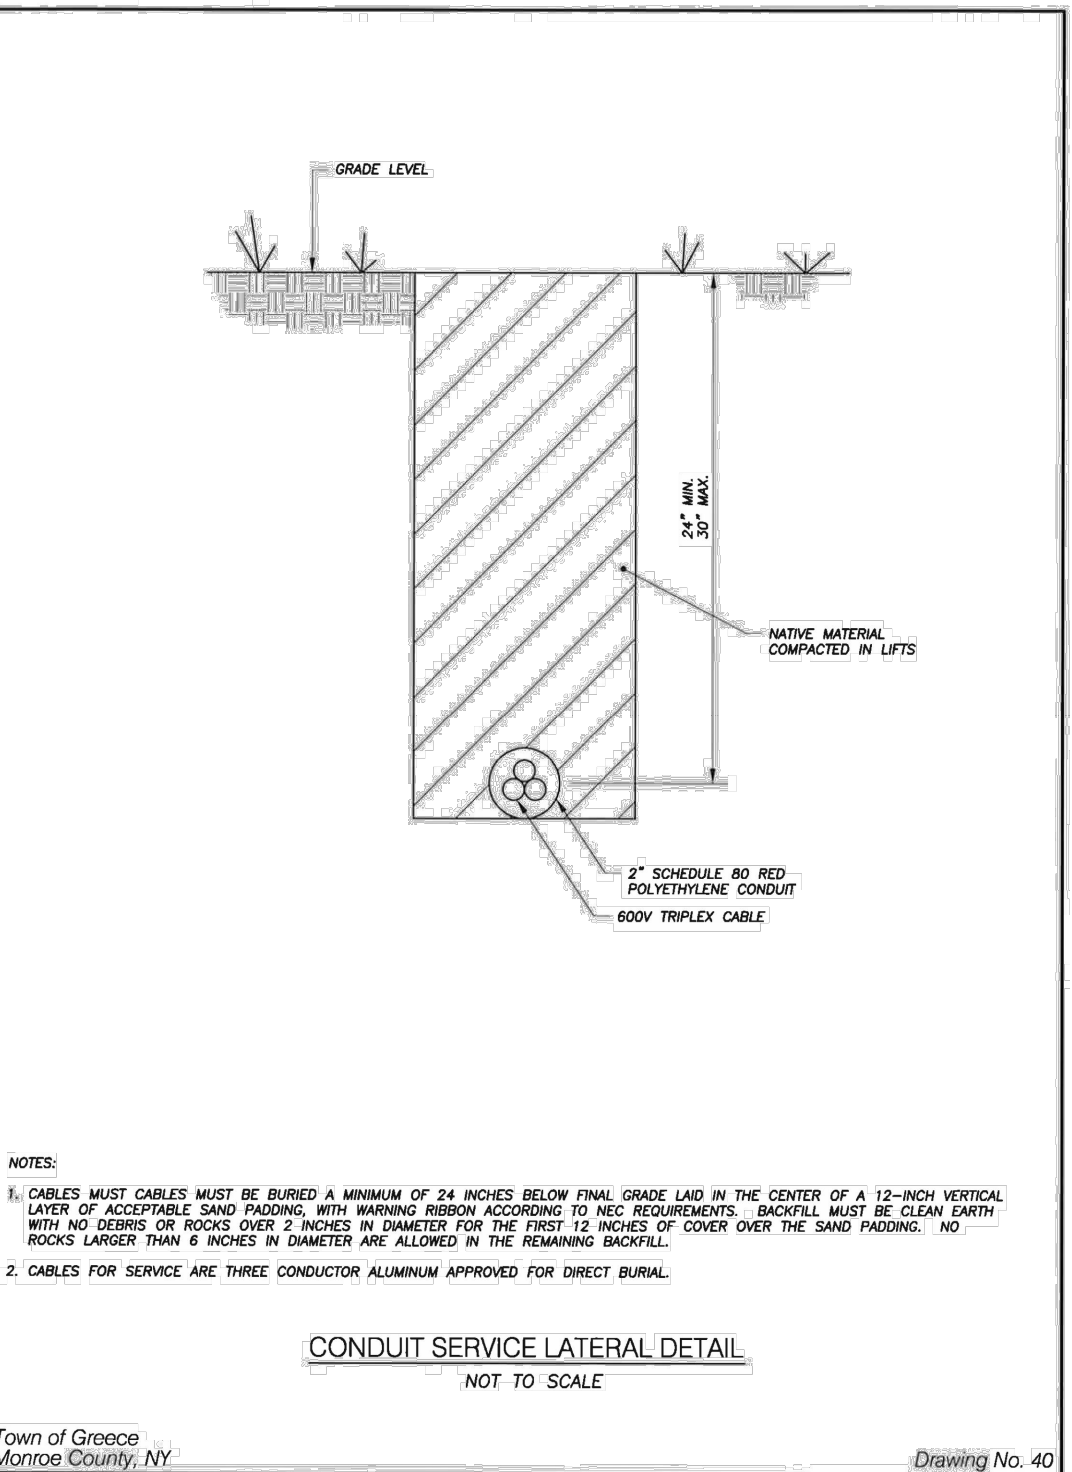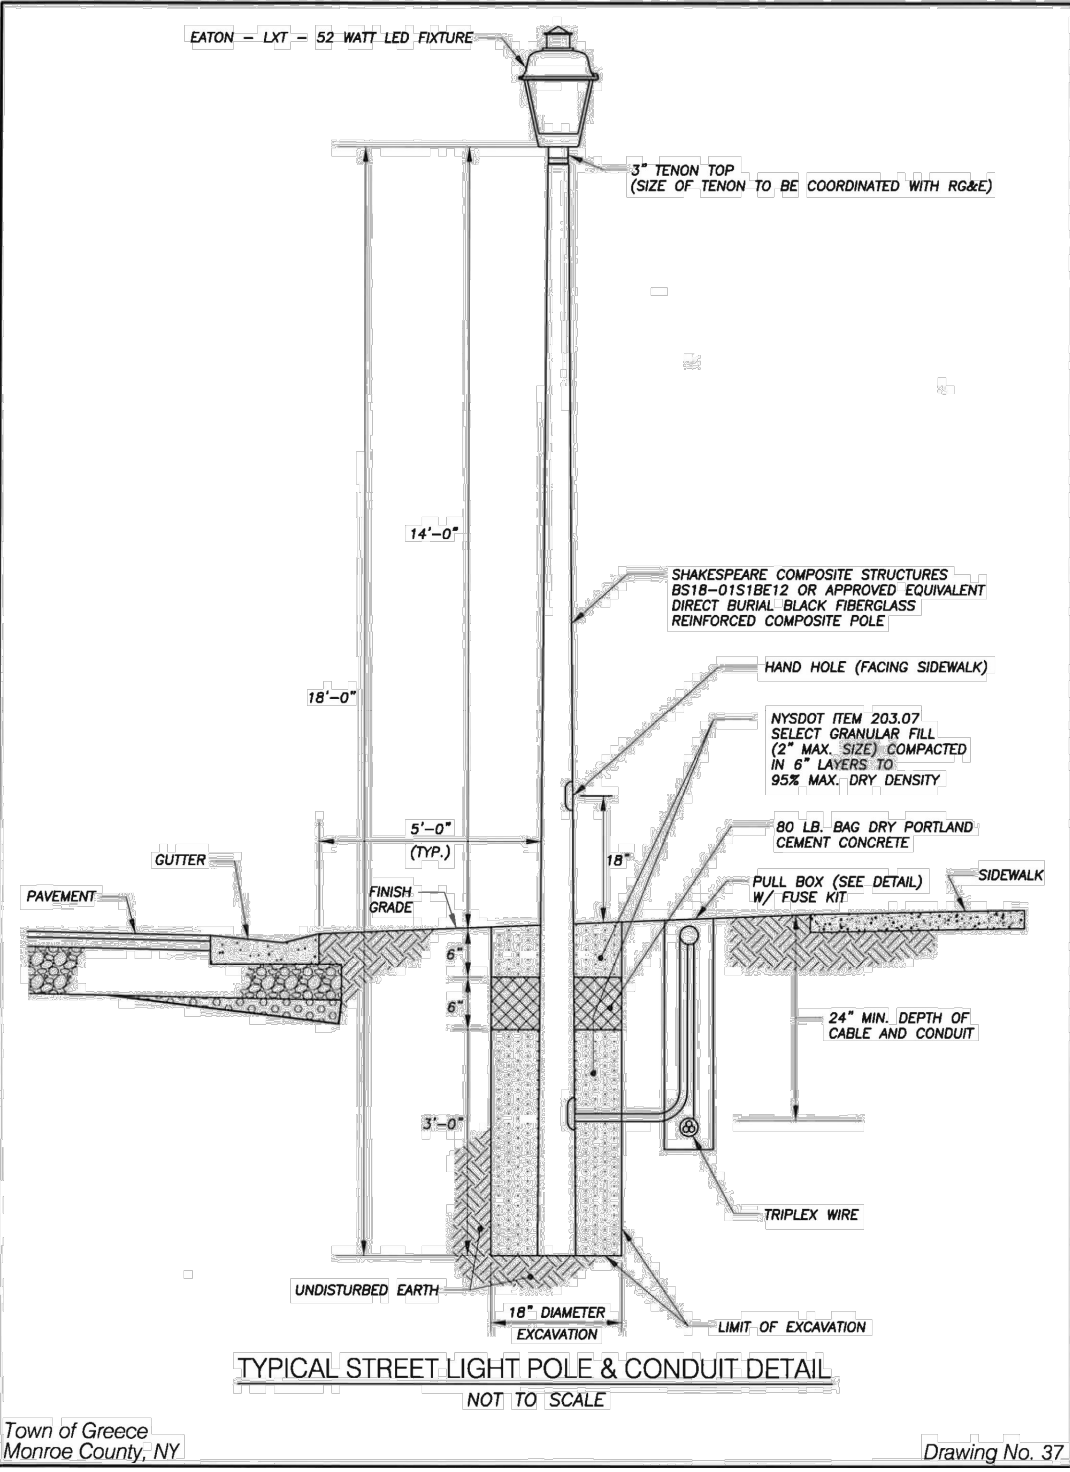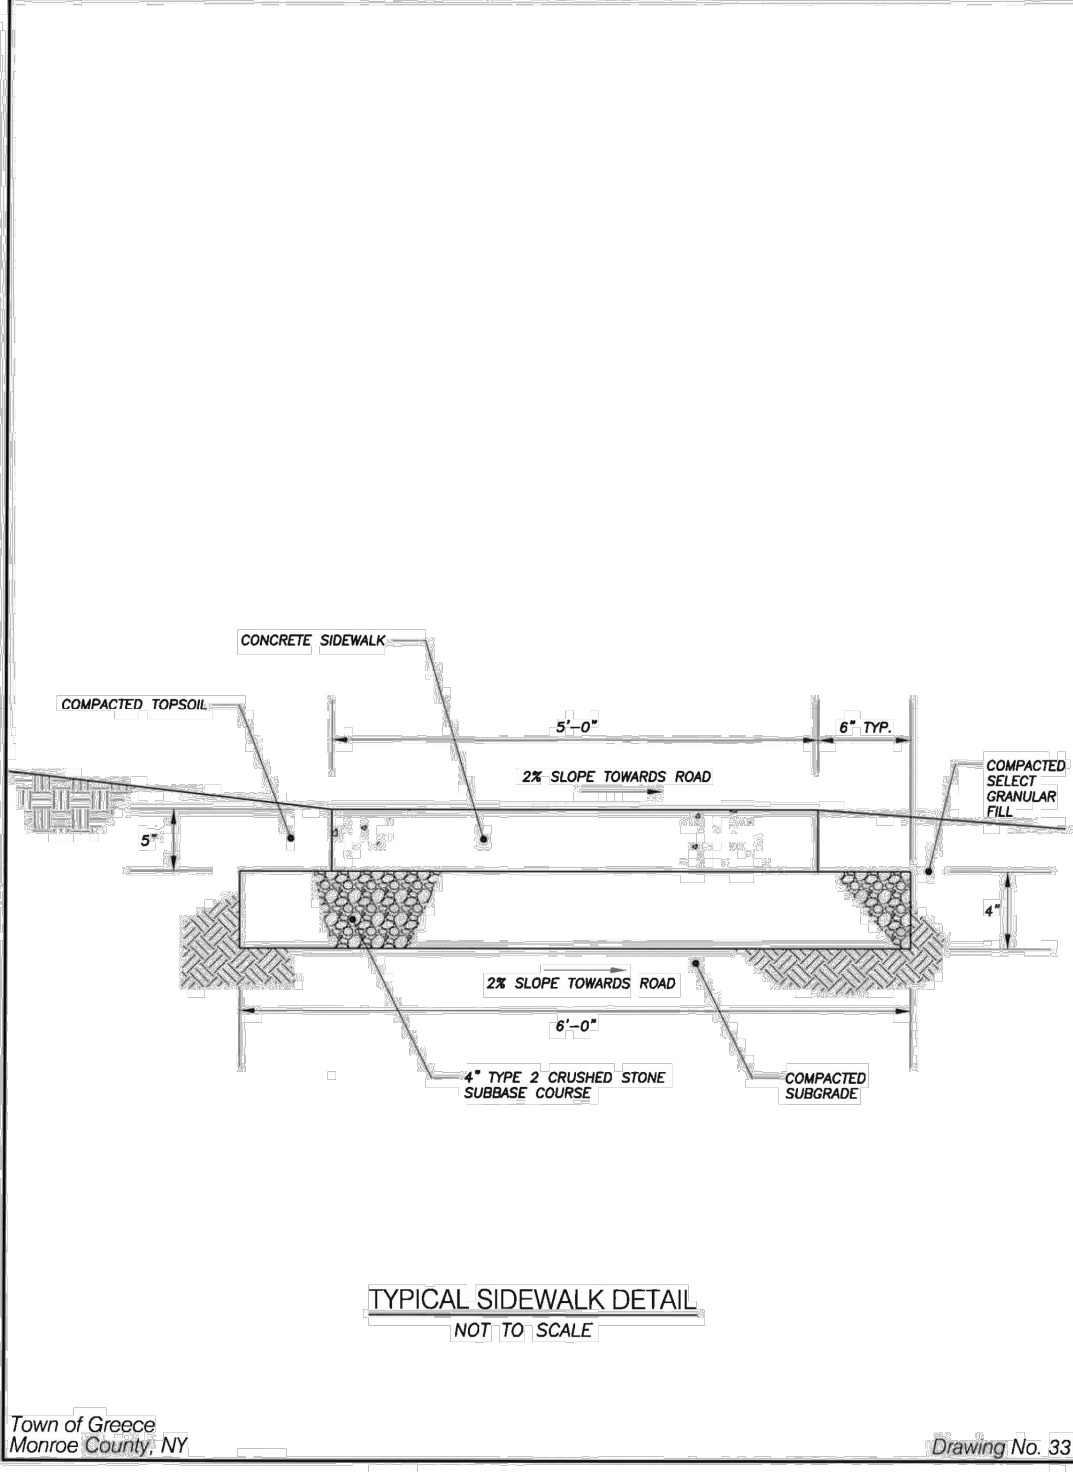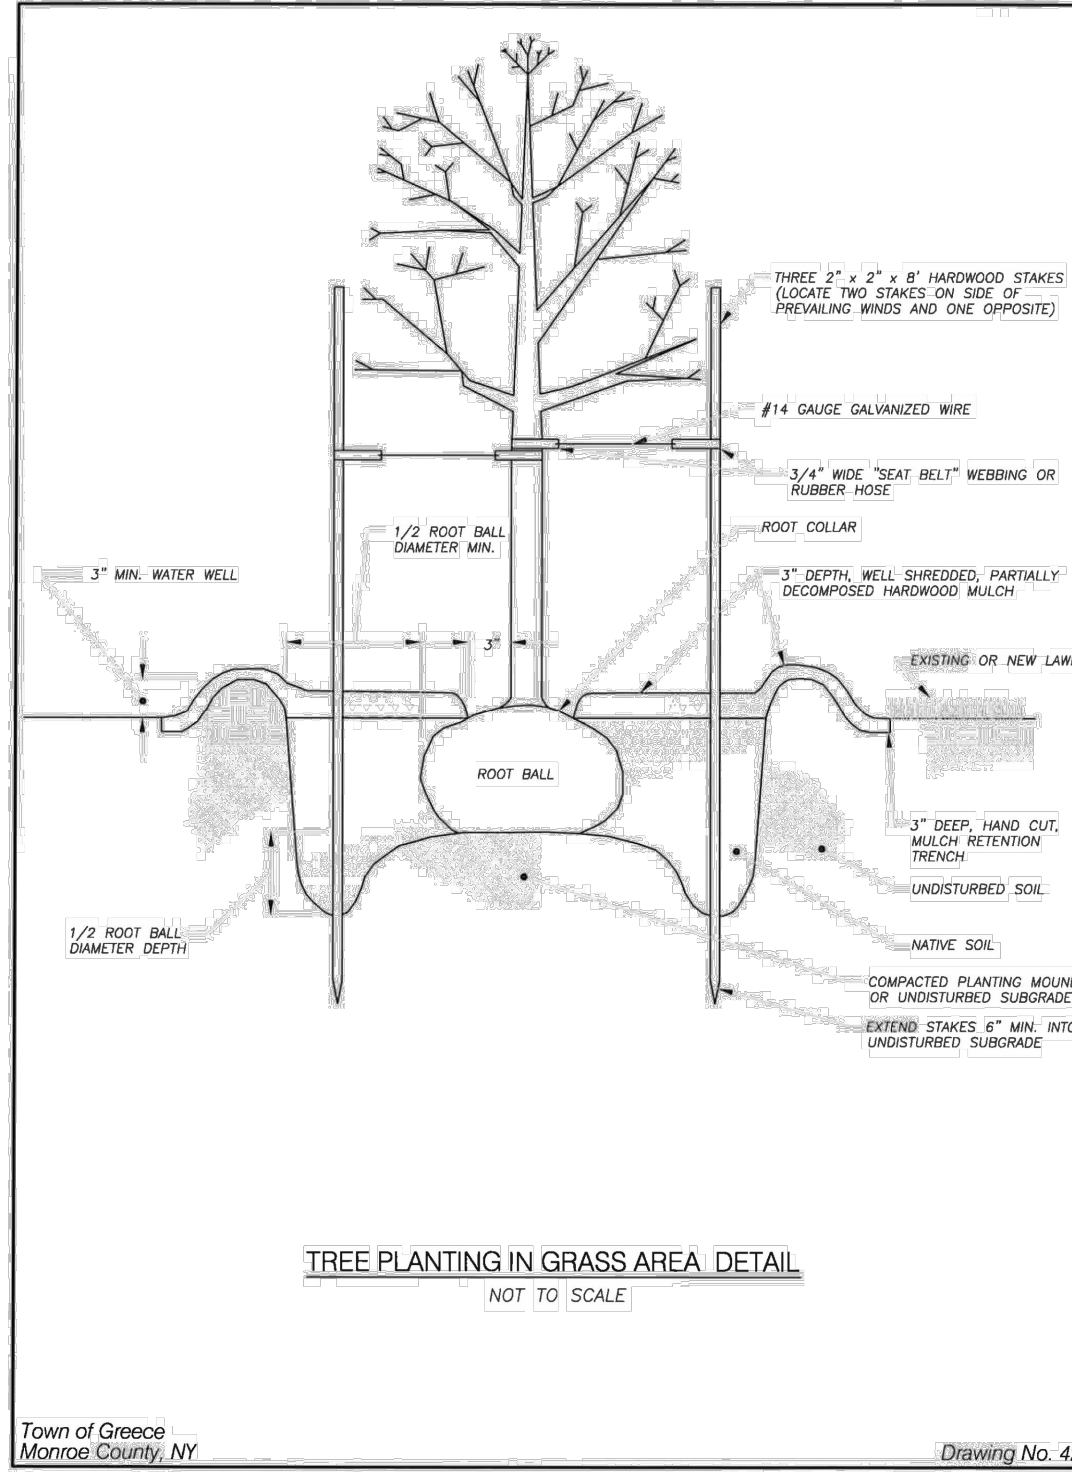

Client:
**NORTH GREECE
FIRE DISTRICT**
1766 LATTIA ROAD
ROCHESTER, NY 14612

PASSERO ASSOCIATES
242 West Main Street Suite 100
Rochester, New York 14614
Principal-in-Charge
Project Manager
Designed by
DAVID COX, PE
ANDREW BURNS, PE
JACOB LEWIS



Revisions			
No.	Date	By	Description
1			

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DETAILS
**NORTH GREECE
FIRE DISTRICT**
County: MONROE State: NY
Project No.
20233530.0002
Drawing No.
C-203
Scale:
N.T.S.
Date
NOVEMBER 4, 2024

BID SET


PIPE DIAMETER	BEND OR FITTING														
	11 1/2 DEGREE			22 1/2 DEGREE			45 DEGREE			90 DEGREE			TEE*, CAP OR PLUG		
	H (FT)	W (FT)	A (FT)	H (FT)	W (FT)	A (FT)	H (FT)	W (FT)	A (FT)	H (FT)	W (FT)	A (FT)	H (FT)	W (FT)	A (FT)

* SIZE BLOCK BASED ON BRANCH DIAMETER.

SOIL BEARING STRENGTH - PSF

PSI TEST PRESSURE

HORIZONTAL AND VERTICAL UP THRUST BLOCKS

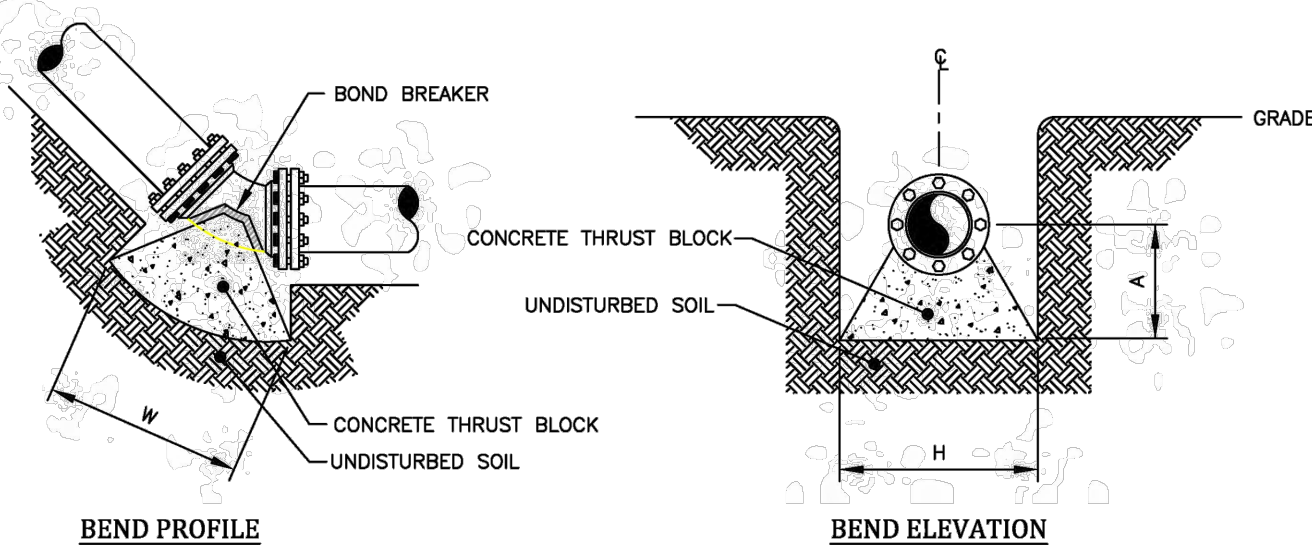


BEND PROFILE

BEND ELEVATION


VERTICAL UP THRUST BLOCKS

NOT TO SCALE

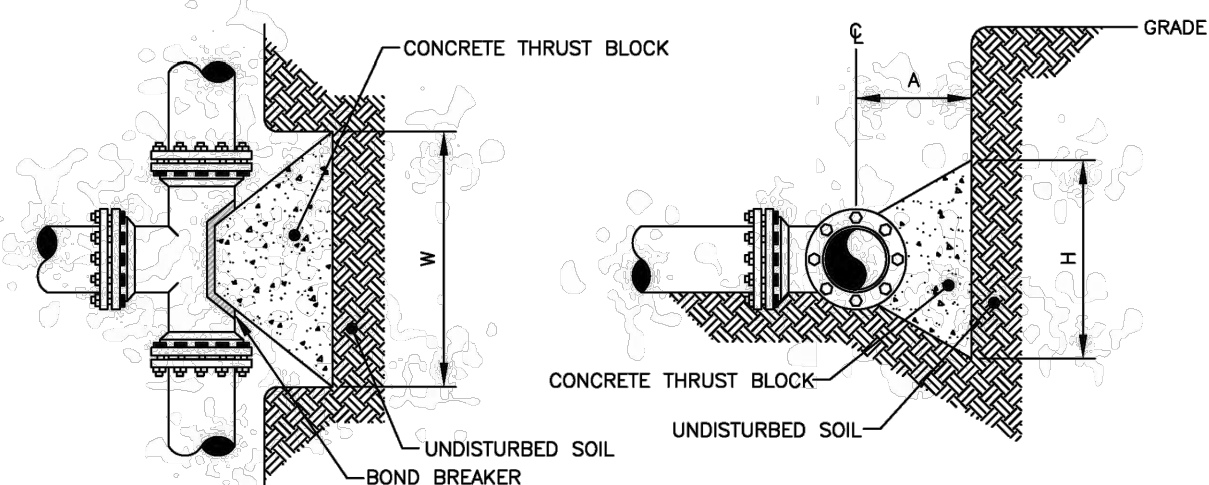

TEE PLAN

TEE ELEVATION

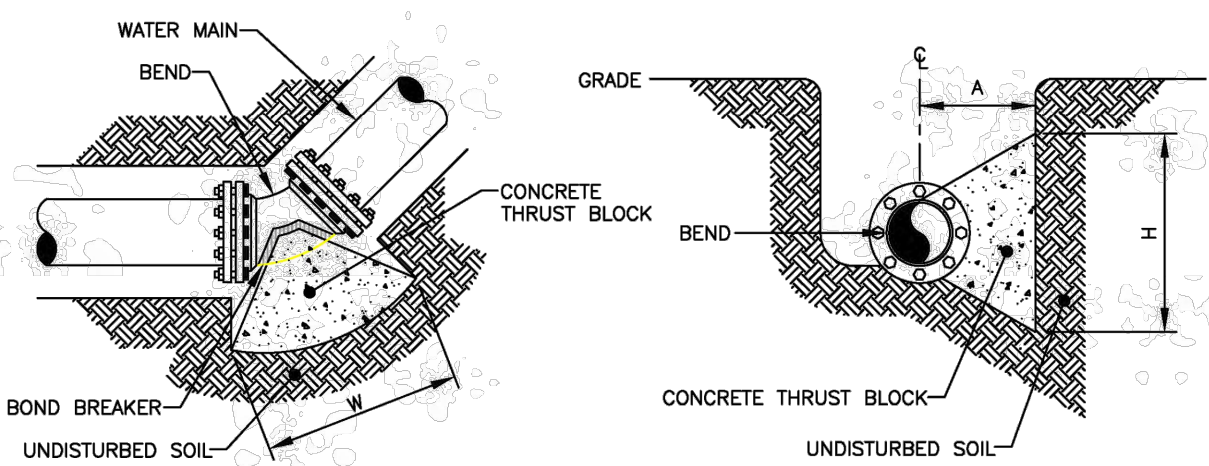

BEND PLAN

BEND ELEVATION

HORIZONTAL THRUST BLOCKS

NOT TO SCALE


SEPT 2016
DATE
DME 6

PIPE DIAMETER	BEND														
	11 1/2 DEGREE			22 1/2 DEGREE			45 DEGREE			90 DEGREE					
	L (FT)	W (FT)	H (FT)	L (FT)	W (FT)	H (FT)	L (FT)	W (FT)	H (FT)	L (FT)	W (FT)	H (FT)	L (FT)	W (FT)	H (FT)


SOIL BEARING STRENGTH - PSF

PSI TEST PRESSURE

VERTICAL DOWN THRUST BLOCKS

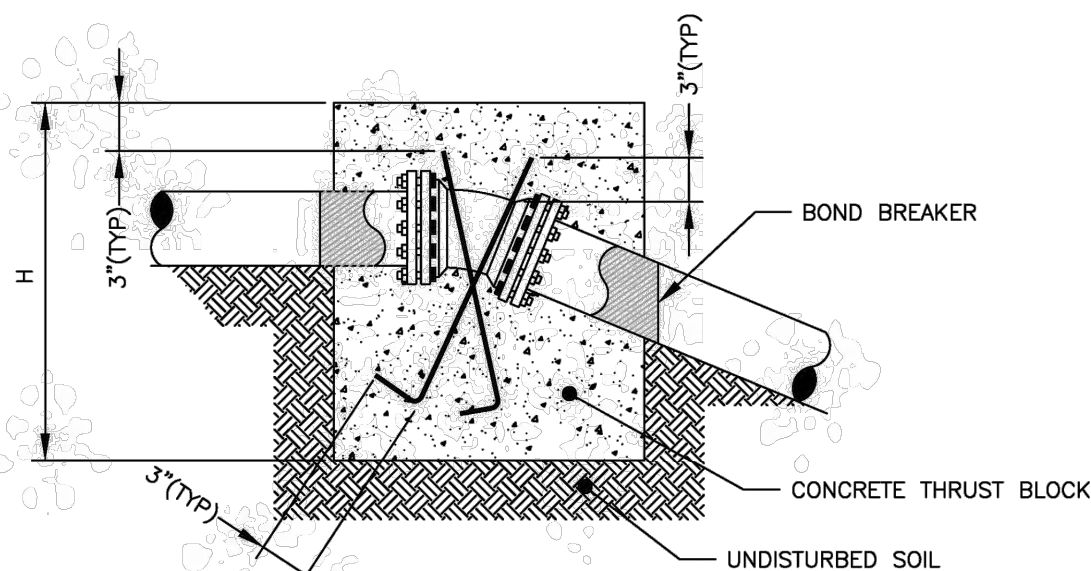

BEND ELEVATION

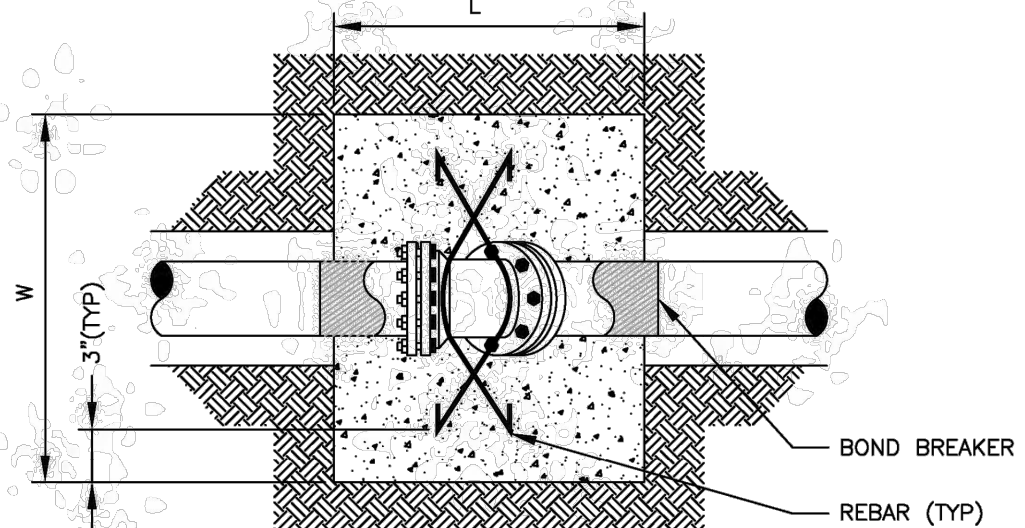

BEND PLAN


NOTES:
1. THRUST BLOCKS SHALL BE CENTERED HORIZONTALLY ON BENDS.
2. VOLUMES SHOWN IN CHART ARE MINIMUMS.

VERTICAL DOWN THRUST BLOCKS

NOT TO SCALE

SEPT 2016
DATE
DME 7

R:\DETAILS\DME\2016 DME DETAILS\DME 14.DWG

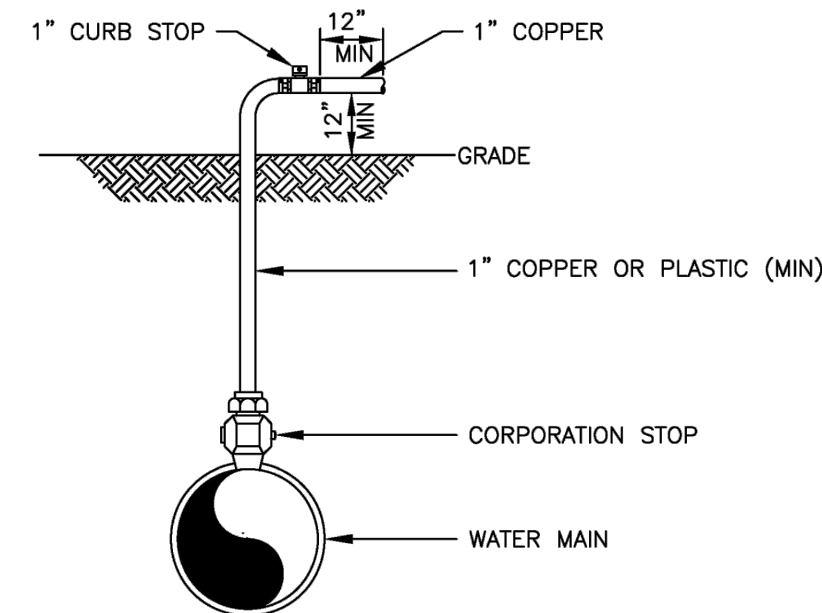


NOTE: IN THE PRESENCE OF A WATER AUTHORITY REPRESENTATIVE REMOVE ALL CORPORATIONS ASSOCIATED WITH TEMPORARY DISINFECTION/SAMPLE TAPS AND REPLACE WITH THREADED BRASS PLUGS.

DISINFECTION/BLOW-OFF/SAMPLING TAP (TEMPORARY)

NOT TO SCALE

SEPT 2016
DATE
DME 14

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Client:
**NORTH GREECE
FIRE DISTRICT**
1766 LATTIA ROAD
ROCHESTER, NY 14612

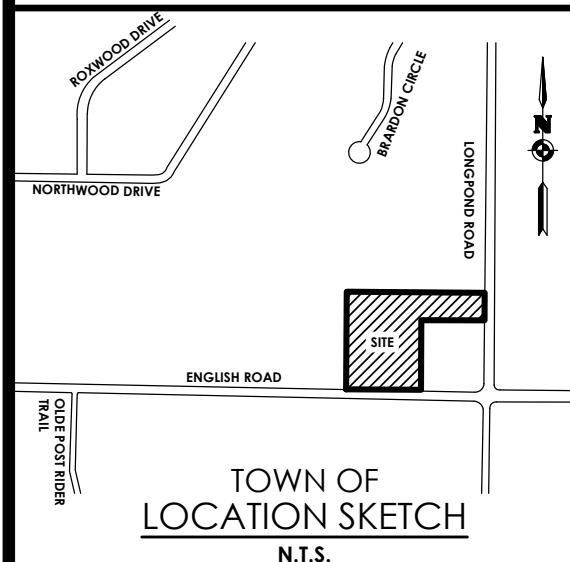PASSERO ASSOCIATES

242 West Main Street Suite 100
Rochester, New York 14614(585) 325-1000
Fax: (585) 325-1691Principal-in-Charge
Project Manager
Designed byDAVID COX, PE
ANDREW BURNS, PE
JACOB LEWIS

Revisions

No.	Date	By	Description
1			

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DETAILS

NORTH GREECE
FIRE DISTRICTTown: GREECE
County: MONROE State: NYProject No:
20233530.0002

Drawing No.

C-204


Scale:

N.T.S.

Date

NOVEMBER 4, 2024

BID SET

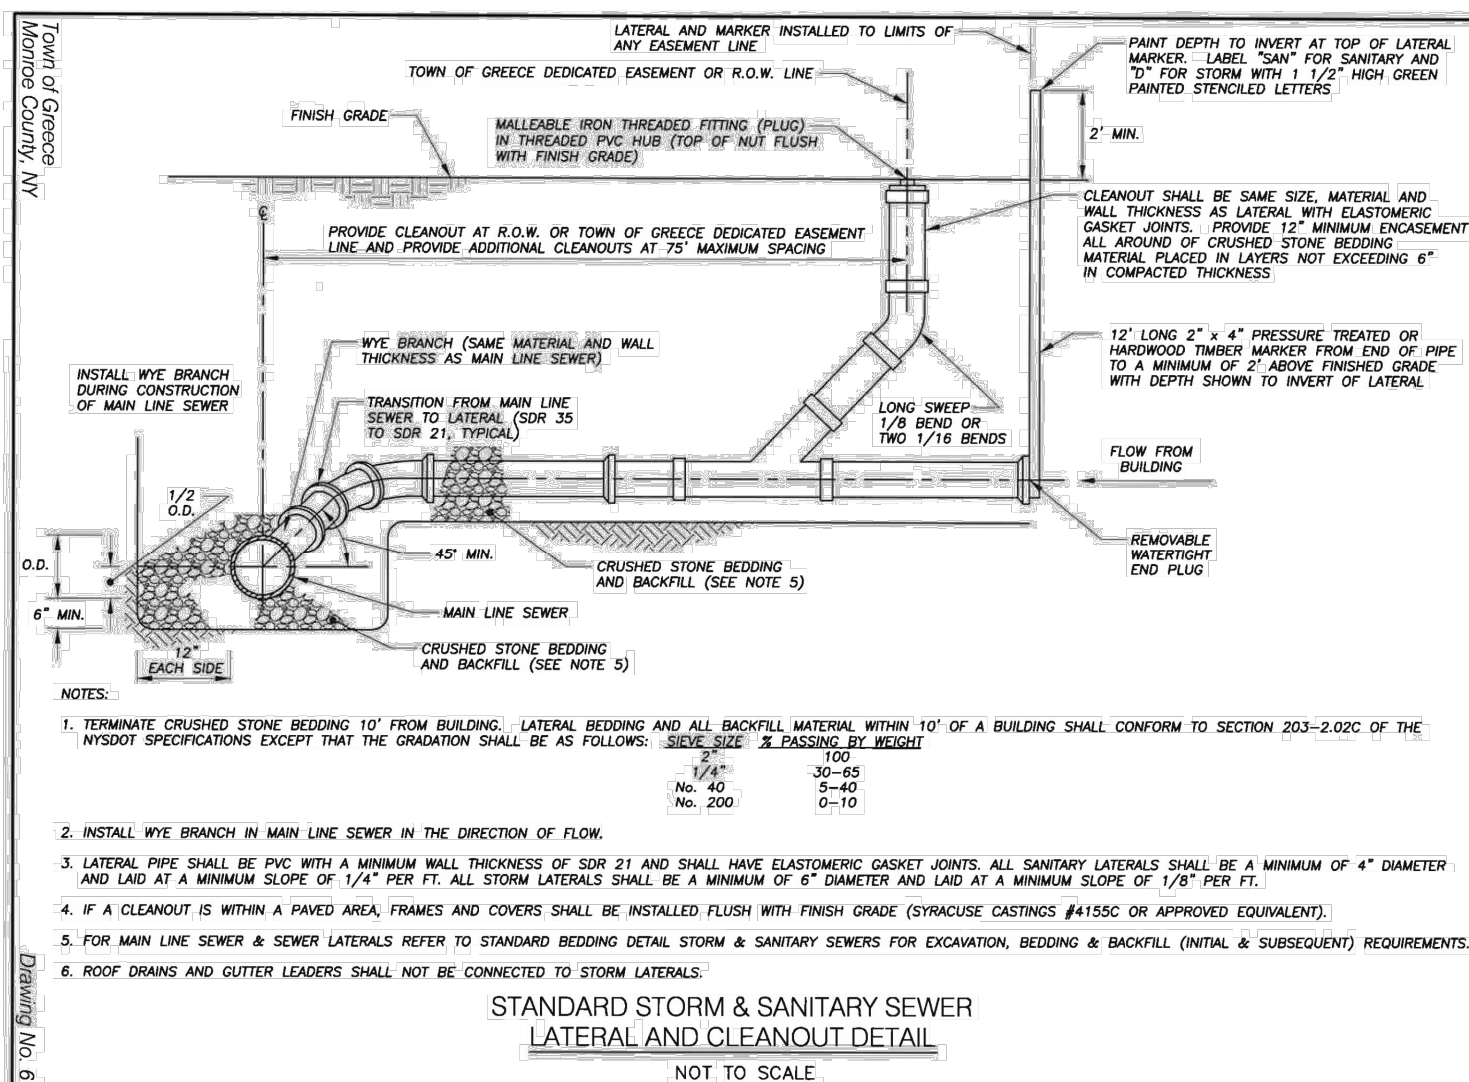

TOWN OF GREECE DEDICATED EASEMENT OR R.O.W. LINE

FINISH GRADE

MALLEABLE IRON THREADED FITTING (PLUGS)

PROVIDE CLEANOUT AT R.O.W. OR TOWN OF GREECE DEDICATED EASEMENT LINE AND PROVIDE ADDITIONAL CLEANOUTS AT 75' MAXIMUM SPACING

WYE BRANCH (SAME MATERIAL AND WALL THICKNESS AS MAIN LINE SEWER)

TRANSITION FROM MAIN LINE SEWER TO LATERAL (FOR 30' TO 21' TYPICAL)

LONG SWEEP 1/8 BEND OR TWO 1/16 BENDS

FLOW FROM BUILDING

REMOVABLE WINTERHOUT END PLUG

CRUSHED STONE BEDDING AND BACKFILL (SEE NOTE 5)

MAIN LINE SEWER

CRUSHED STONE BEDDING AND BACKFILL (SEE NOTE 5)

1/2 O.D.

4" MIN.

45' MIN.

2' MIN.

LATERAL AND MARKER INSTALLED TO LIMITS OF ANY EASEMENT LINE

TOWN OF GREECE DEDICATED EASEMENT OR R.O.W. LINE

PAINT DEPTH TO INVERT AT TOP OF LATERAL MARKER. LABEL 'SAN' FOR SANITARY AND '10' FOR STORM WITH 1 1/2" HIGH GREEN PAINTED STENCILED LETTERS

CLEANOUT SHALL BE SAME SIZE, MATERIAL AND WALL THICKNESS AS LATERAL WITH ELASTOMERIC GASKET JOINTS. PROVIDE 12" MINIMUM ENCASEMENT ALL AROUND OF CRUSHED STONE BEDDING MATERIAL PLACED IN LAYERS NOT EXCEEDING 6" IN COMPACTED THICKNESS

12" LONG 2" x 4" PRESSURE TREATED OR HARDWOOD THUMB MARKER FROM END OF PIPE TO A MINIMUM OF 2' ABOVE FINISHED GRADE WITH DEPTH SHOWN TO INVERT OF LATERAL

