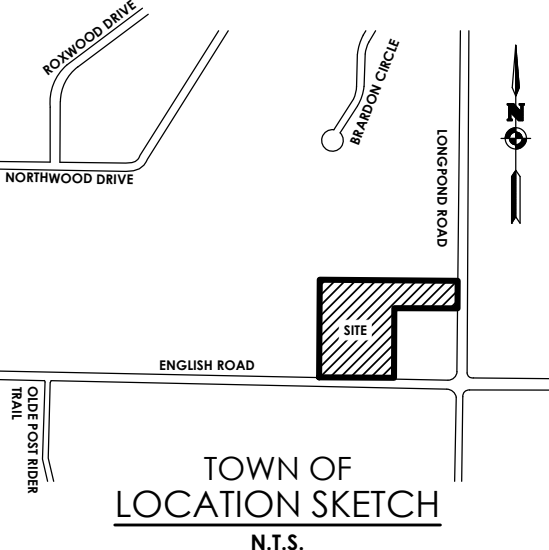


LEGEND - SITE:

- PROPERTY BOUNDARY
- RIGHT OF WAY
- EXISTING CENTER LINE ROAD
- SETBACK
- PROPOSED EASEMENT LINE
- EXISTING EASEMENT LINE
- EXISTING BUILDING
- PROPOSED BUILDING
- PROPOSED BUILDING OVERHANG
- PROPOSED PARKING COUNT
- PROPOSED CONCRETE
- PROPOSED ACCESS RAMP
- PROPOSED PAVEMENT STRIPING
- PROPOSED CURB
- PROPOSED SIGN
- EXISTING SIGN
- PROPOSED LIGHT POLE
- PROPOSED FENCE
- PROPOSED BUILDING MOUNTED LIGHT

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Client:
**NORTH GREECE
FIRE DISTRICT**
1766 LATTA ROAD
ROCHESTER, NY 14612

PASSERO ASSOCIATES

242 West Main Street Suite 100
Rochester, New York 14614
(585) 325-1000
Fax: (585) 325-1691
Principal-in-Charge: DAVID COX, PE
Project Manager: ANDREW BURNS, PE
Designed by: JACOB LEWIS



Revisions

No.	Date	By	Description
1	11/18/24	SMK	BID ADDENDUM #1

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SITE PLAN

**NORTH GREECE
FIRE DISTRICT**

Town: GREECE
County: MONROE State: NY


Project No.
20233530.0002

Drawing No.
C-102

Scale:
1" = 30'

Date
NOVEMBER 4, 2024

BID SET

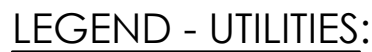

MCDOT NOTES:

1. MCDOT WILL NOT ALLOW SAWCUTS IN PAVEMENT PLACED WITHIN THE LAST FIVE (5) YEARS.

Watermain Approval

Monroe County Department of Public Health

These plans for Public Water System Extension / Improvement are hereby approved pursuant to 10NYCRR5 of the State Sanitary Code subject to conditions of Approval

Director of Public Health

Director of Public Health

By _____ Public Health Engineer _____ Date _____

MONROE COUNTY
DEPT. OF TRANSPORTATION

APPROVED _____

DATE _____

APPLICATIONS FOR PERMITS WILL NOW BE ACCEPTED
THIS PROJECT APPROVAL IS VALID FOR TWO (2) YEARS

Northwest Quadrant Pure Waters District

Review Number _____
 Conforms to Monroe County
 Pure Waters Master Plan

Signature	Date
-----------	------

APPROVED BY _____ DATE _____
MONROE COUNTY WATER AUTHORITY

TH GREECE
DISTRICT
LATTA ROAD
HESTER, NY 14612

PASSERO ASSOCIATES

**If you excavate anywhere in
New York State,
except NYC or Long Island, call**

Dig Safely.
New York
-800-962-7962
Notice = www.DigSafelyNewYork.com



Revisions

No.	Date	By	Description
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UTILITY PLAN

NORTH GREECE
FIRE DISTRICT

Town: GREECE
County: MONROE State: NY

20233530.0002

Drawing No





C-104

Scale:

 $\lambda'' = 30$

Date _____

NOVEMBER 4, 2024

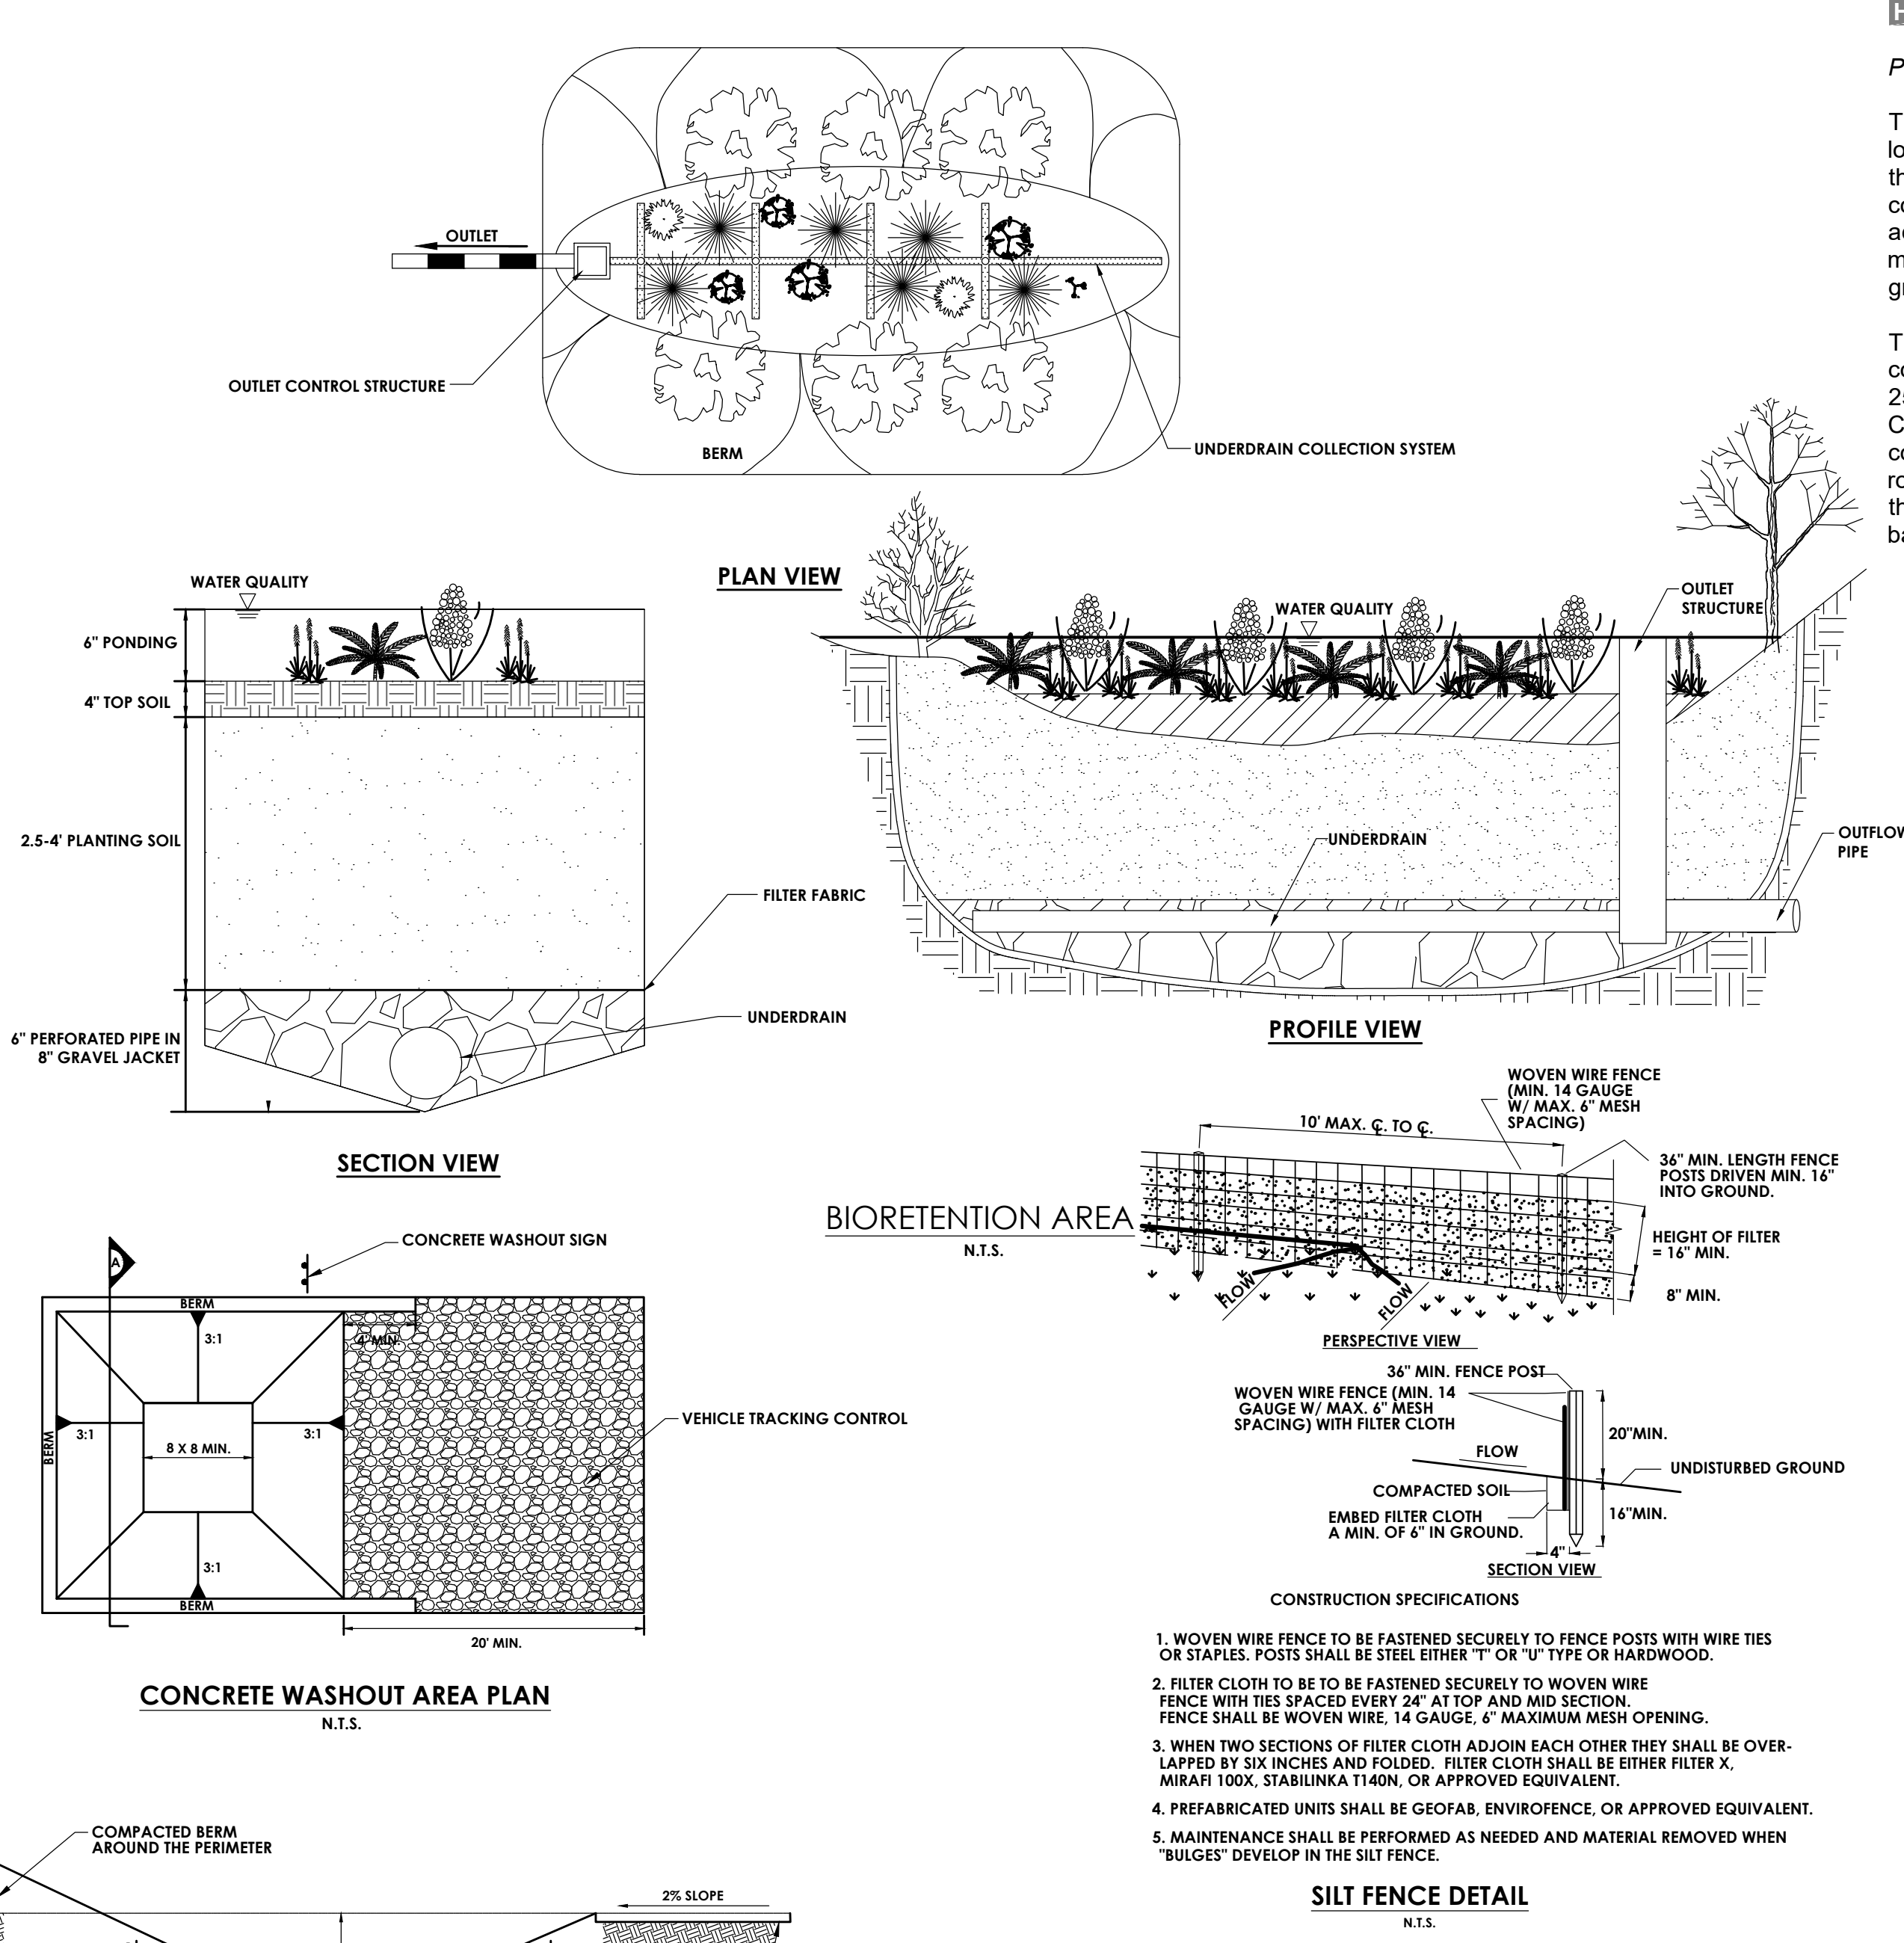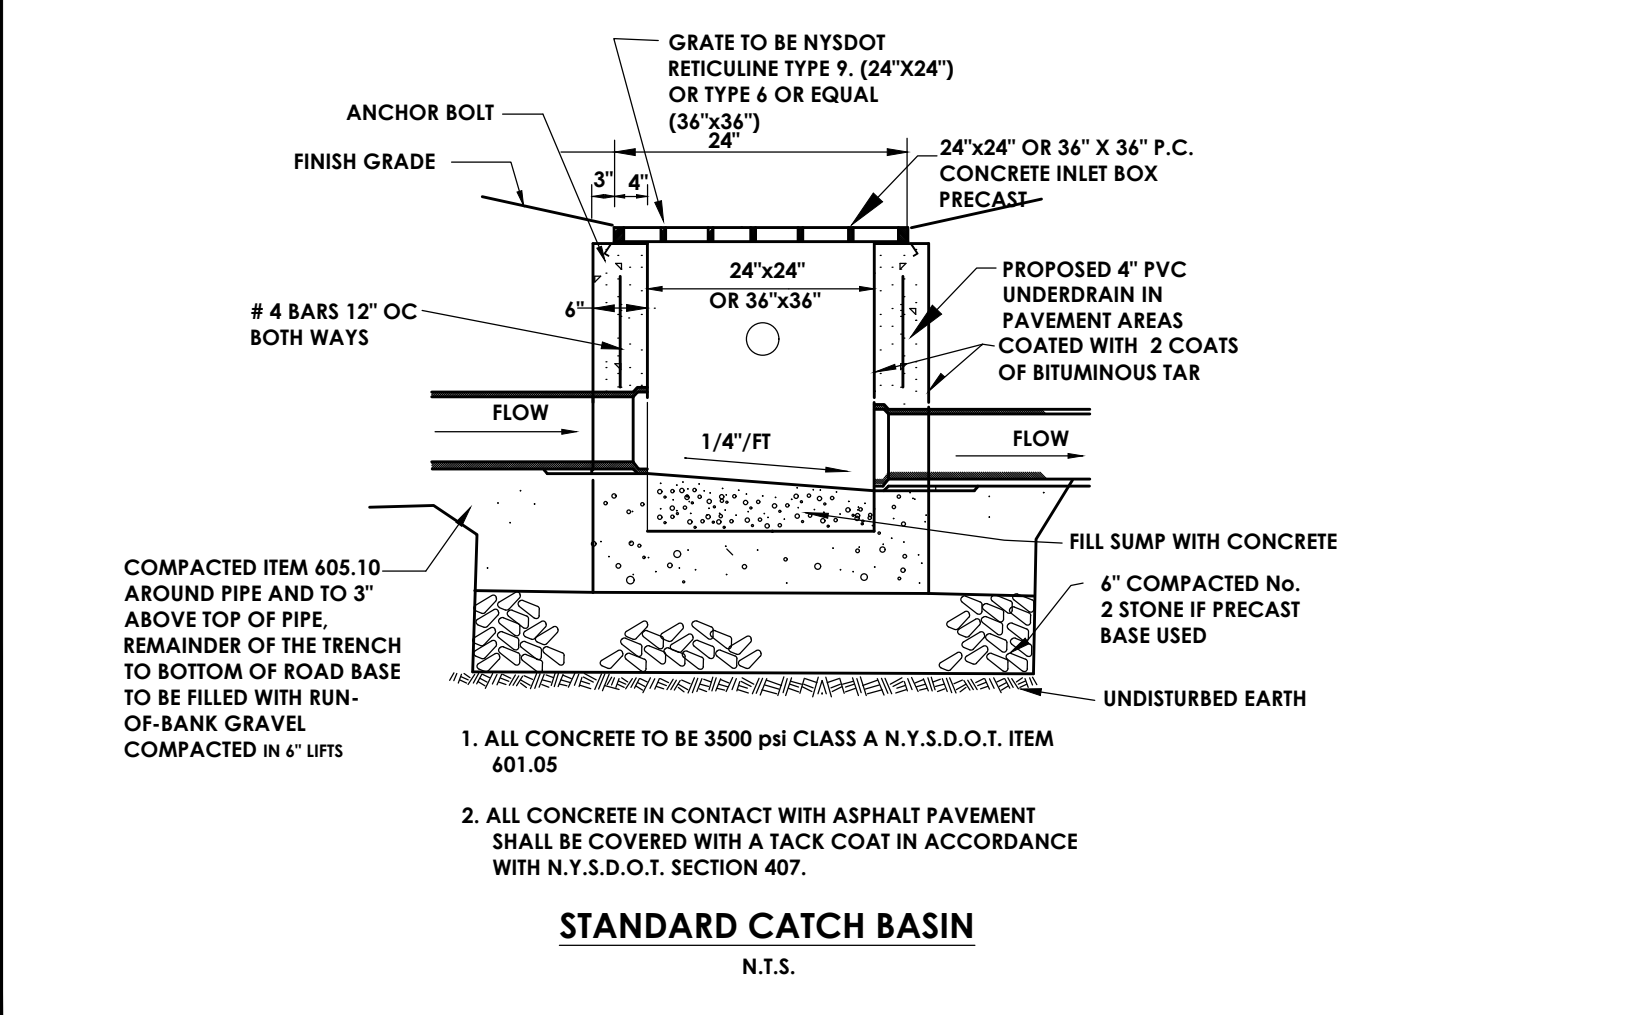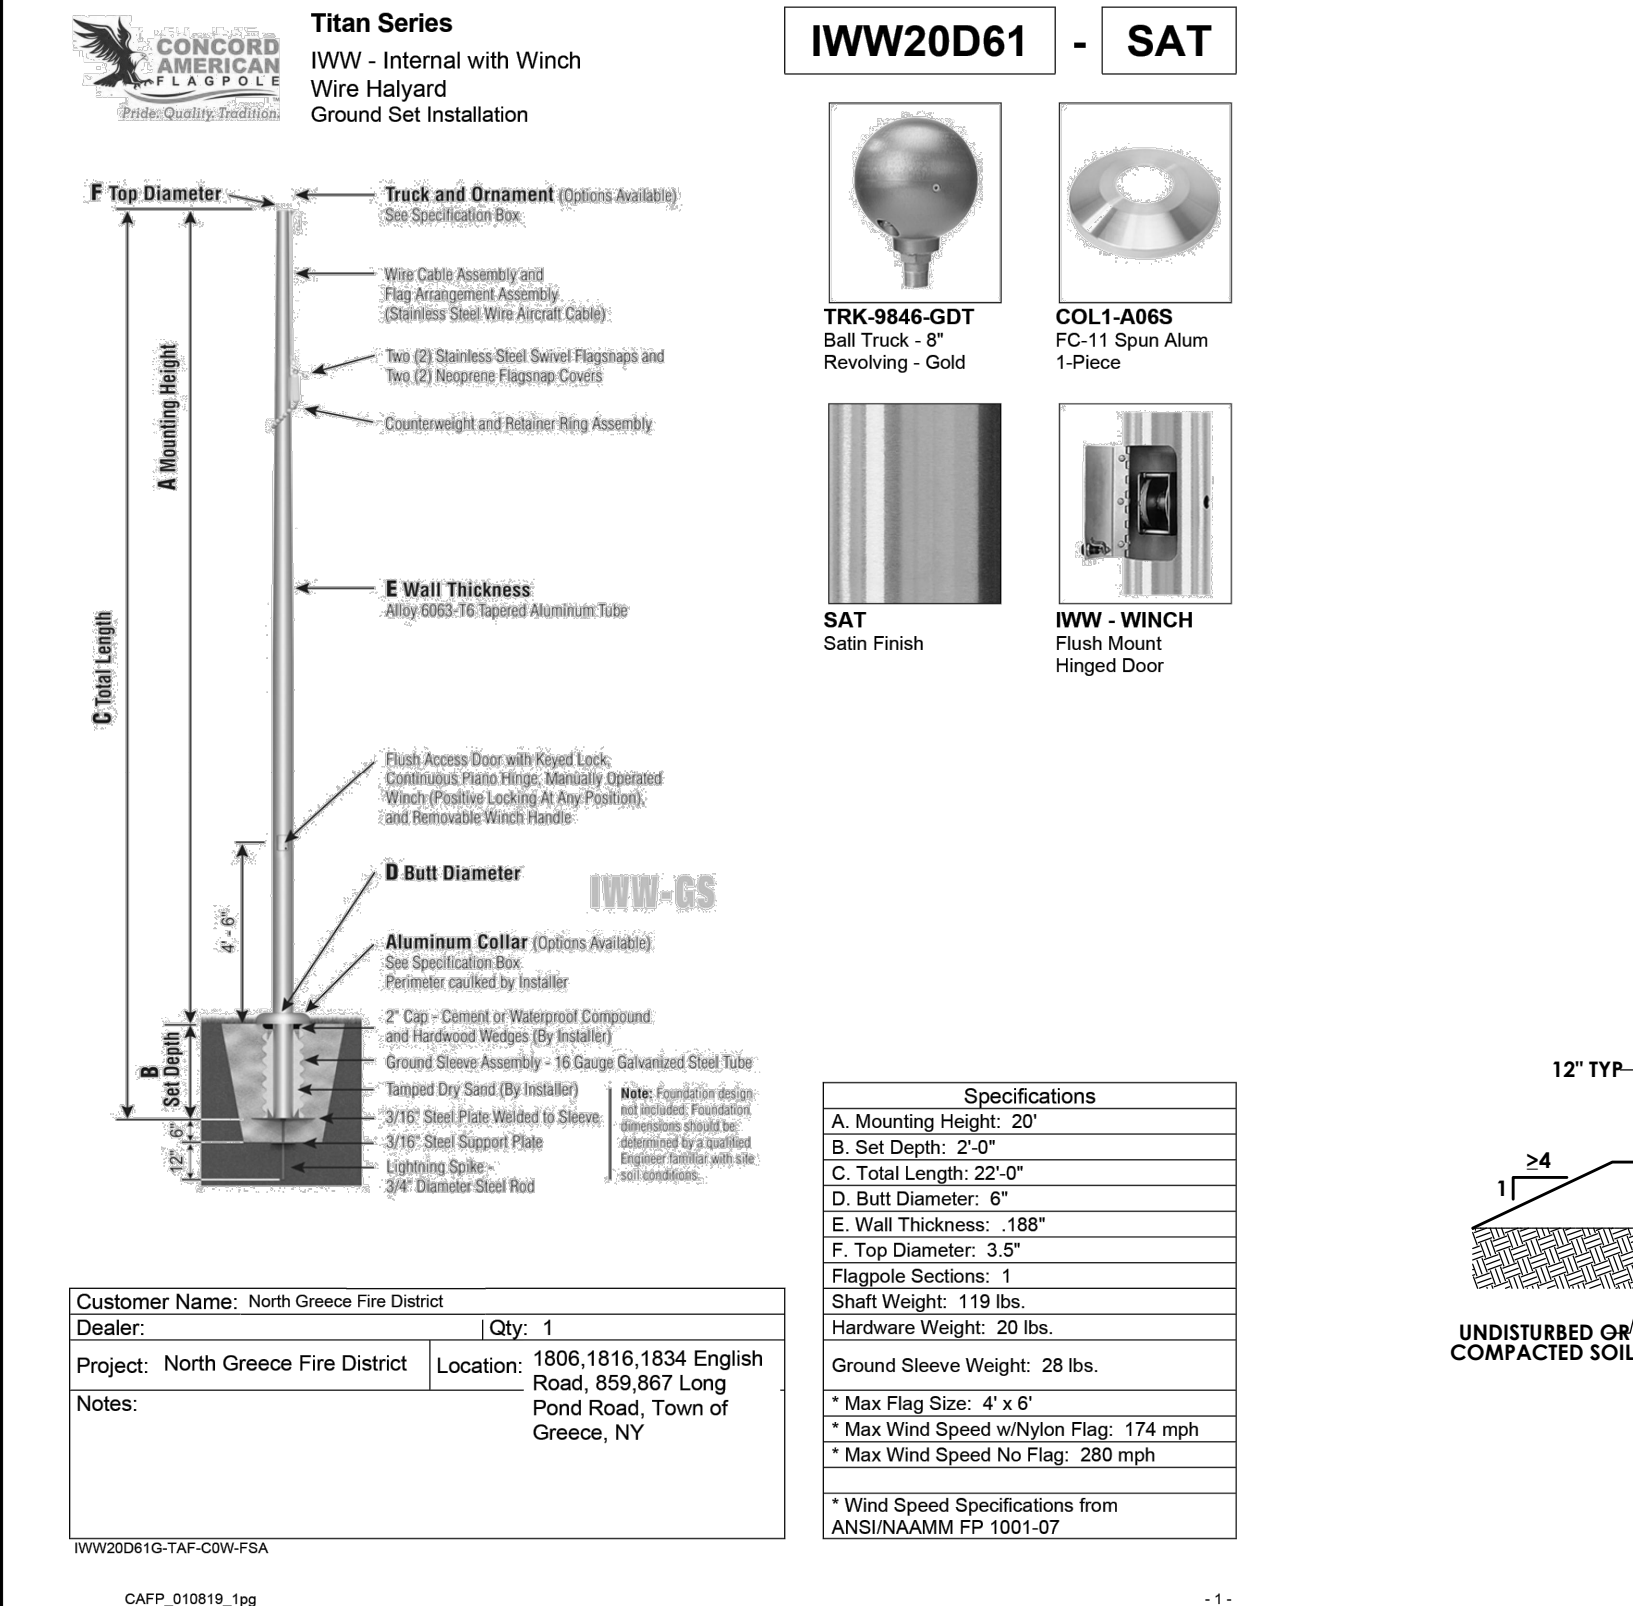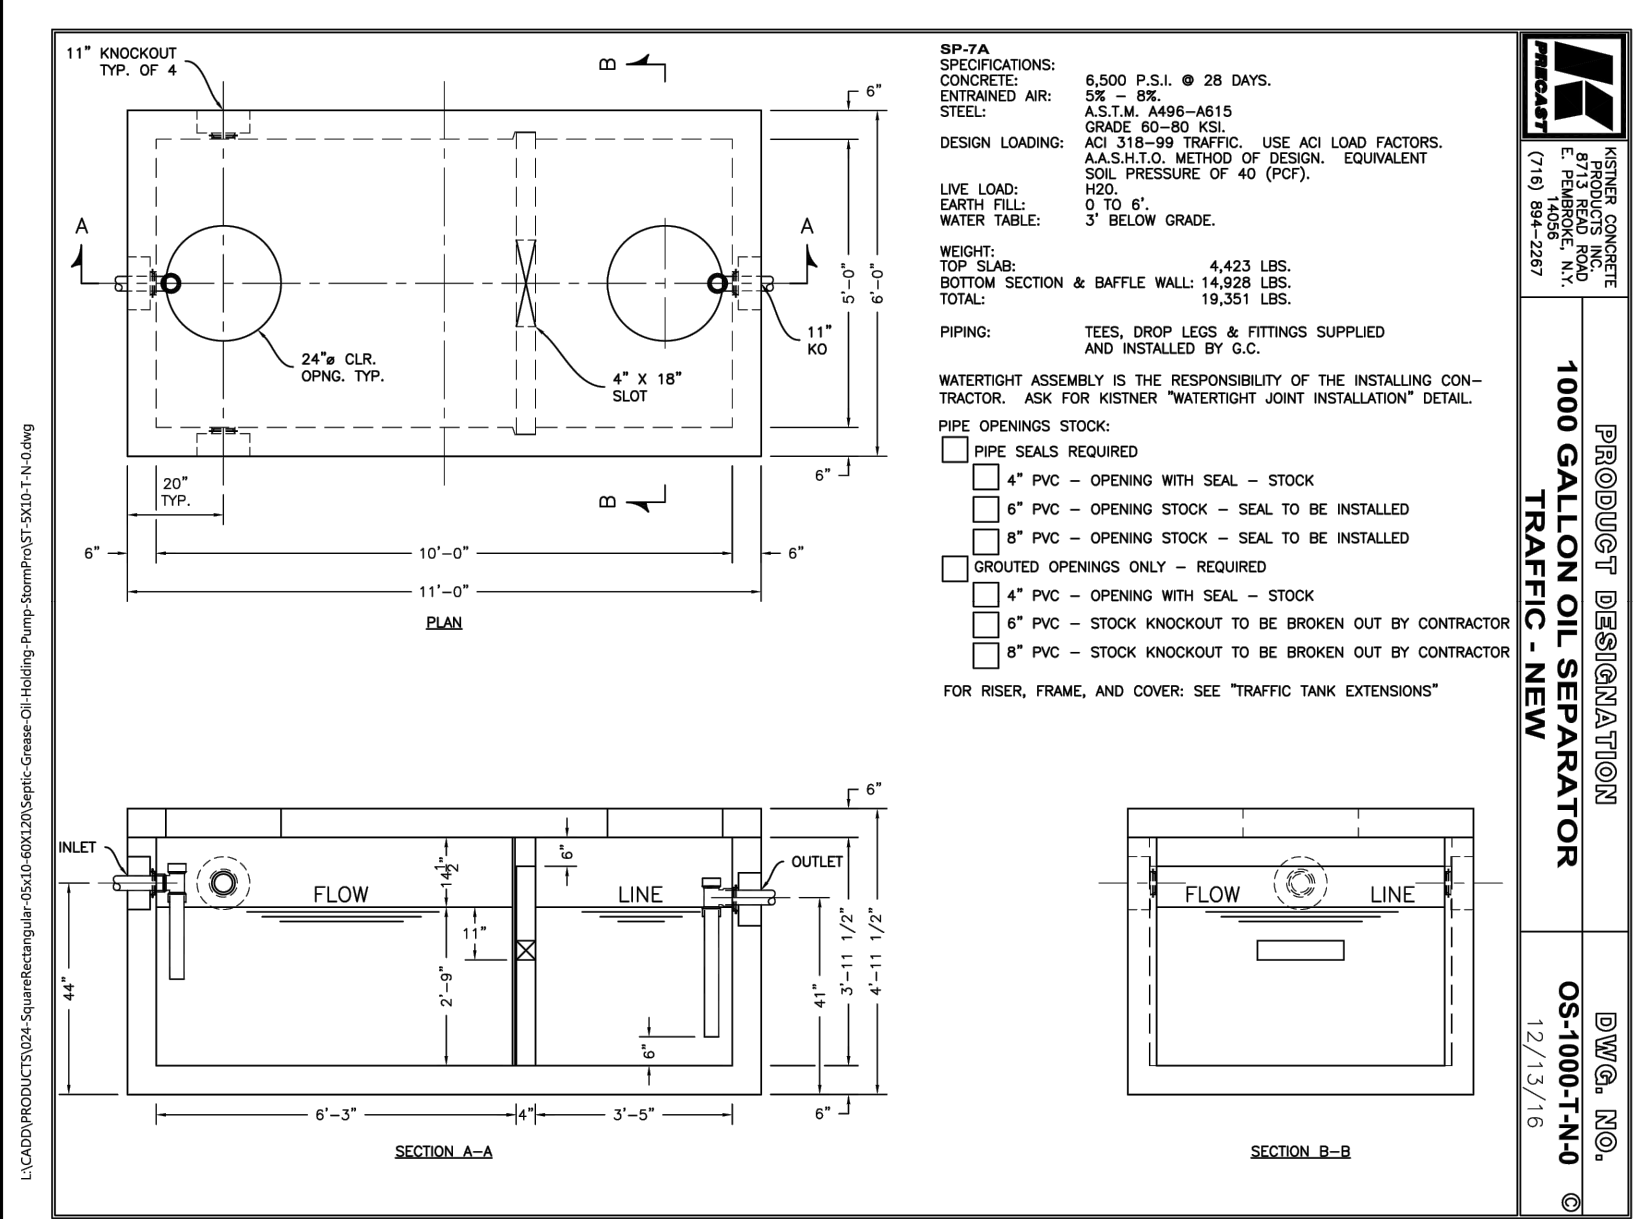

H.2 Bioretention

Planting Soil Bed Characteristics

The characteristics of the soil for the bioretention facility are perhaps as important as the facility location, size, and treatment volume. The soil must be permeable enough to allow runoff to filter through the media, while having characteristics suitable to promote and sustain a robust vegetative cover crop. In addition, much of the nutrient pollutant uptake (nitrogen and phosphorus) is accomplished through adsorption and microbial activity within the soil profile. Therefore, the soils must balance soil chemistry and physical properties to support biotic communities above and below ground.

The planting soil should be a sandy loam, loamy sand, loam (USDA), or a loam/sand mix (should contain a minimum 35 to 60% sand, by volume). The clay content for these soils should be less than 25% by volume. Soils should fall within the SM, or ML classifications of the Unified Soil Classification System (USCS). A permeability of at least 1.0 feet per day (0.5"/hr) is required (a conservative value of 0.5 feet per day is used for design). The soil should be free of stones, stumps, roots, or other woody material over 1" in diameter. Brush or seeds from noxious weeds. Placement of the planting soil should be in lifts of 12 to 18", loosely compacted (tamped lightly with a dozer or backhoe bucket). The specific characteristics are presented in Table H.2.

Table H.2 Planting Soil Characteristics	
Parameter	Value
PH range	5.2 to 7.00
Organic matter	1.5 to 4.0%
Magnesium	35 lbs. per acre, minimum
Phosphorus (P2O5)	75 lbs. per acre, minimum
Potassium (K2O)	85 lbs. per acre, minimum
Soluble salts	□ 500 ppm
Clay	10 to 25%
Silt	30 to 55%
Sand	35 to 60%

DAWN ENTERPRISES

OUR PRODUCTS. YOUR SPACE.

Specification Sheet

Model #: PC24x24x24S

24" sq x 24" tall Classic Series concrete planter

**Shown here in Brown #238 color with LSB finish and sealer.*

Specifications:

- Dimensions:** 24" cube with 2" tall x 2" deep toe kick at base.
- Weight:** 590 lbs
- Materials:** 3/8" steel rebar, Type III Portland cement conforming to ASTM C150. All aggregate conforming to ASTM C33. All Steel Rebar conforming to ASTM – A 615. Due to the natural air entraining properties of Portland Type III cement, additional air entraining agents are not required. Air void content naturally occurring in a Type III Portland Cement mixture conforms to ASTM C457.
- Stress Load:** Minimum 5000 PSI at 28 days
- Color & Finish Options:** Please reference standard color/finish sheet.
- Warranty:** One year warranty against manufacturer's defects.

800-262-3296 275 Progress Drive, Suite B, Manchester, CT 06042 www.godawn.com

PASSERO

architecture engineering

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ROCHESTER, NY 14612

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DETAILS

NORTH GREECE FIRE DISTRICT

Town: GREECE
County: MONROE State: NY

Project No: 20233530.0002

Drawing No. C-205

Scale: N.T.S.

Date: NOVEMBER 4, 2024

BID SET