

1 ATTIC FLOOR PLAN
0' 2' 4' 8' 16'
1/8" = 1'-0"

FLOOR PLAN GENERAL NOTES:

- REFER TO SHEET G-001 FOR WALL TYPES
- DIMENSION STYLES
 - METAL STUD WALLS (INTERIOR) ARE DIMENSIONED TO CENTER OF STUD. METAL STUD WALLS (EXTERIOR) ARE DIMENSIONED TO FACE OF STUD.
 - MASONRY WALLS ARE DIMENSIONED TO FACE OF MASONRY.
- THE CONTRACTOR SHALL REVIEW ALL DIMENSIONS AND NOTIFY THE ARCHITECT OF ANY DISCREPANCIES PRIOR TO CONSTRUCTION.
- PROVIDE BLOCKING AT ALL TV/MONITOR AND FUTURE TV/MONITOR LOCATIONS. REFER TO ELECTRICAL DRAWINGS FOR LOCATIONS.
- ALL WORK COMPLETED AS PART OF THIS PROJECT SHALL MEET ALL APPLICABLE FEDERAL, STATE, AND LOCAL CODES, AND SHALL MEET THE REQUIREMENTS OF THE OWNER AND LOCAL JURISDICTION.
- ALL PENETRATIONS THROUGH RATED ASSEMBLIES SHALL BE SEALED IN ACCORDANCE WITH THE LATEST EDITION OF THE NYS BUILDING CODE.
- COMBUSTIBLE MATERIALS ARE NOT PERMITTED IN CONCEALED SPACES UNLESS ALLOWED BY EXCEPTION IN THE NYS BUILDING CODE.
- ALL MATERIALS INSTALLED IN CONTACT WITH THE WEATHER BARRIER SHALL BE REVIEWED FOR COMPATIBILITY BY THE MANUFACTURER PRIOR TO SUBMITTAL. ALL SUCH SUBMITTALS SHALL INCLUDE MANUFACTURER'S CERTIFICATE OF COMPATIBILITY.
- ALL INTERIOR COLUMNS ARE TO BE WRAPPED WITH 1/4" METAL FURRING AND 5/8" GYP. BD. U.N.O.

KEYNOTES - ROOF PLAN [0]

1	DOWNSPOUT
2	METAL GUTTER
3	TAPERED INSULATION
4	STANDING SEAM METAL ROOF
5	METAL VALLEY FLASHING - TYP.
6	CANOPY METAL ROOF
7	SNOW GUARD
8	WALK PAD
9	SCUPPER
10	FIRE TREATED PLYWOOD SHEATHING
11	DELEGATED DESIGN - TRUSS SYSTEM ABOVE ATTIC

STAMP:

CLIENT:
N. GREECE FIRE DISTRICT
1766 LATTA RD
ROCHESTER, NY 14612

Passero Associates

242 WEST MAIN ST., SUITE 100 (585) 325-1000
ROCHESTER, NY 14614 FAX: (585) 325-1691
PROJECT MANAGER: TIM GEIER
PROJECT ARCHITECT: TIM GEIER
DESIGNER: QUILLIE HUGHES

NO.	DATE	BY	DESCRIPTION
1	01/30/25		ADDENDUM 1

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ATTIC FLOOR PLAN

1816 ENGLISH RD

NGFD - ENGLISH ROAD
STATION
TOWN/CITY: GREECE
COUNTY: MONROE STATE: NY

PROJECT NO.:
20233530.0001

DRAWING NO.:
A-102

DATE:
JANUARY 22, 2025

BID SET

REFLECTED CEILING PLAN GENERAL NOTES:

- ALL NOTED ELEVATIONS ARE ABOVE FINISHED FLOOR OF THE SAME SPACE UNLESS OTHERWISE NOTED.
- ALL FIRE RATED PARTITIONS SHALL CONTINUE TO AND FORM A SMOKE/TIGHT SEAL AT THE UNDERSIDE OF THE FLOOR/ROOF DECK ABOVE.
- REVIEW CEILING LAYOUT WITH ARCHITECT PRIOR TO INSTALLATION (INCLUDING LIGHTING FIXTURES).
- REFER TO HVAC, ELECTRICAL, PLUMBING, AND FIRE PROTECTION DRAWINGS FOR ADDITIONAL INFORMATION ON EQUIPMENT AND FIXTURES.
- ALL GYPSUM BOARD CEILINGS SHALL BE 5/8" THICK GYPSUM BOARD ON STEEL SUSPENSION SYSTEM UNLESS NOTED/SHOWN OTHERWISE.
- LIGHT ELEVATIONS ARE PRELIMINARY. VERIFY ALL MOUNTING HEIGHTS WITH ARCHITECT PRIOR TO FINAL INSTALLATION.
- PAINT ALL EXPOSED STRUCTURE, MECHANICAL, ELECTRICAL, AND PLUMBING ITEMS. COLORS TO BE SELECTED BY ARCHITECT.
- PAINT ALL EXPOSED PIPING, DUCTS, CONDUIT, STRUT SUPPORTS, HANGERS, AND STRUCTURAL STEEL. COORDINATE WITH MEP DRAWINGS AND OTHER CONTRACTORS FOR LOCATIONS AND EXTENTS. COLORS TO BE SELECTED BY ARCHITECT.
- STEEL STRUCTURE WILL BE ONE COLOR TO BE SELECTED BY THE ARCHITECT. THE ROOF DECK AND MISCELLANEOUS MEP ITEMS WILL BE ONE COLOR SELECTED BY THE ARCHITECT.

CEILING PLAN LEGEND

- 2X2 ACOUSTIC CEILING TILE
- GYPSUM CEILING
- EXPOSED STRUCTURE, NO CEILING
- PENDANT LIGHT
- 2X2 TROFFER LIGHT
- RECESSED DOWNLIGHT
- SURFACE MOUNTED LINEAR STRIP LIGHT
- SURFACE MOUNTED LINEAR LIGHT
- BUILDING MOUNTED LIGHT

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FIRST FLOOR
REFLECTED CEILING
PLAN

1816 ENGLISH RD

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STATION
TOWN/CITY: GREECE

COUNTY: MONROE STATE: NY

PROJECT NO.:

20233530.0001


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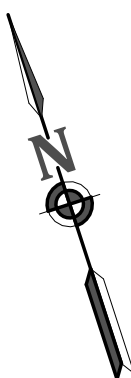
JANUARY 22, 2025




BID SET



1 LEVEL 1 REFLECTED CEILING PLAN

0' 2' 4' 8' 16'
1/8" = 1'-0"

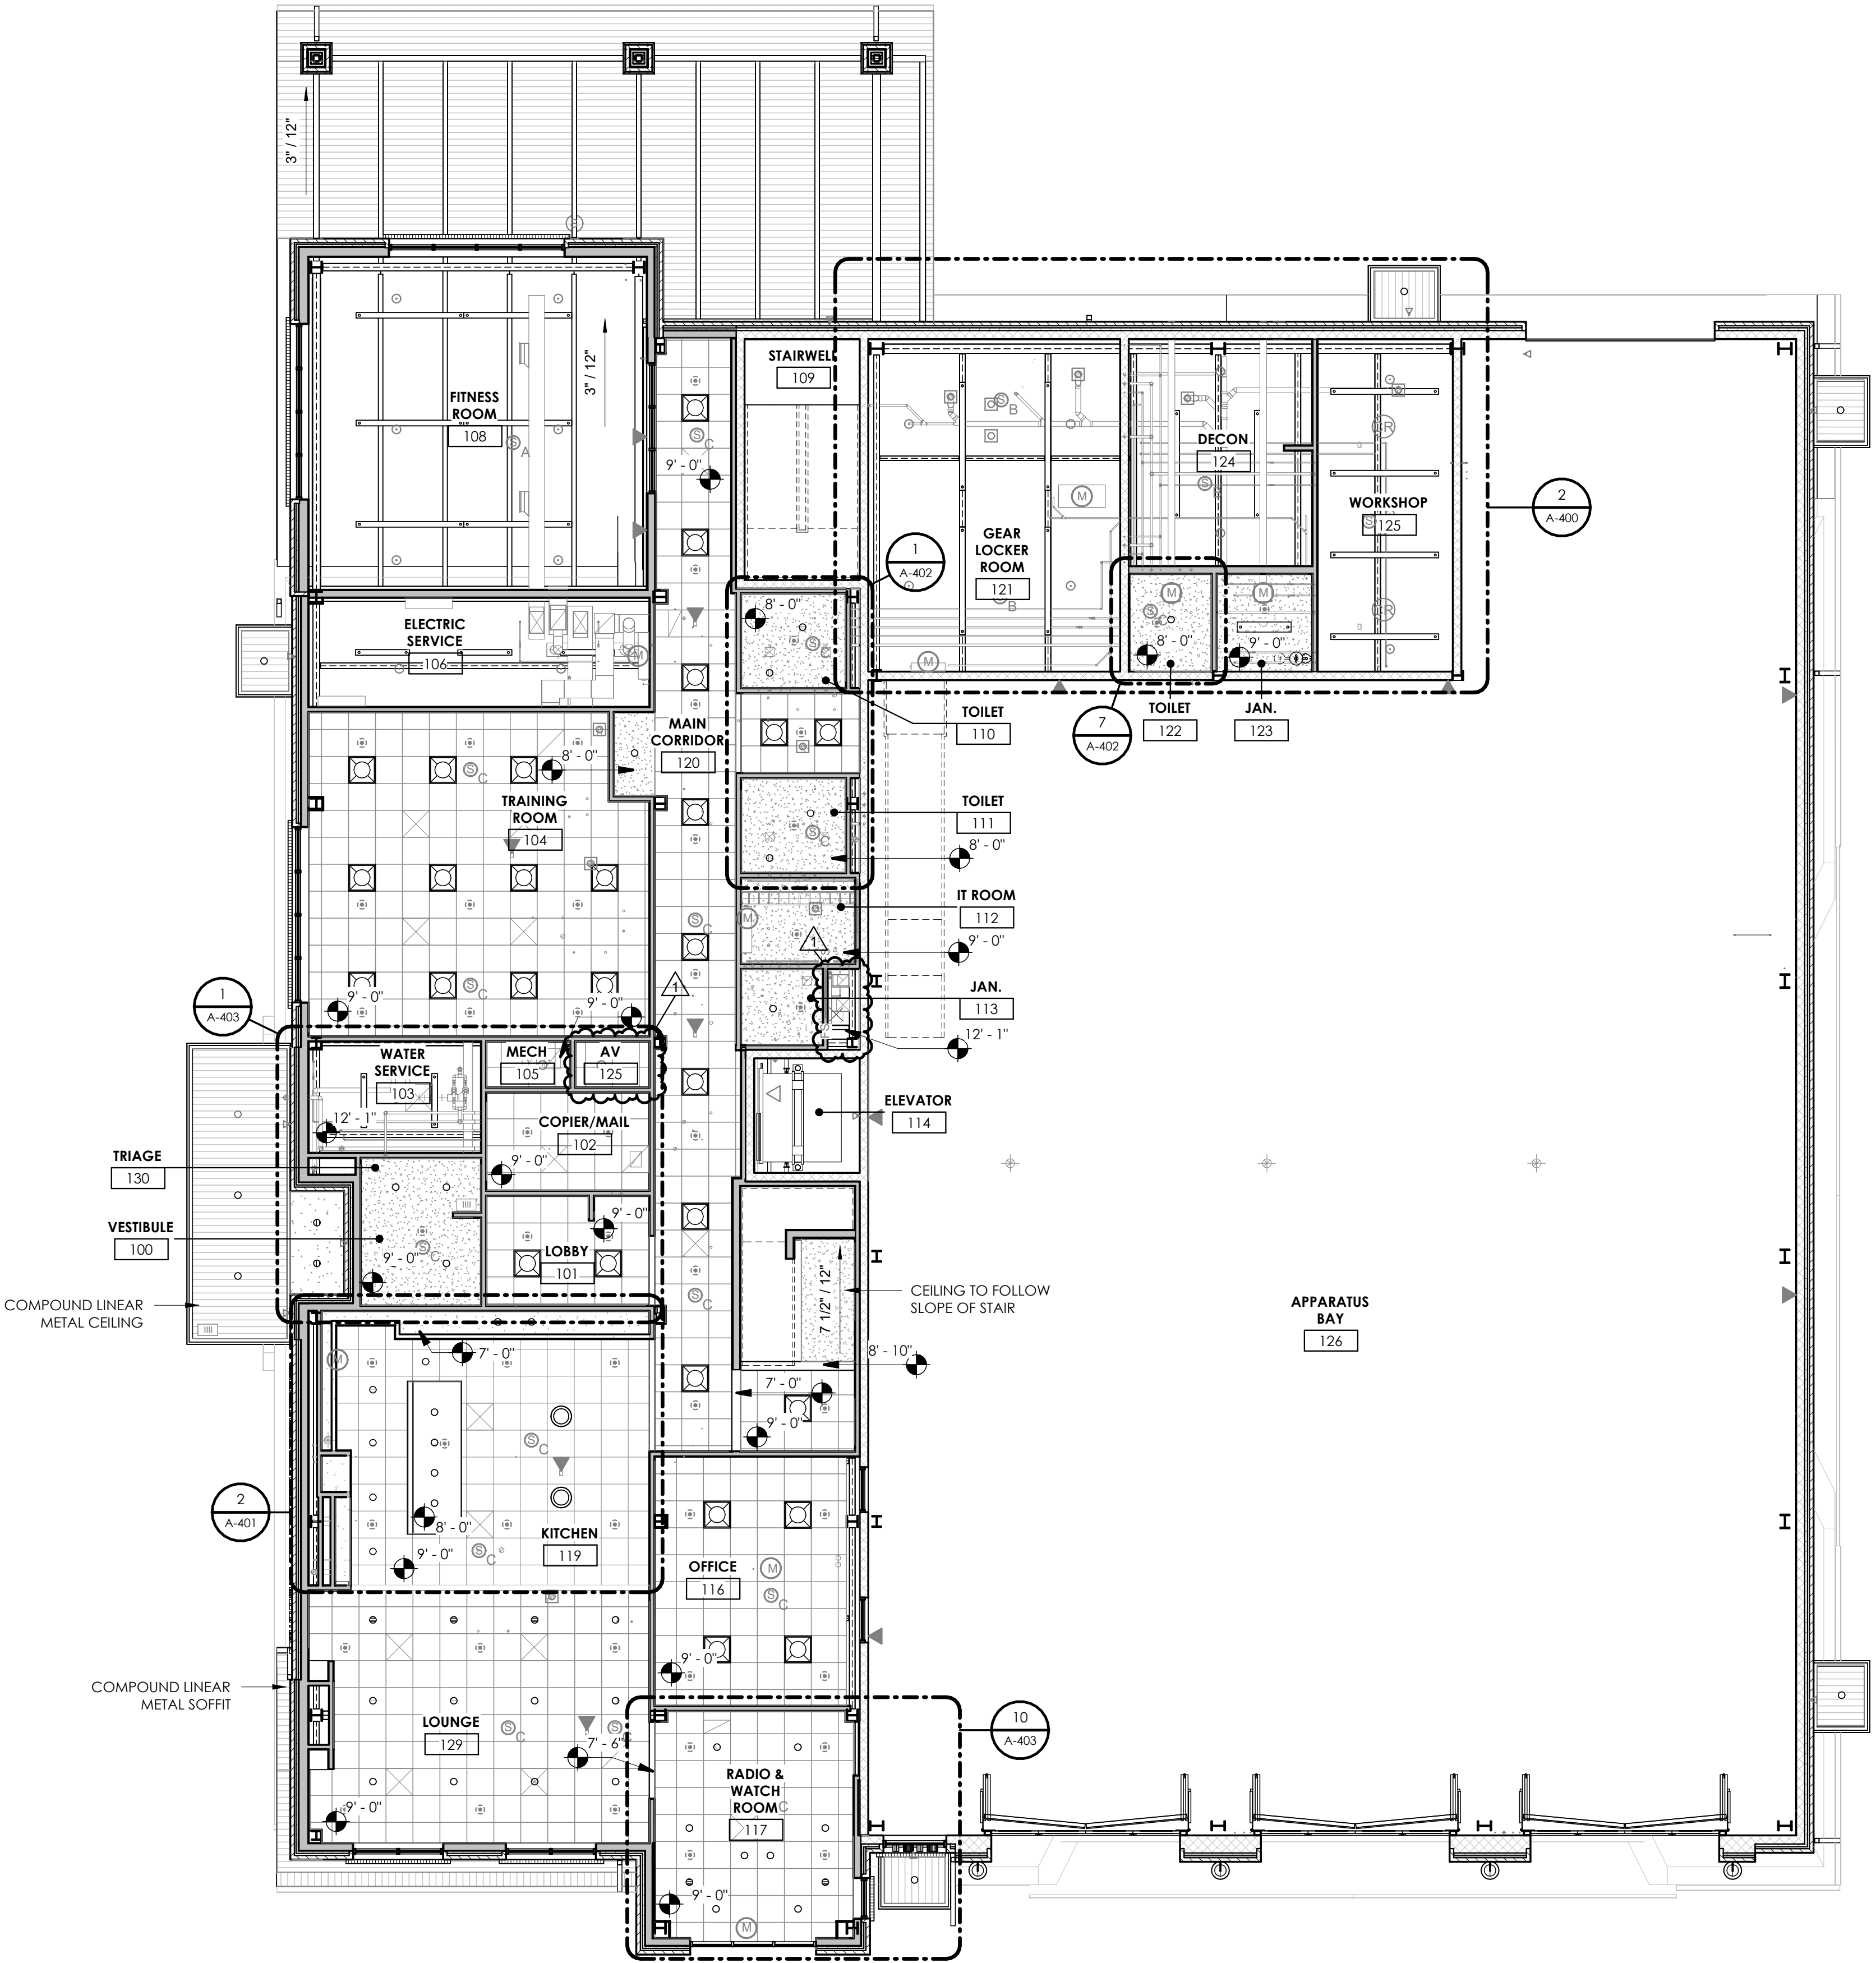

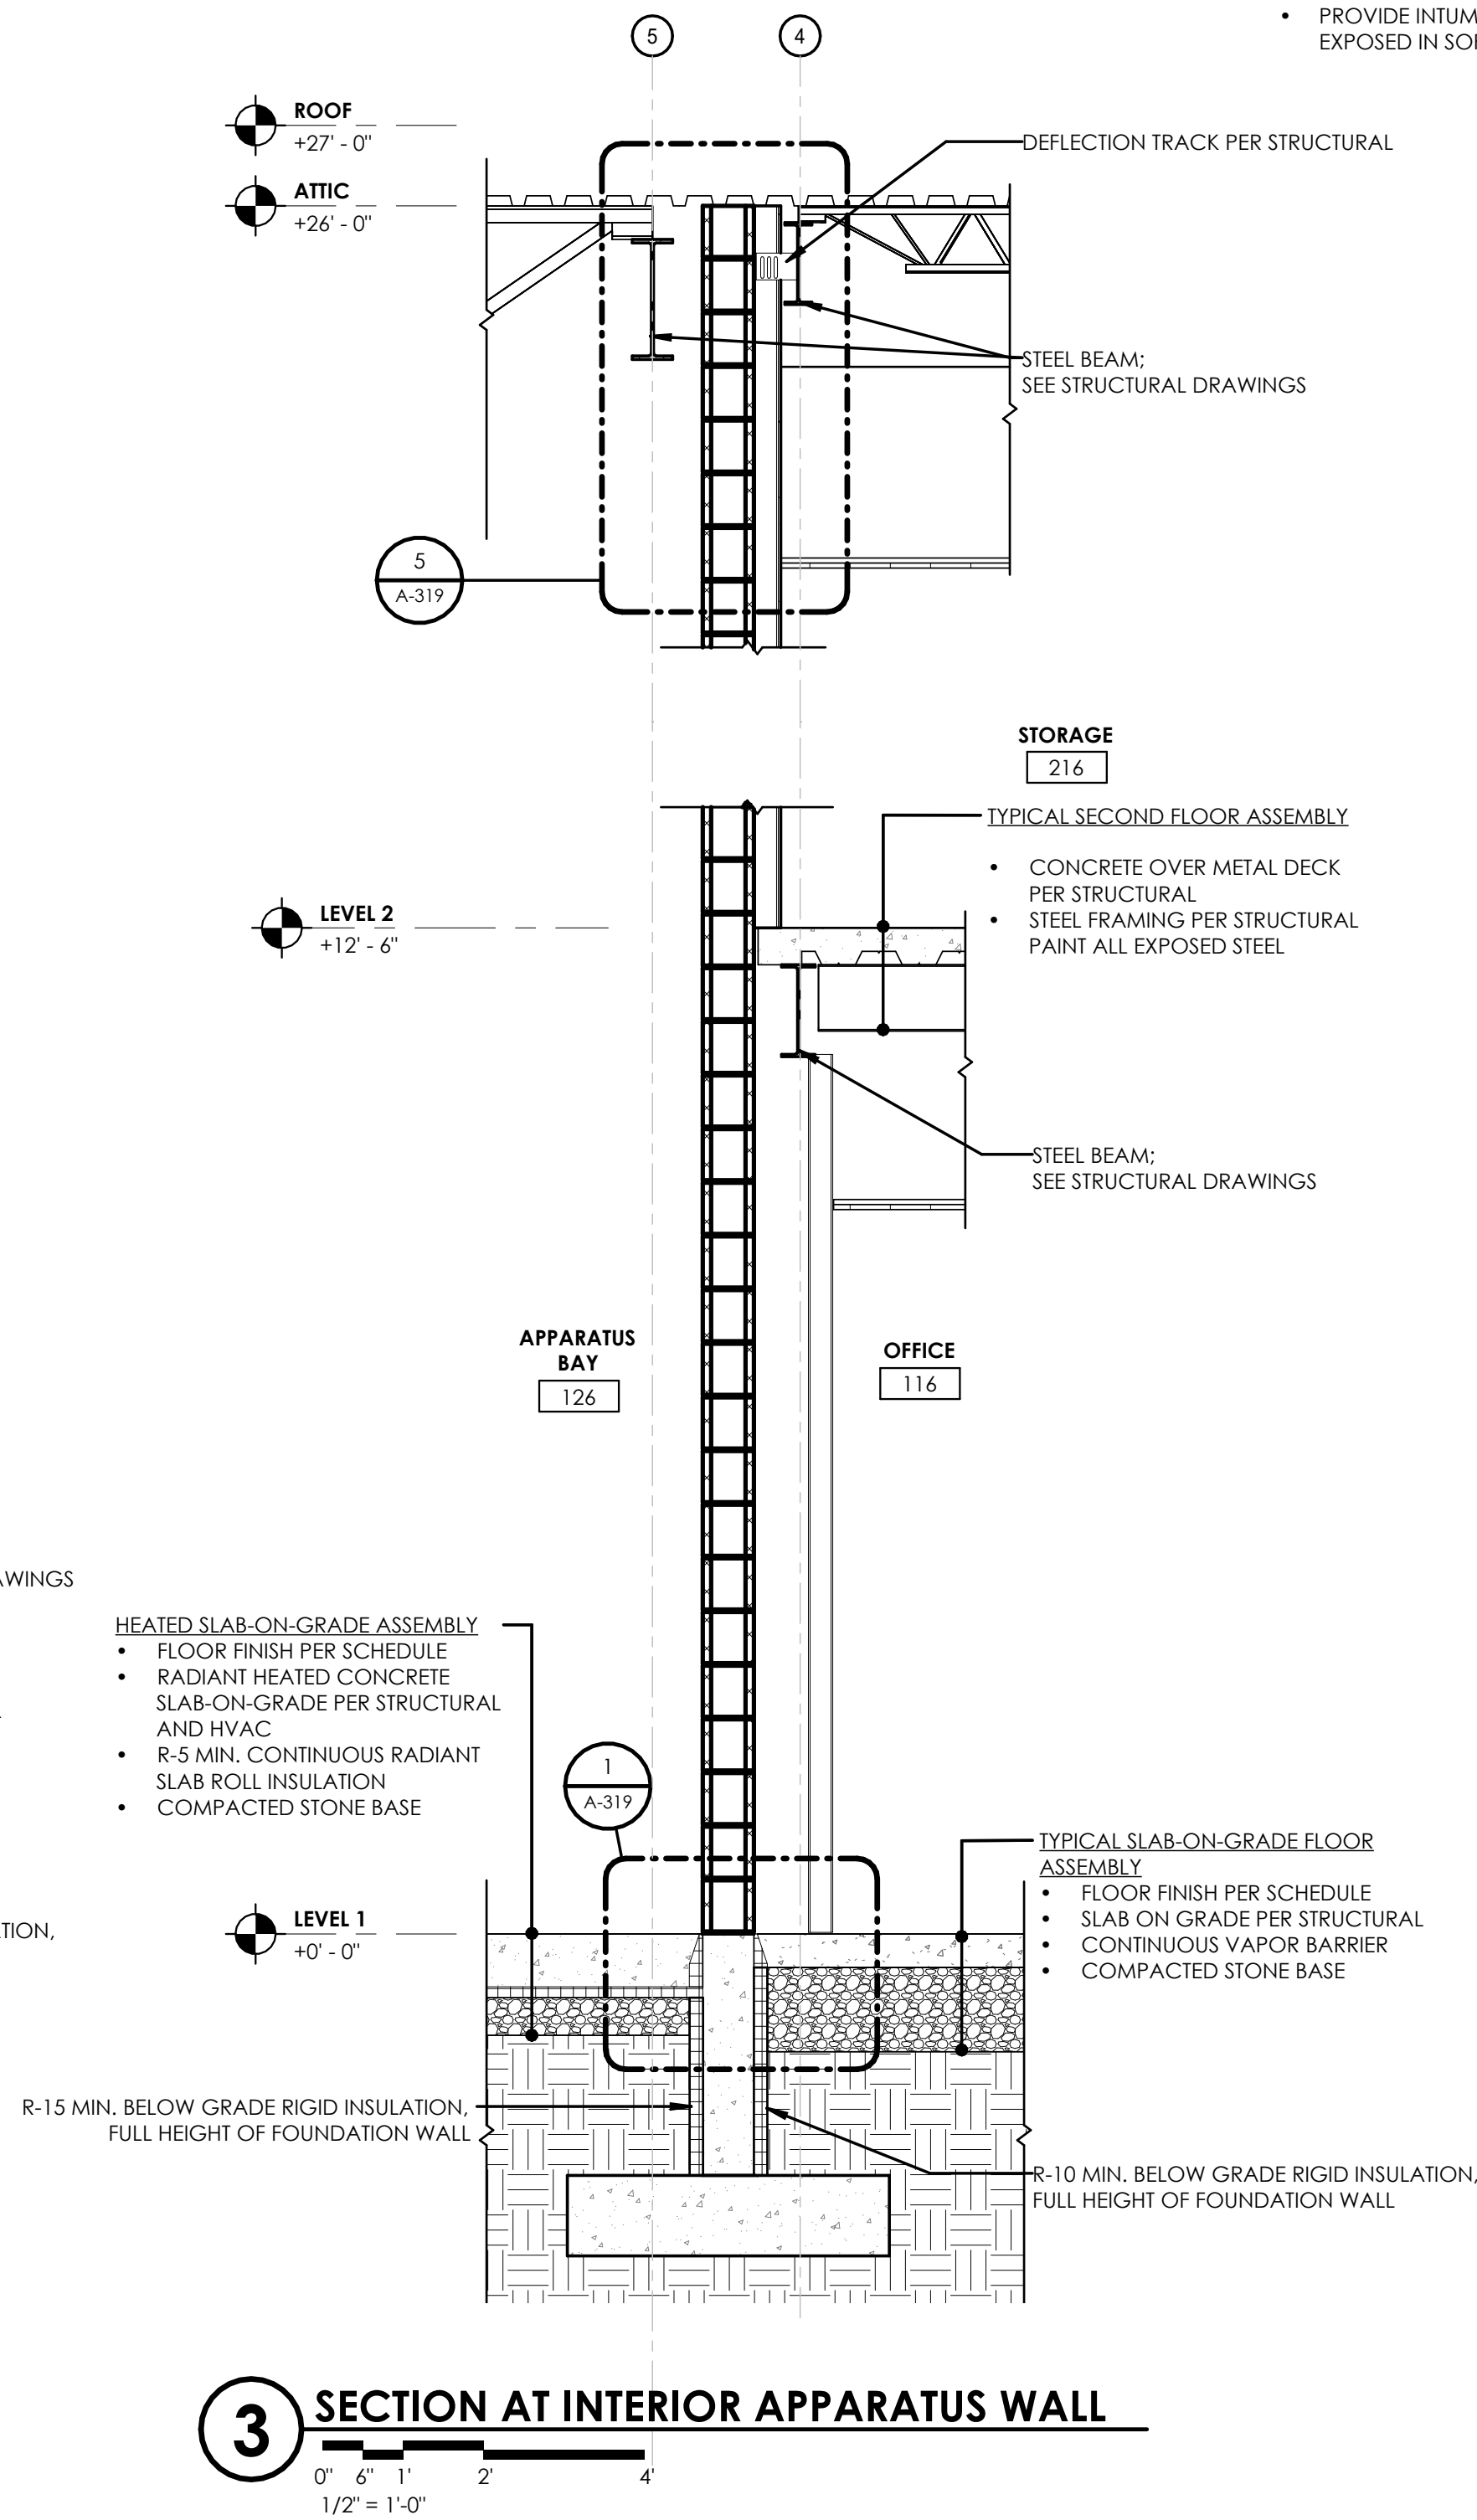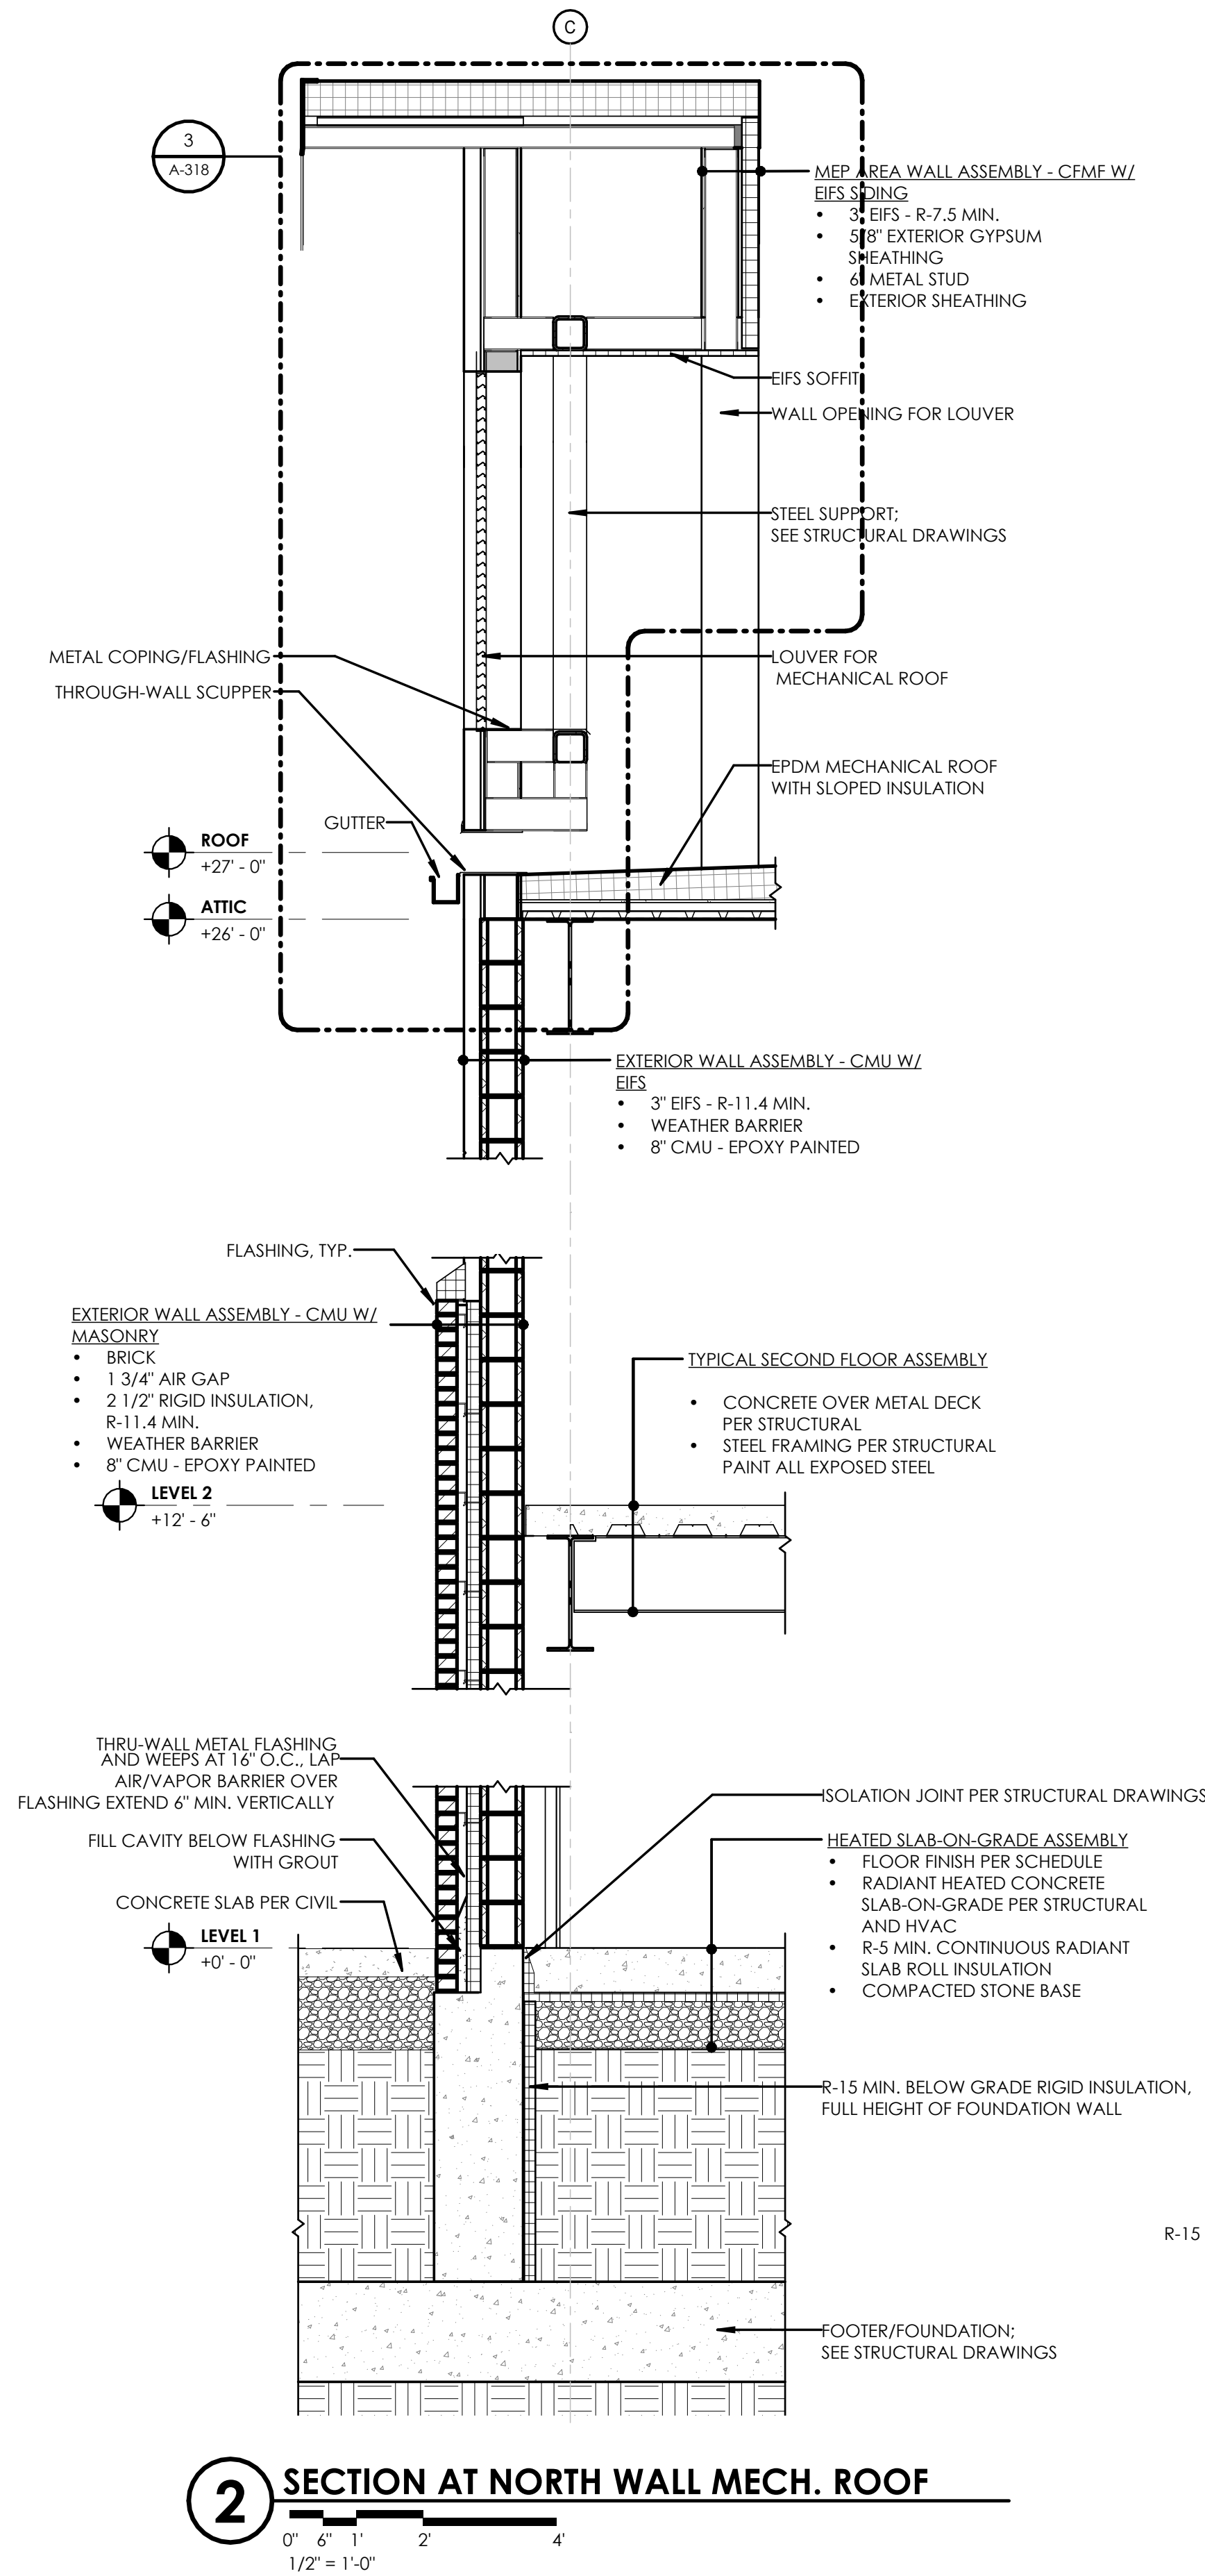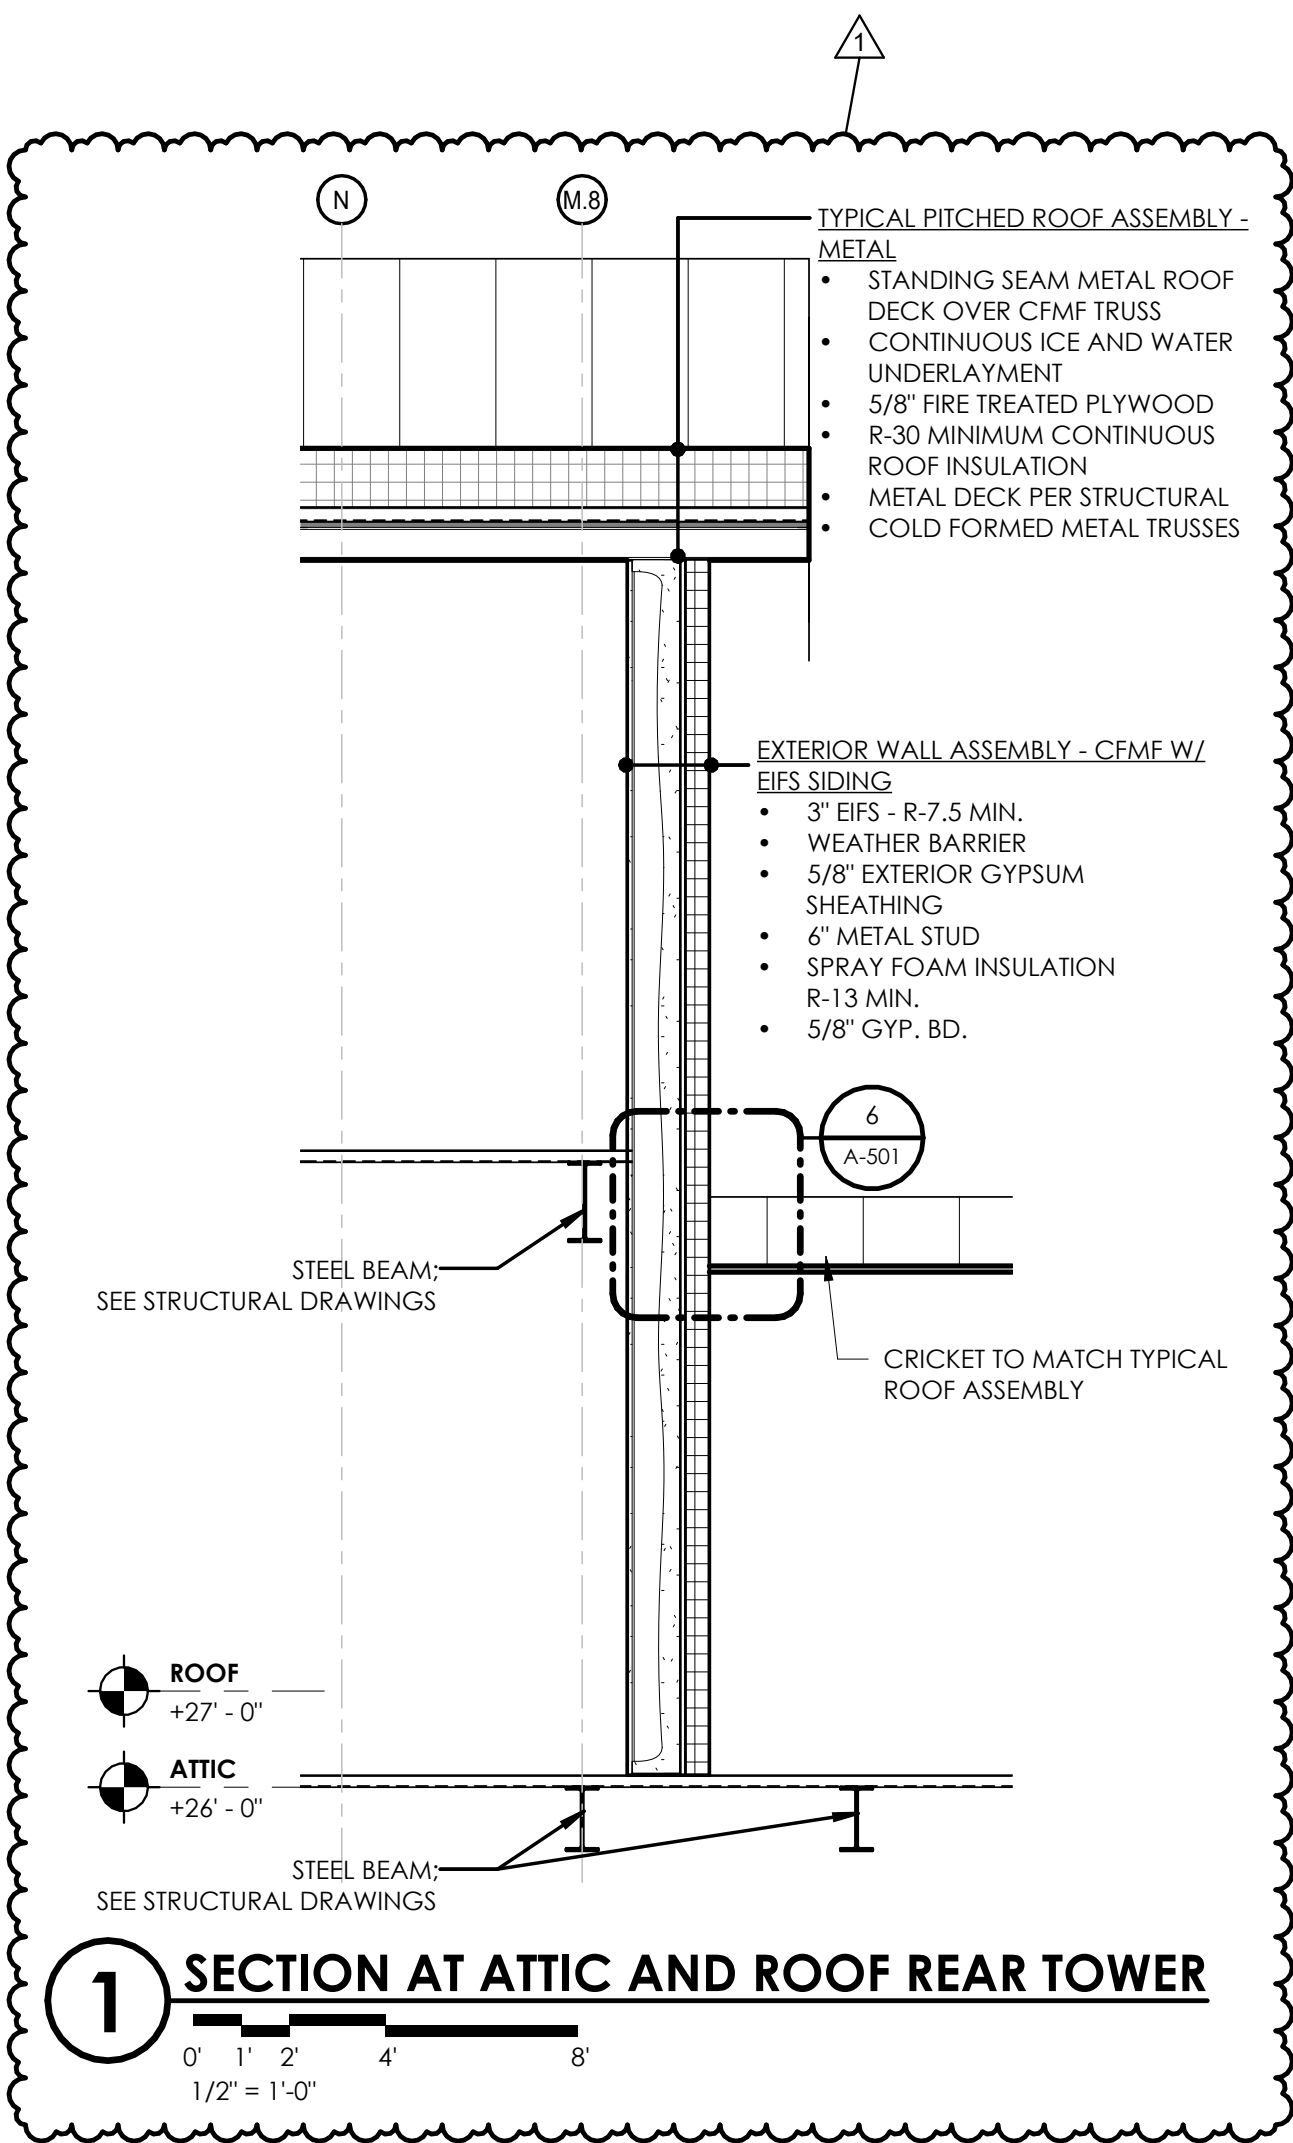

WALL SECTION GENERAL NOTES:

- THE CONTRACTOR SHALL REVIEW ALL DIMENSIONS AND NOTIFY THE ARCHITECT OF ANY DISCREPANCIES PRIOR TO CONSTRUCTION.
- PROVIDE THROUGH WALL FLASHING WITHIN 4" - 8" FROM FINISHED GRADE WITH WEEPS AT 16" MAXIMUM ON CENTER, MINIMUM OF (2) PER RUN AT ALL EXTERIOR MASONRY WALLS.
- ALL FLASHING SHALL EXTEND SHINGLES STYLE BEHIND THE DRAINAGE PLANE OF THE WALL SYSTEM AND SHALL SHINGLE TO DAYLIGHT. FLASHING AT FLUID APPLIED MEMBRANES SHALL BE INTEGRATED PER MEMBRANE MANUFACTURER'S RECOMMENDATIONS.
- PROVIDE FLASHING AT ALL ROOF/WALL INTERSECTIONS (MIN. 6" EACH WAY) WITH KICKOUT FLASHING AT THE LOW END OF EACH RUN TO DIVERT WATER AWAY FROM WALL WHEN THE WALL CONTINUES BELOW THE EAVE.
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- PROVIDE INTUMESCENT COATING ON ALL SPRAY FOAM AREAS EXPOSED IN SOFFIT CAVITIES.

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WALL SECTIONS

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NGFD - ENGLISH ROAD
STATION
TOWN/CITY: GREECE


COUNTY: MONROE STATE: NY

PROJECT NO.:
20233530.0001

DRAWING NO.:
A-313

DATE:
JANUARY 22, 2025


BID SET

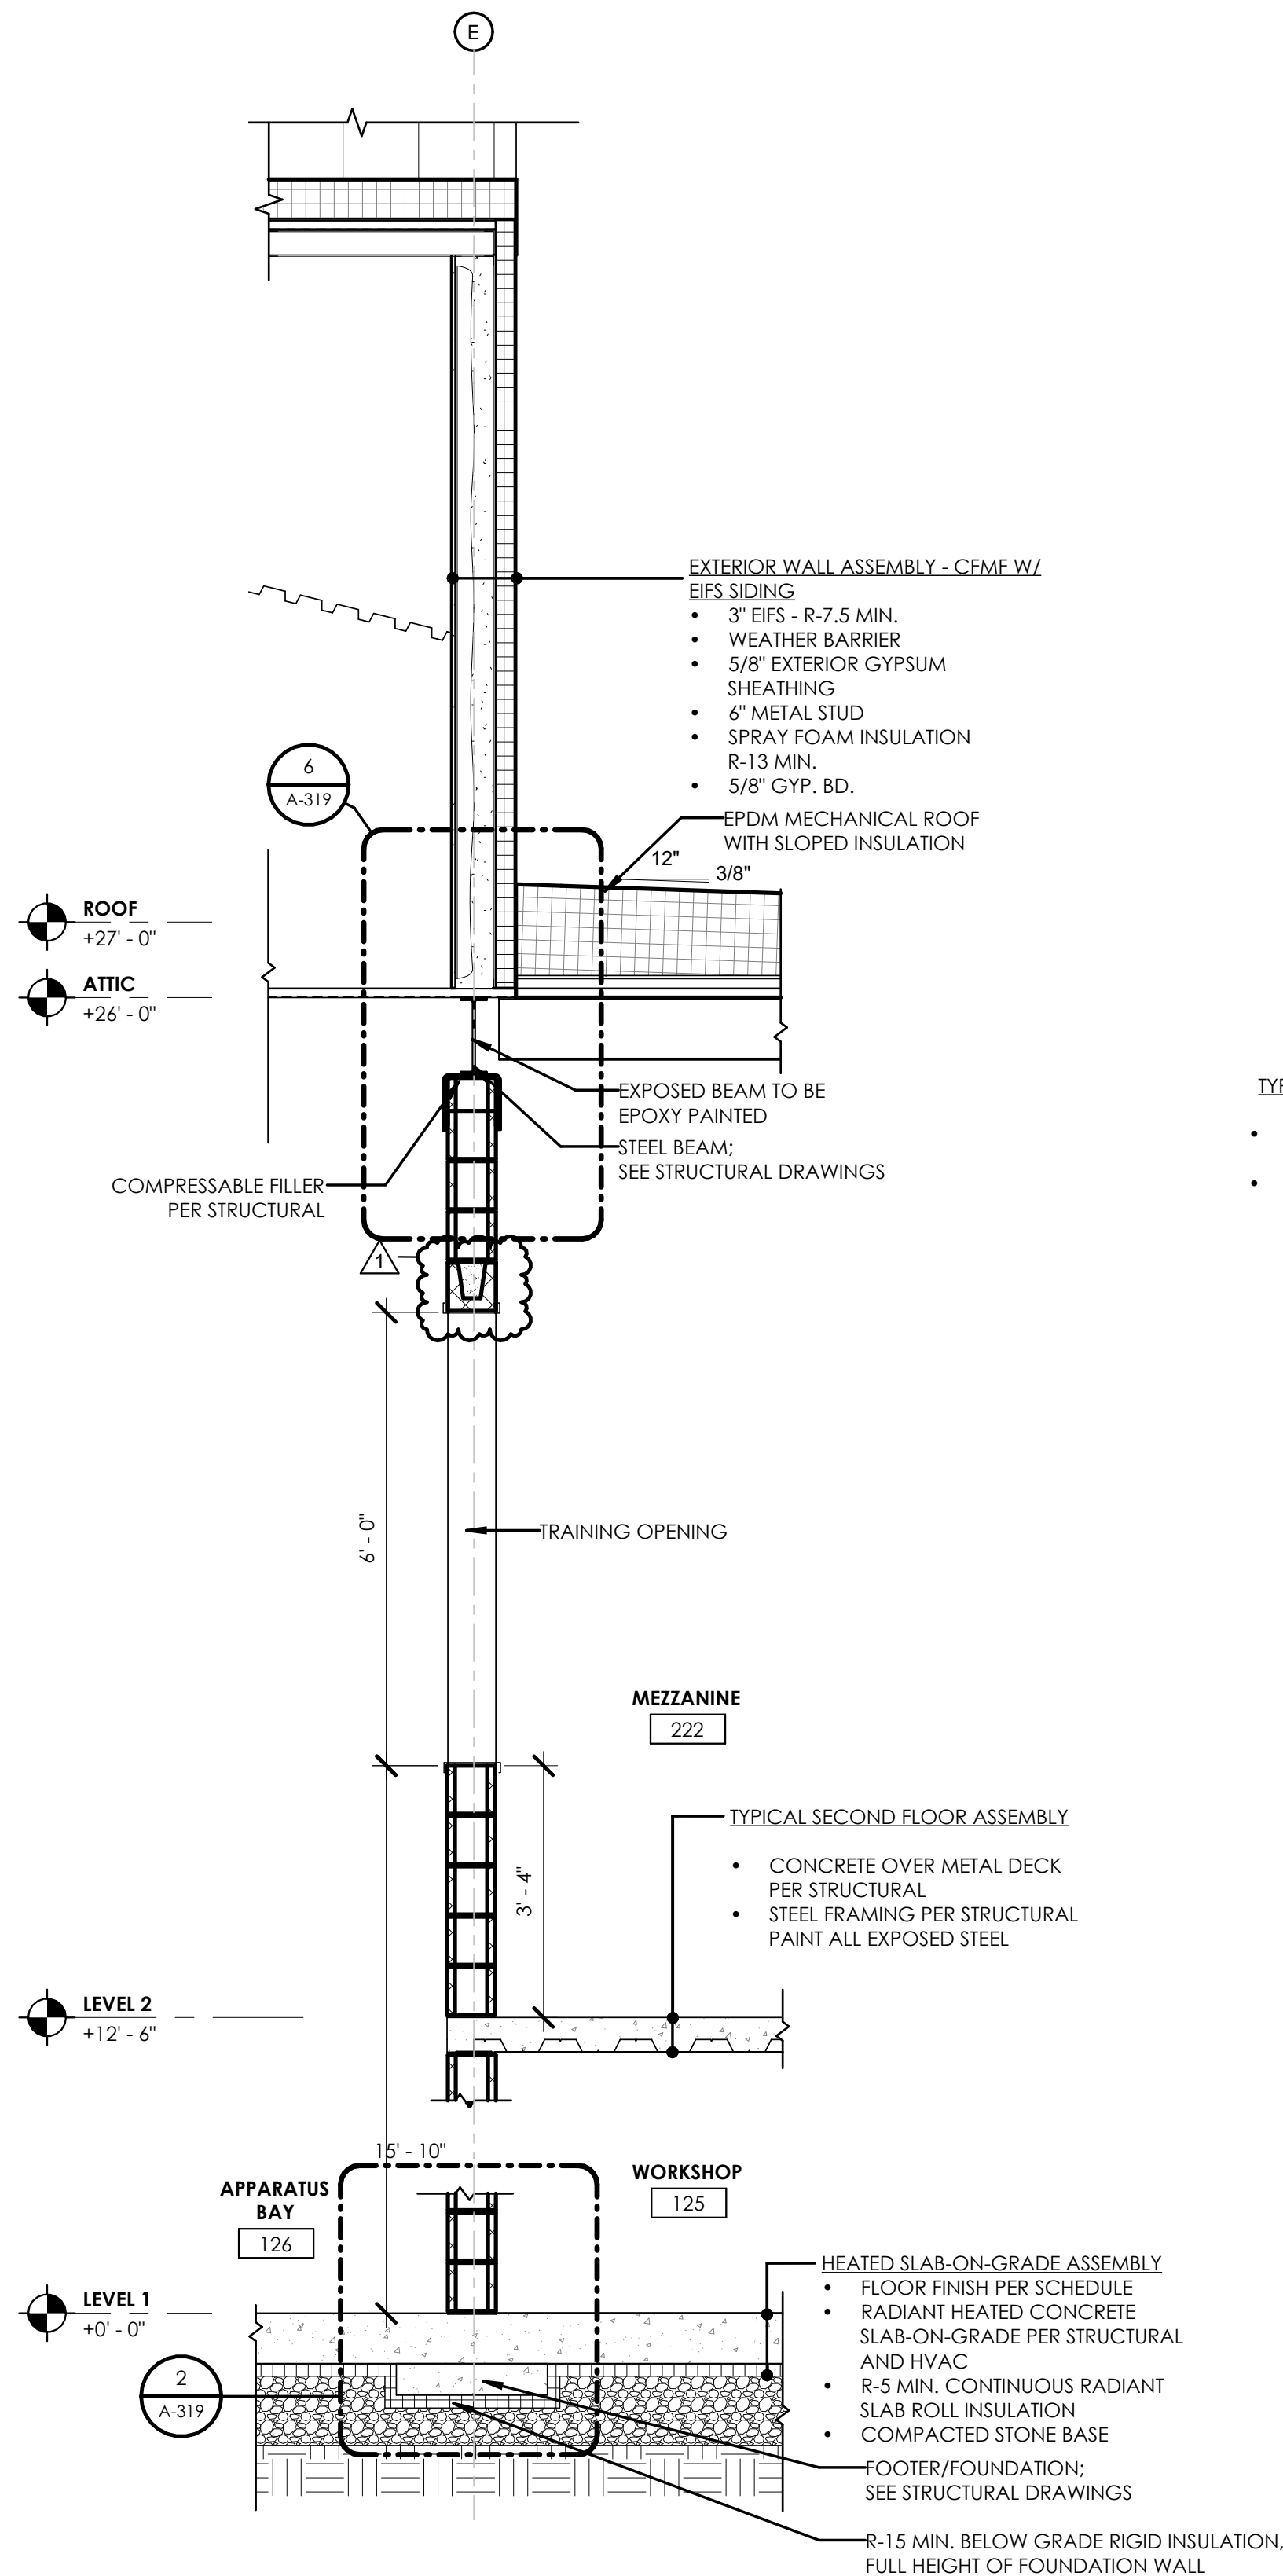

1 SECTION AT MEZZANINE

0' 6" 1' 2' 4'


1/2" = 1'-0"

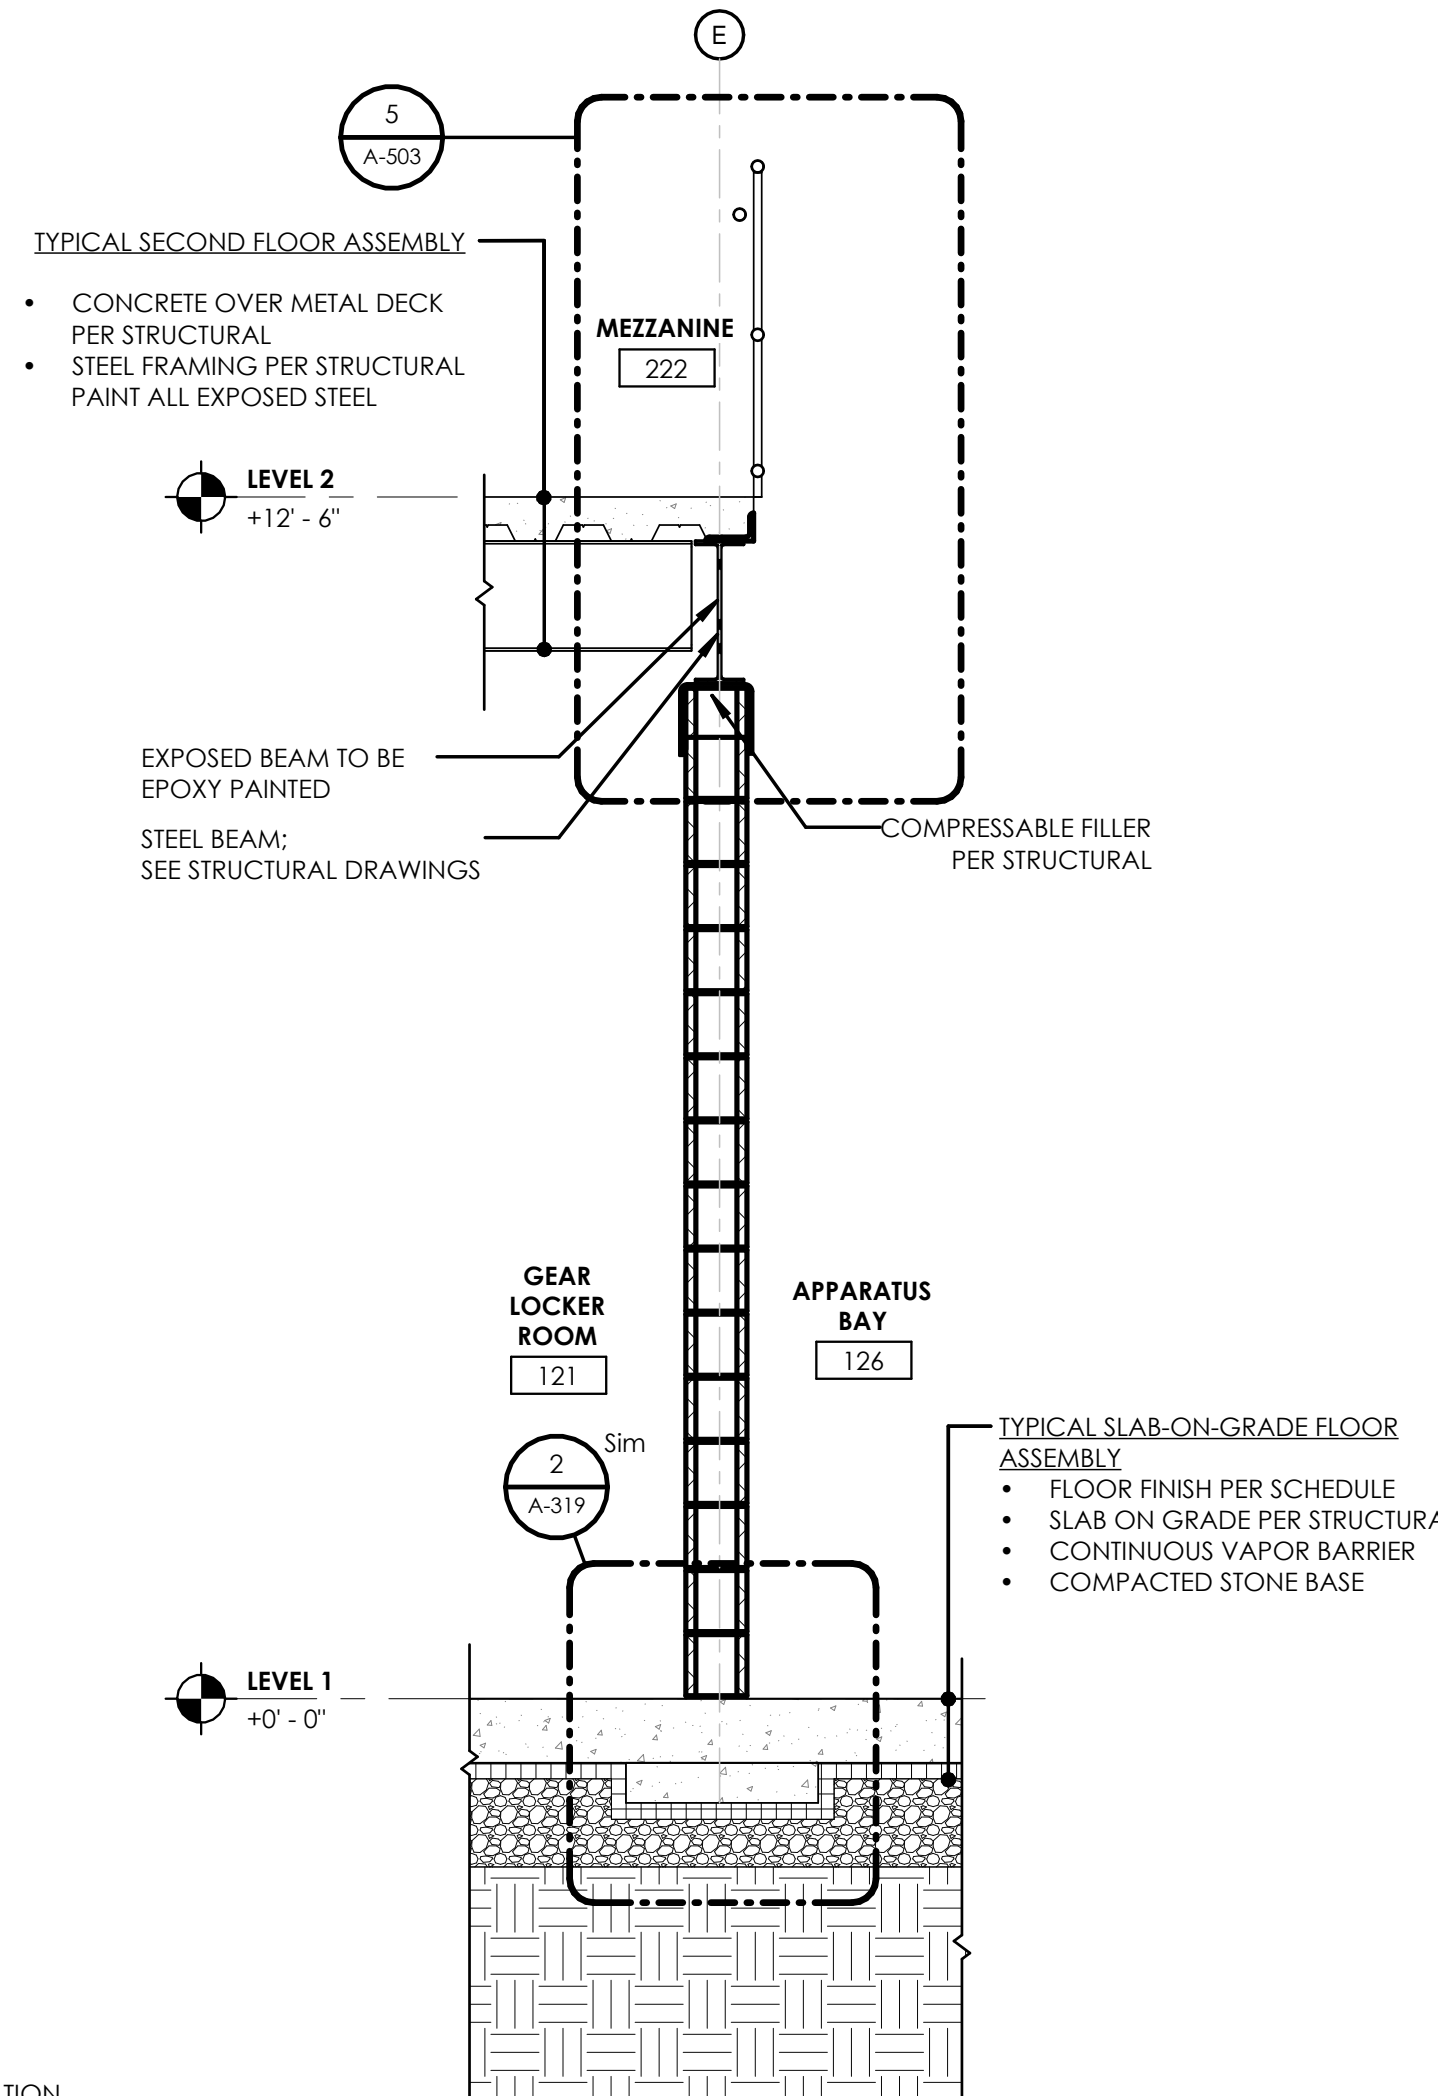

2 SECTION AT MEZZANINE RAILING

0' 6" 1' 2' 4'

1/2" = 1'-0"

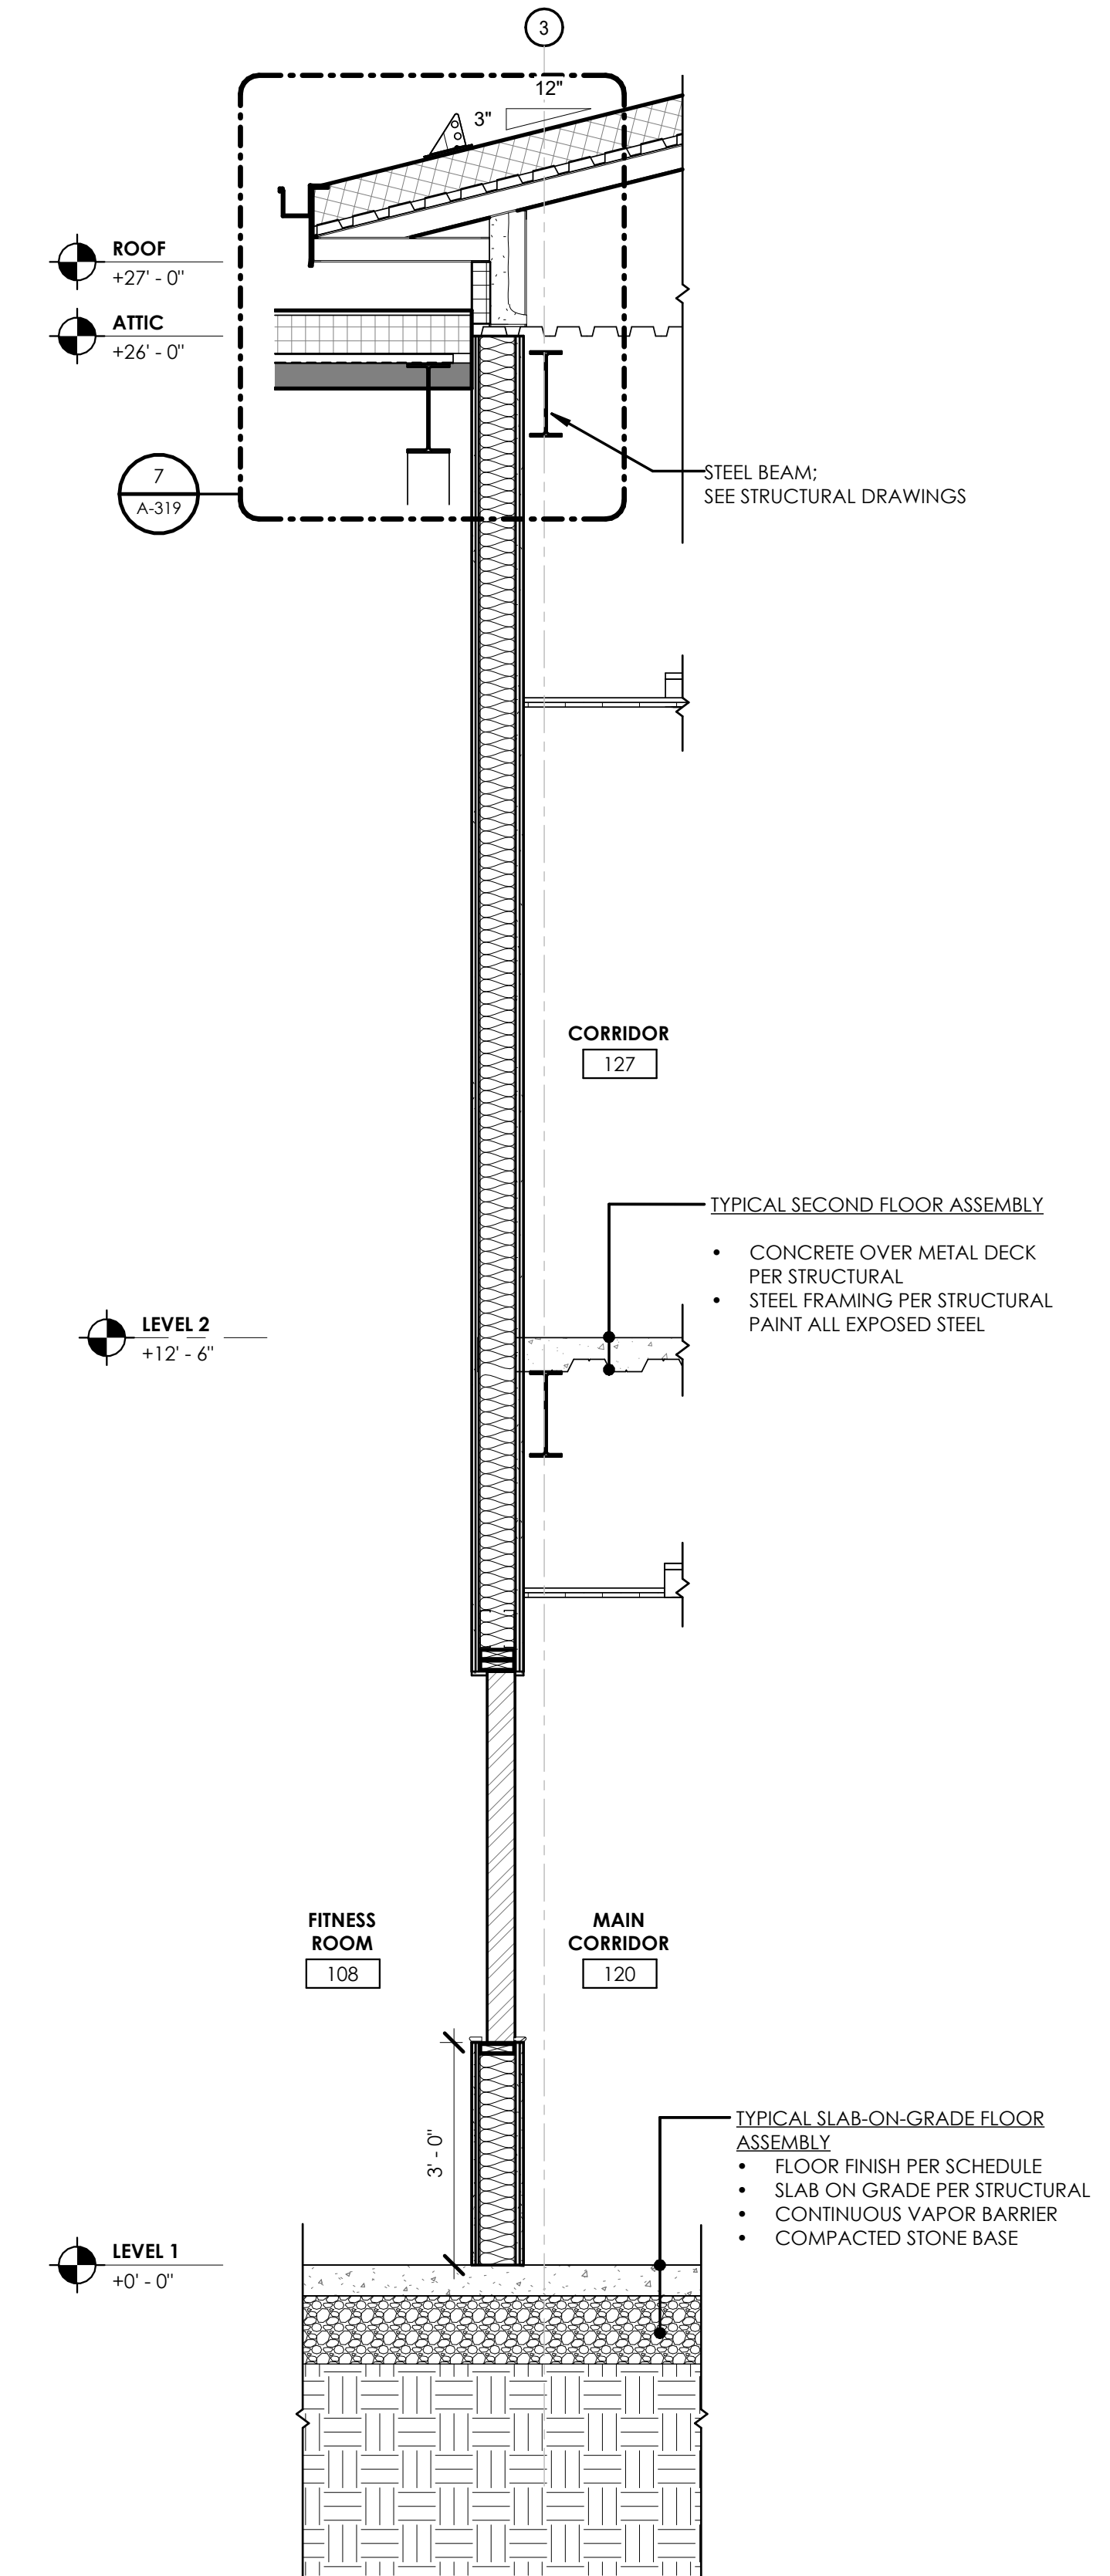

3 SECTION AT FITNESS ROOM CORRIDOR

0' 6" 1' 2' 4'

1/2" = 1'-0"

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WALL SECTIONS

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TOWN/CITY: GREECE




COUNTY: MONROE STATE: NY

PROJECT NO.: 20233530.0001

DRAWING NO.: A-314




DATE: JANUARY 22, 2025

BID SET

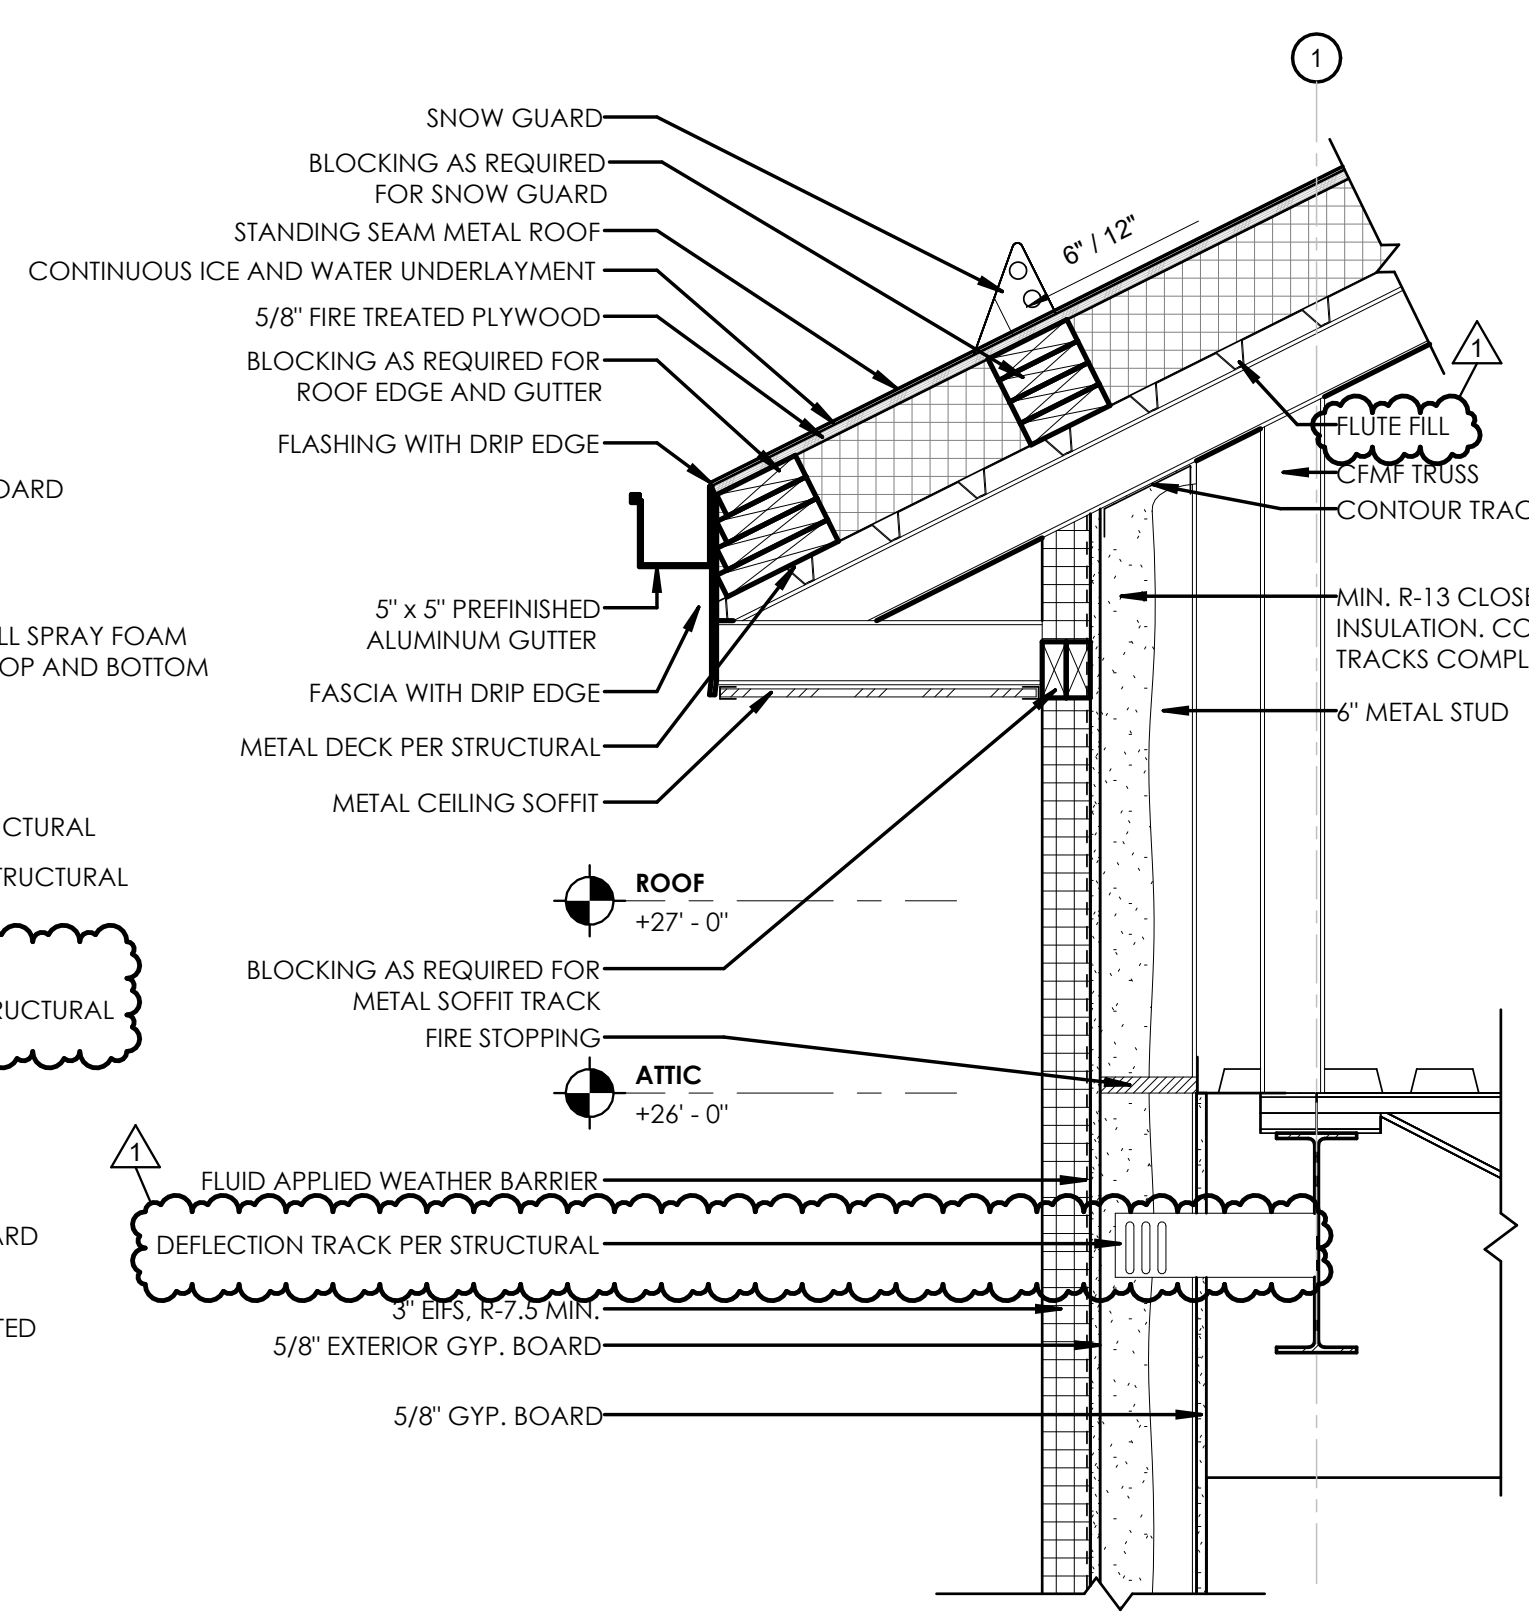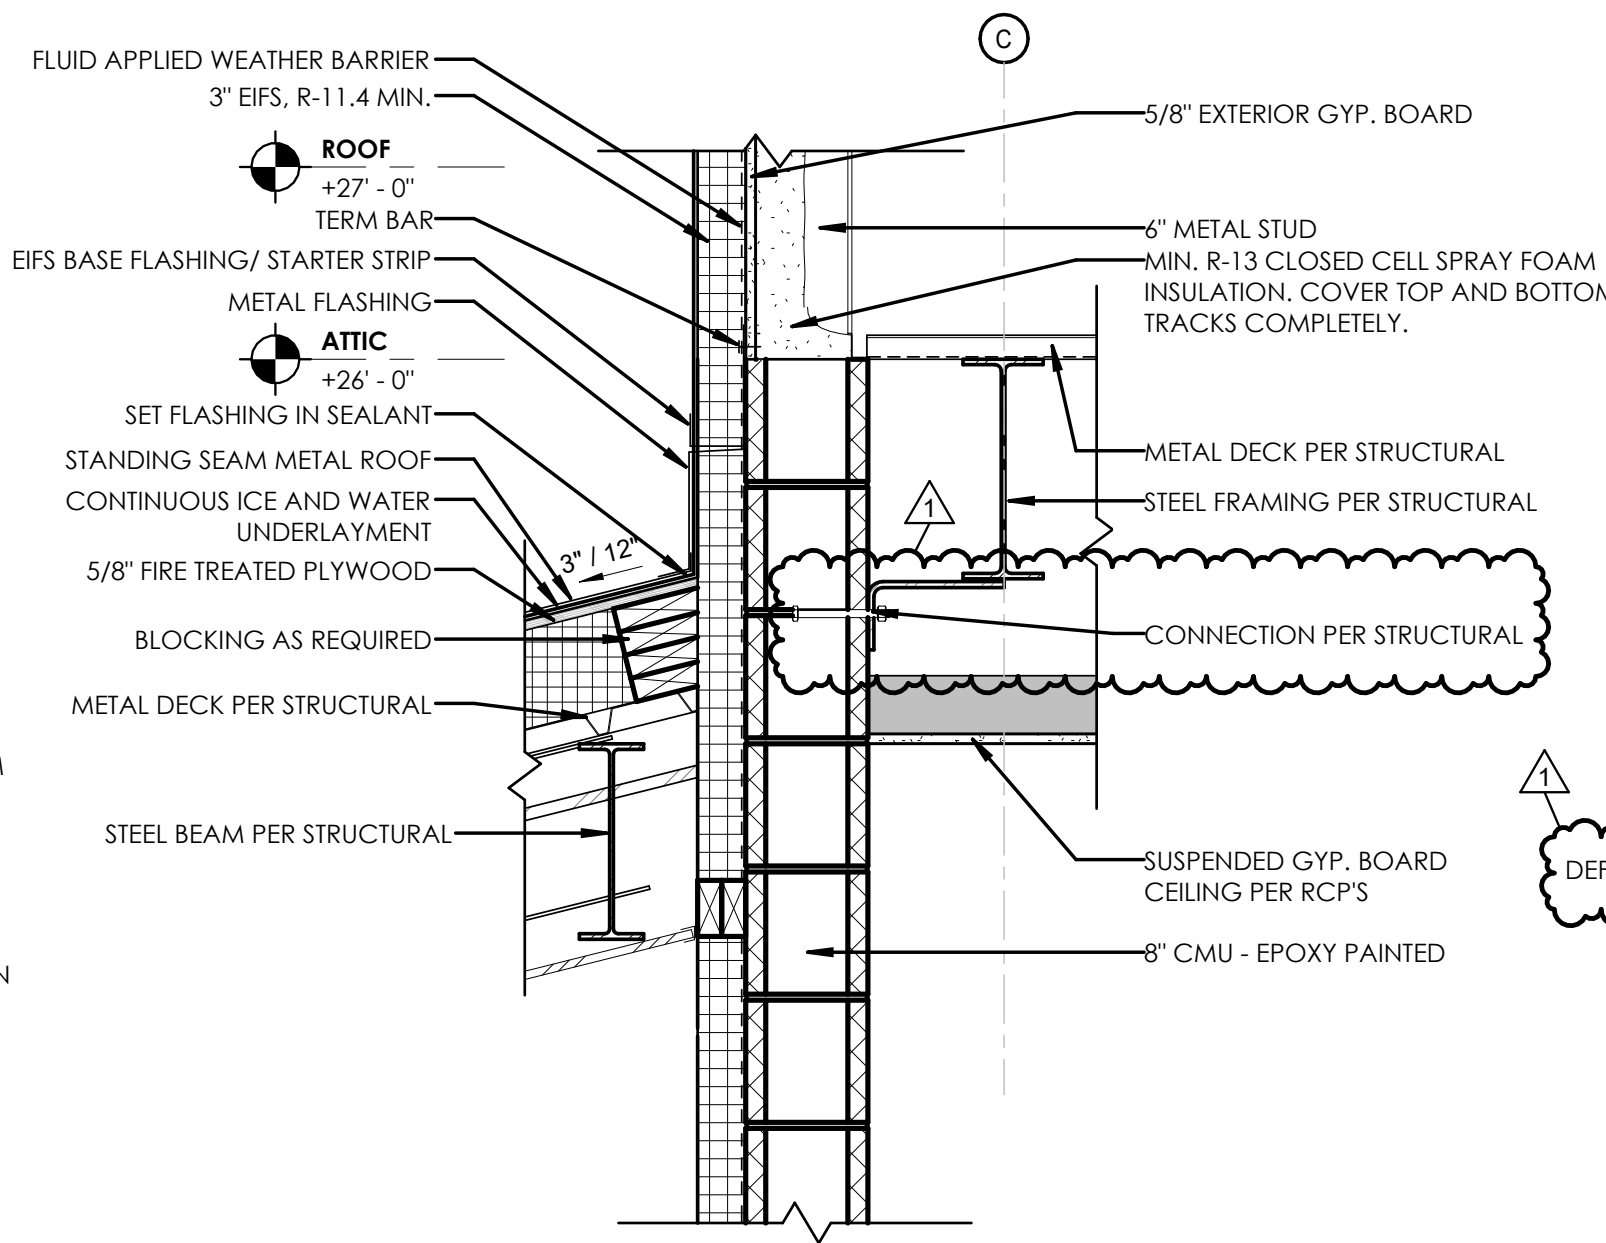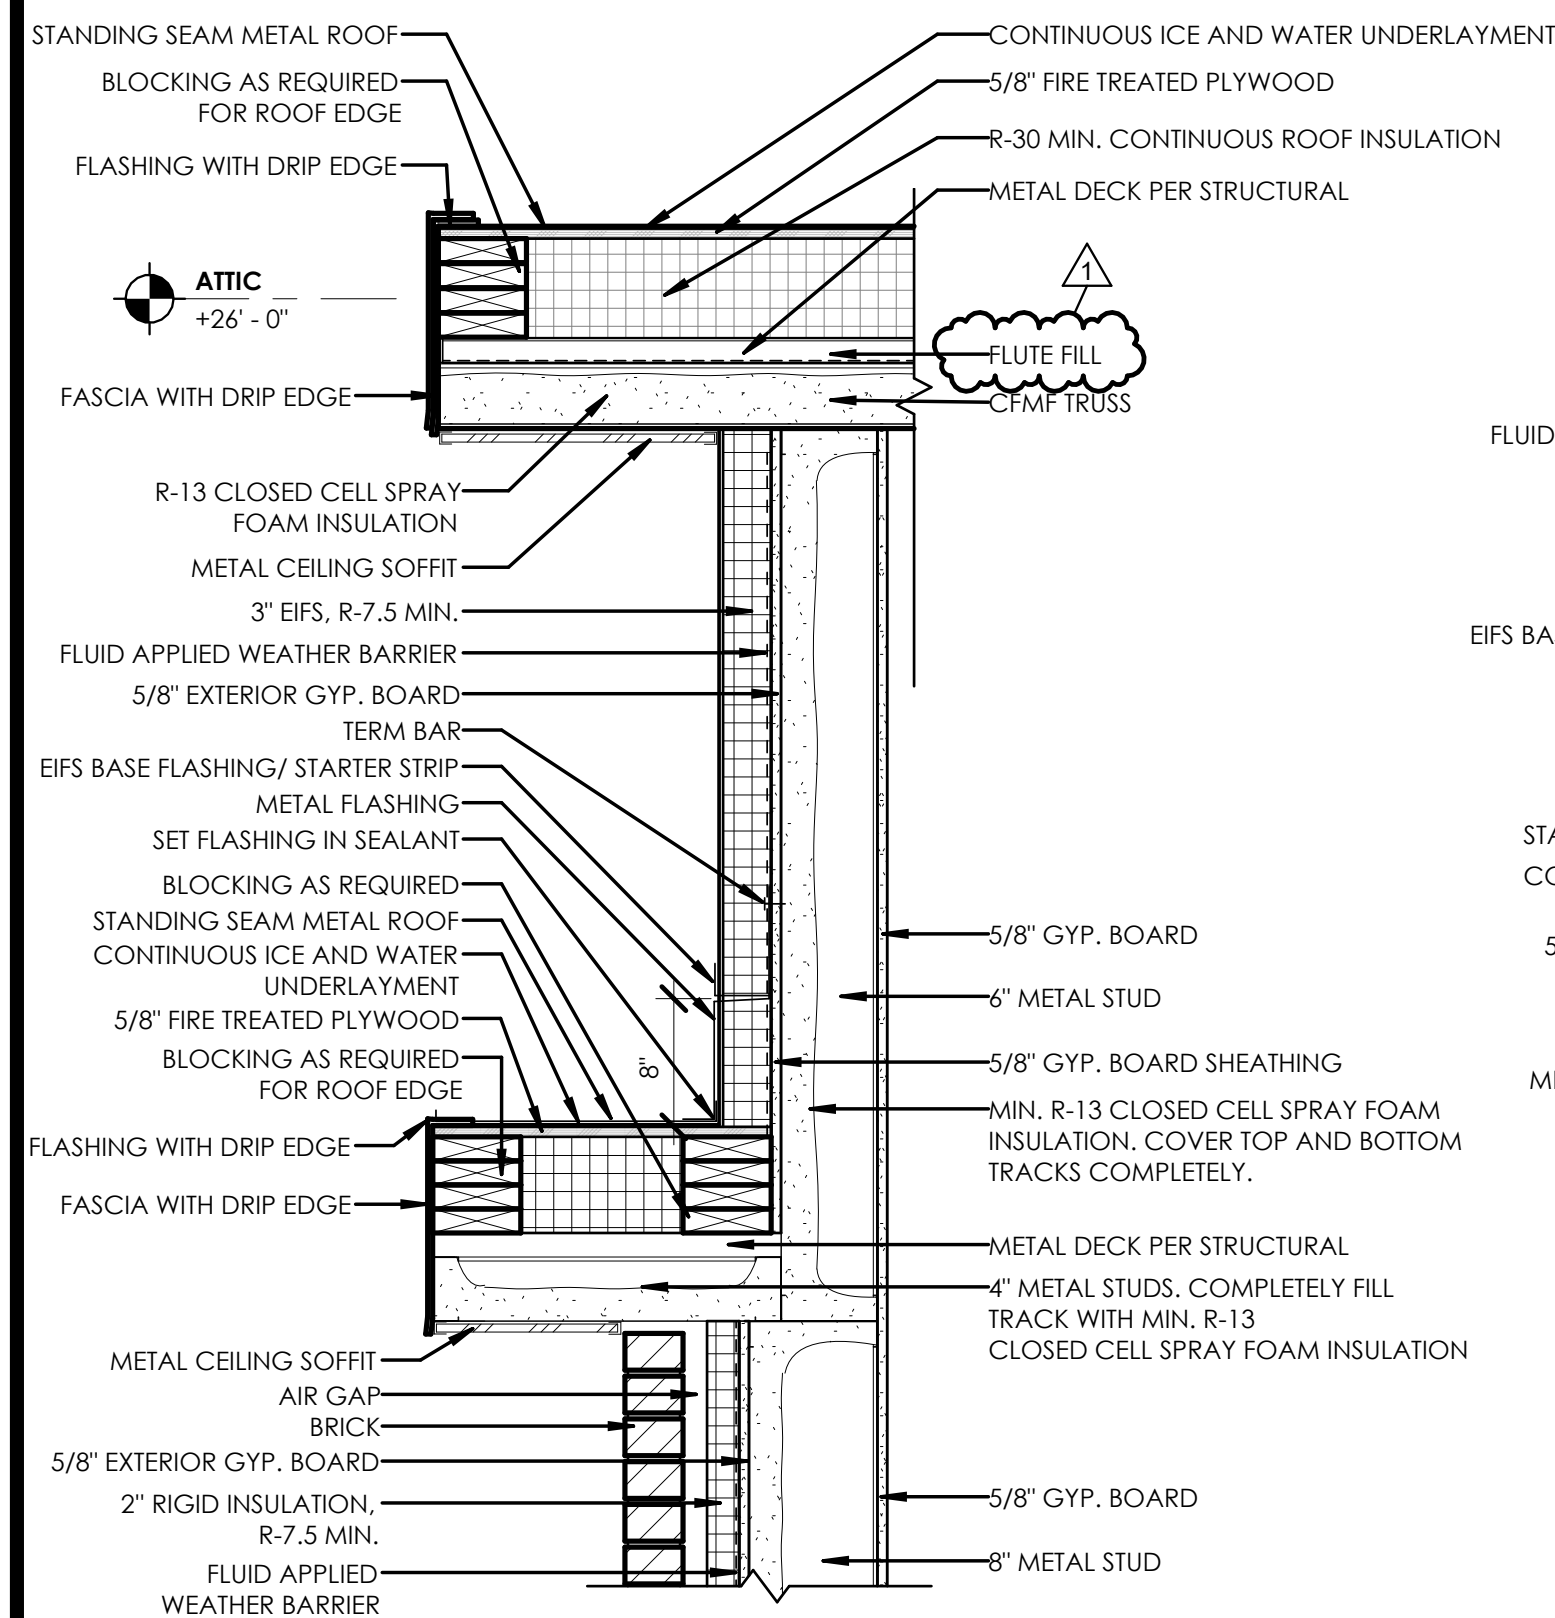

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- PROVIDE FLASHING AT ALL ROOF/WALL INTERSECTIONS [MIN. 4" EACH WAY] WITH KICKOUT FLASHING AT THE LOW END OF EACH RUN TO DIVERT WATER AWAY FROM WALL WHEN THE WALL CONTINUES BELOW THE EAVE.
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**BID SET**

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N. GREECE FIRE DISTRICT
1766 LATTA RD
ROCHESTER, NY 14612

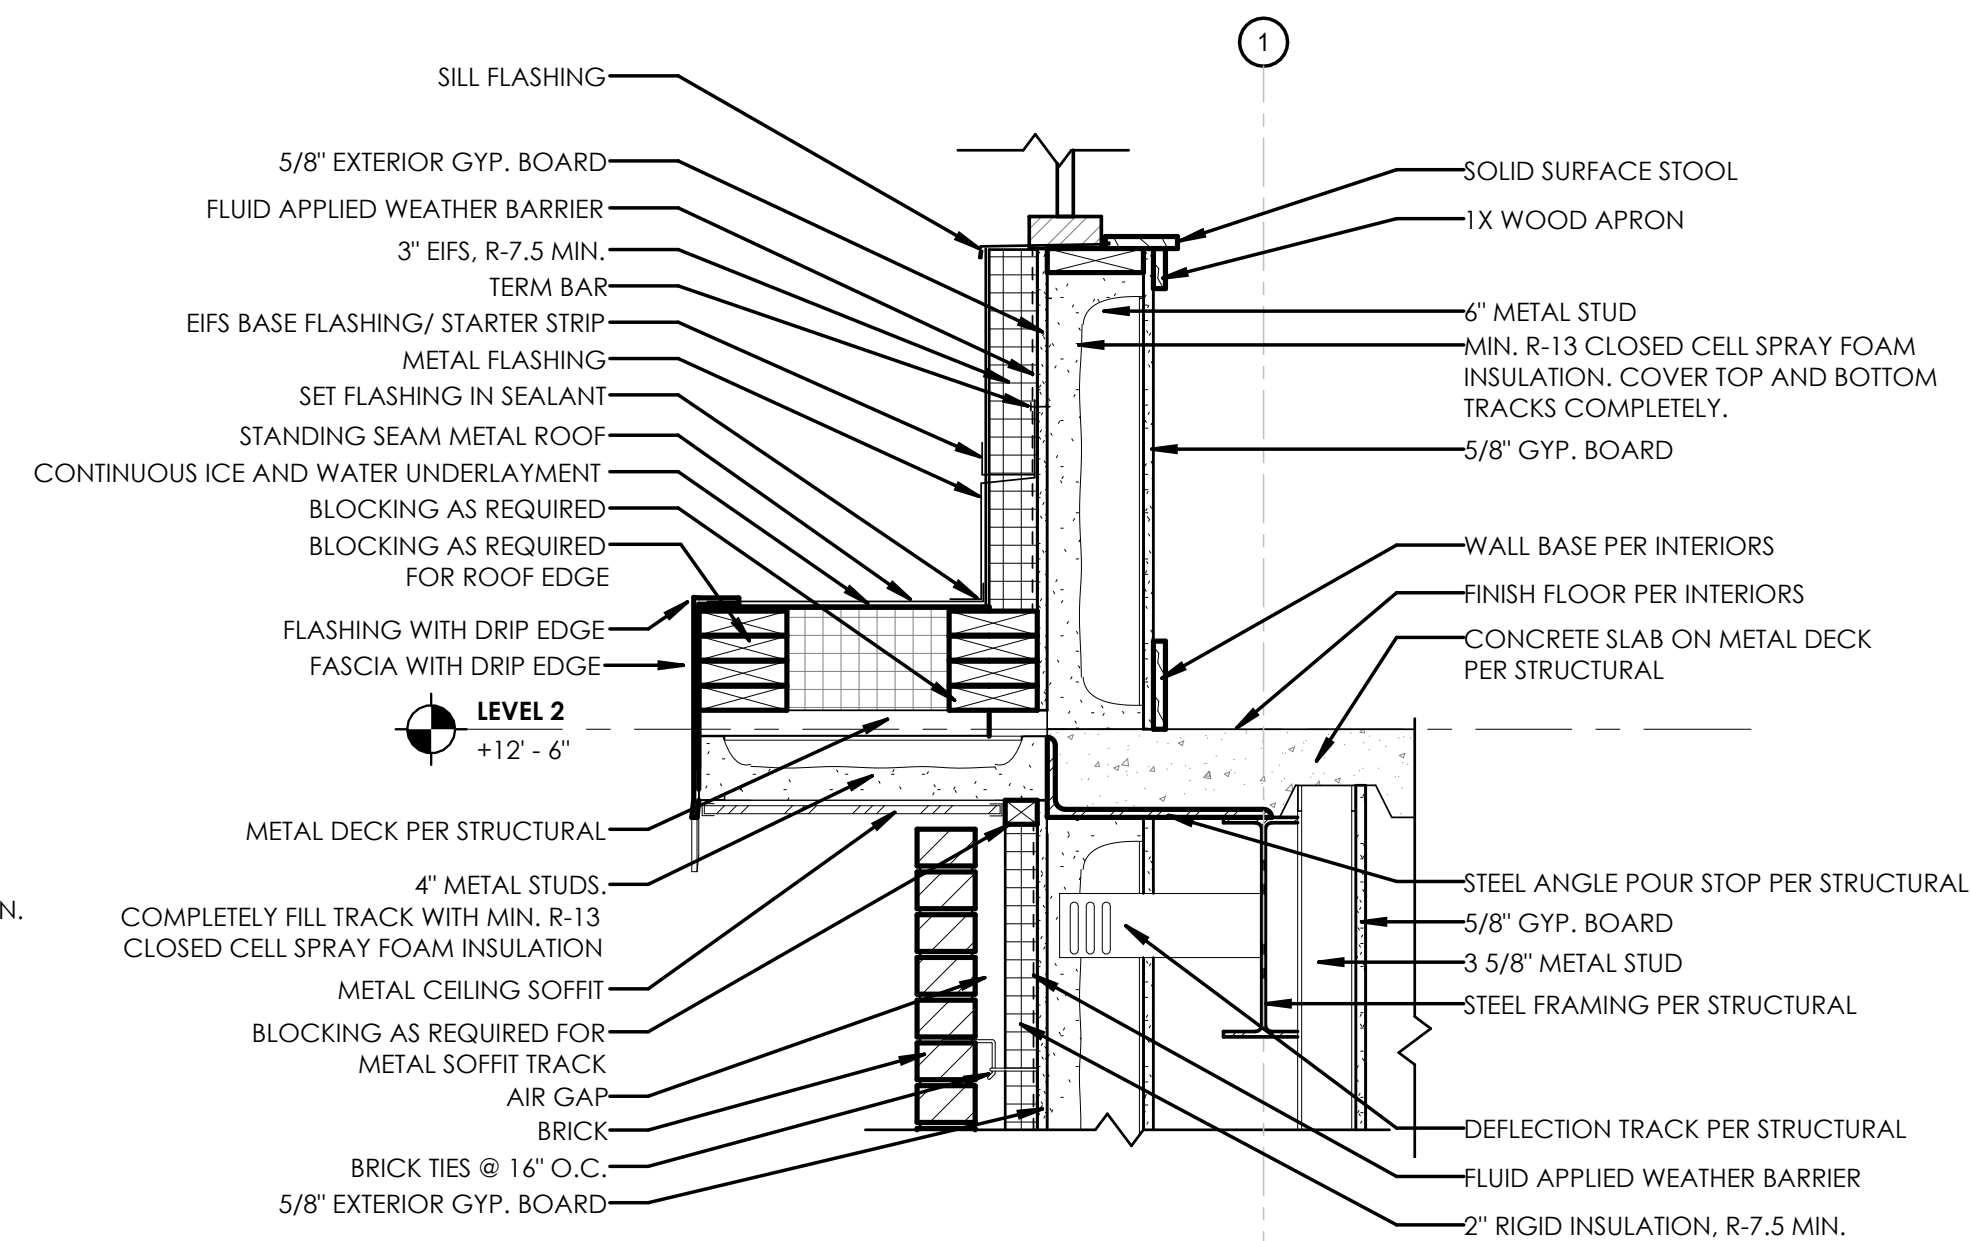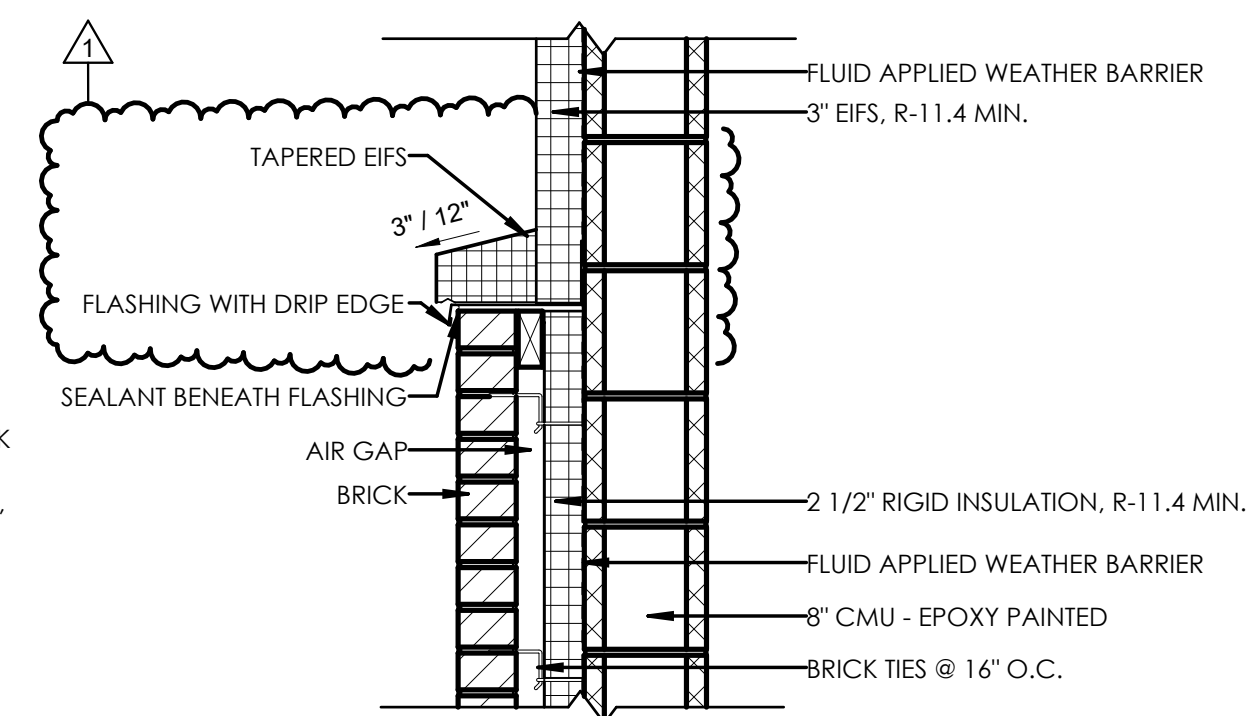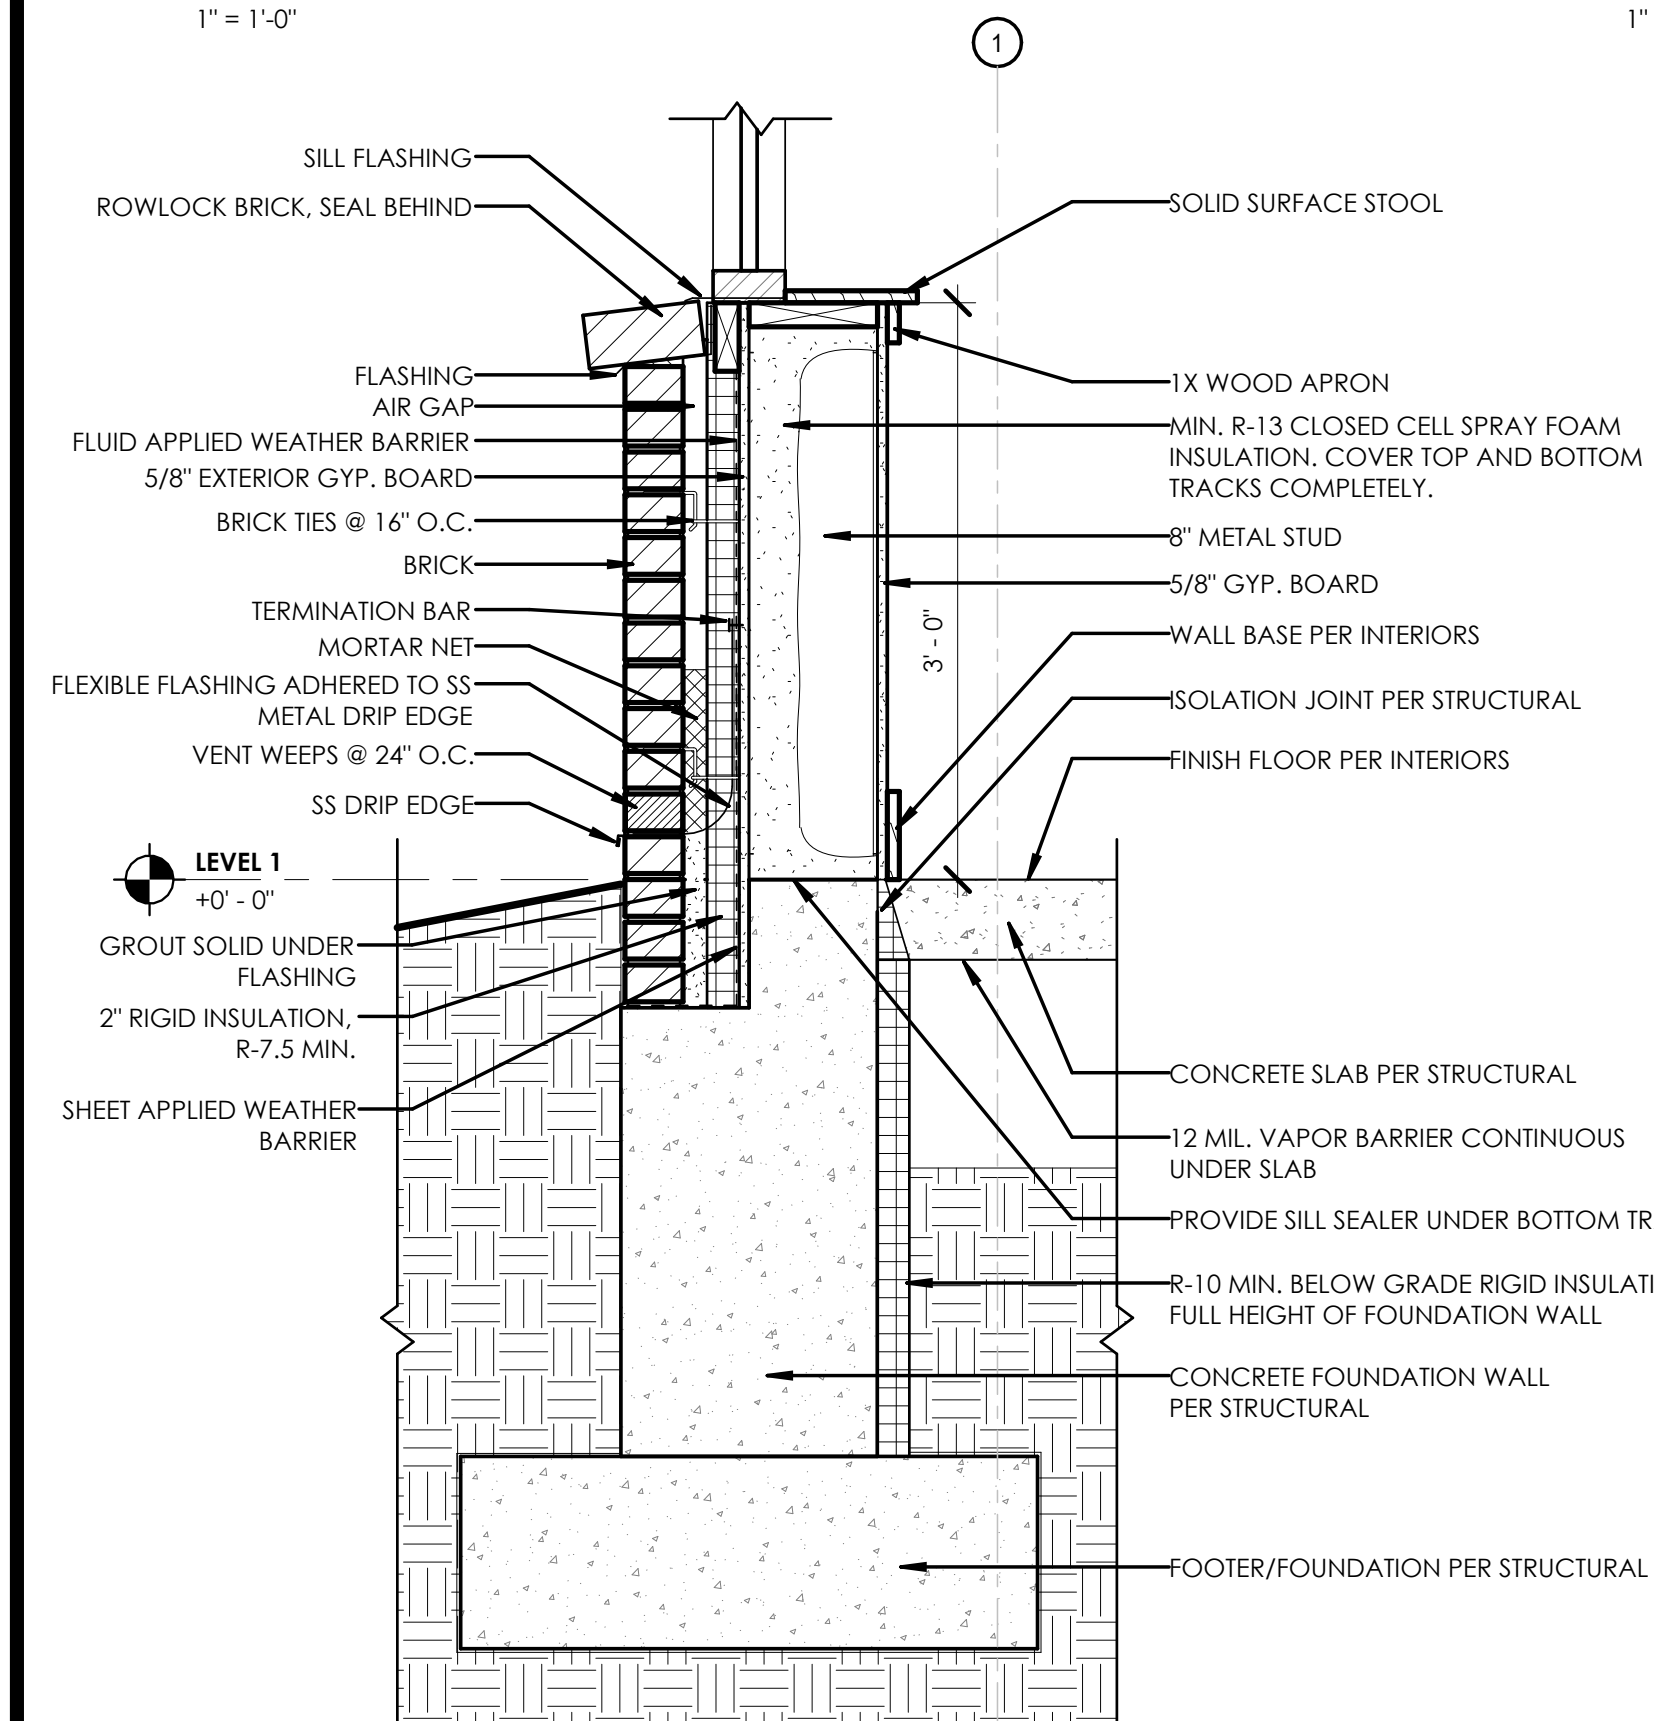Passero Associates

242 WEST MAIN ST., SUITE 100 (585) 325-1000
ROCHESTER, NY 14614 FAX: (585) 325-1691

PROJECT MANAGER	TIM GEIER
PROJECT ARCHITECT	TIM GEIER
DESIGNER	QUILLE HUGHES

[illegible]

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TYPICAL WALL SECTION DETAILS

1816 ENGLISH RD

NGFD - ENGLISH ROAD
STATION
TOWN/CITY: GREECE

COUNTY: MONROE STATE: NY


PROJECT NO.:

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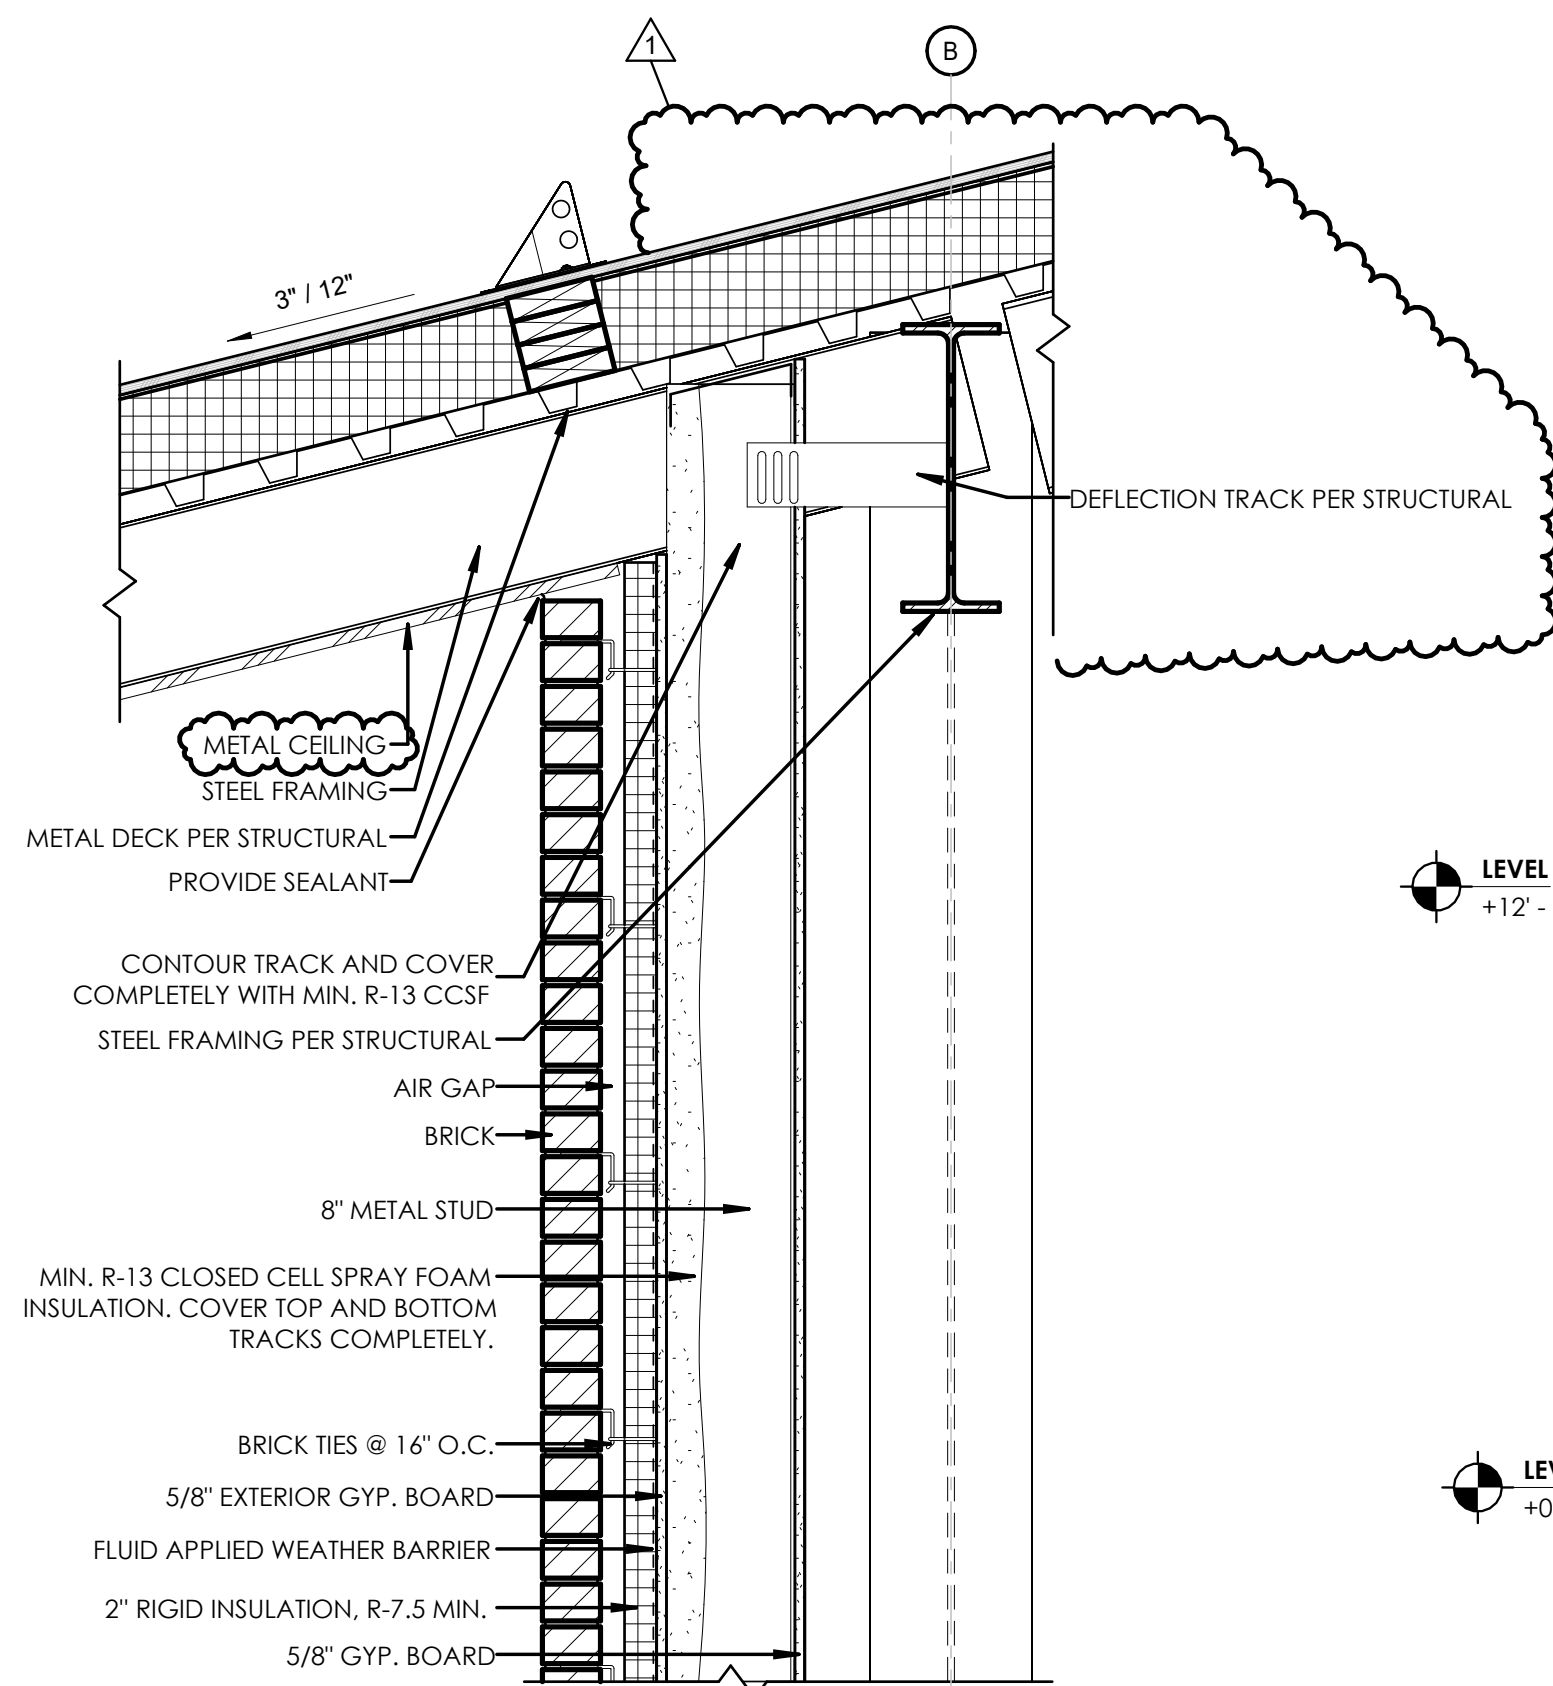
A-315

DATE: JANUARY 22, 2025



3 SECTION AT FITNESS ROOM NORTH - ROOF

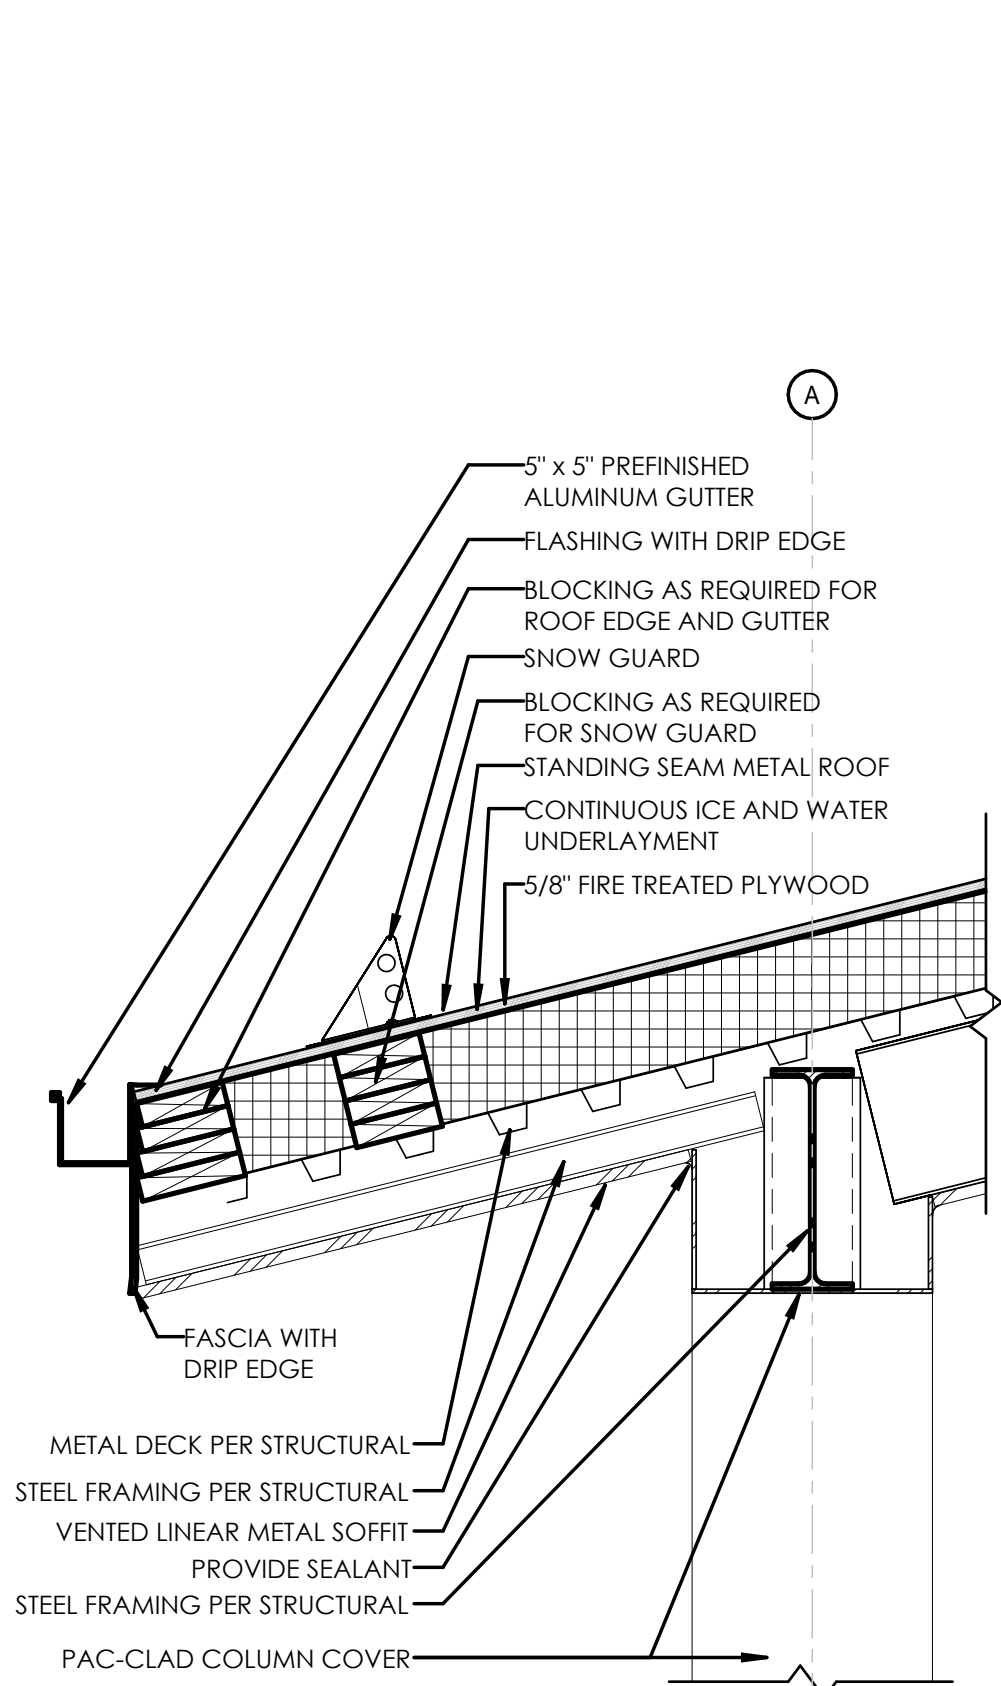0' 3" 6" 1" 2"
1" = 1'-0"




LEVEL 2
+12' - 6"

LEVEL 1
+0' - 0"

4 CANOPY COLUMN SECTION

0' 1" 2" 4" 8"
1/4" = 1'-0"

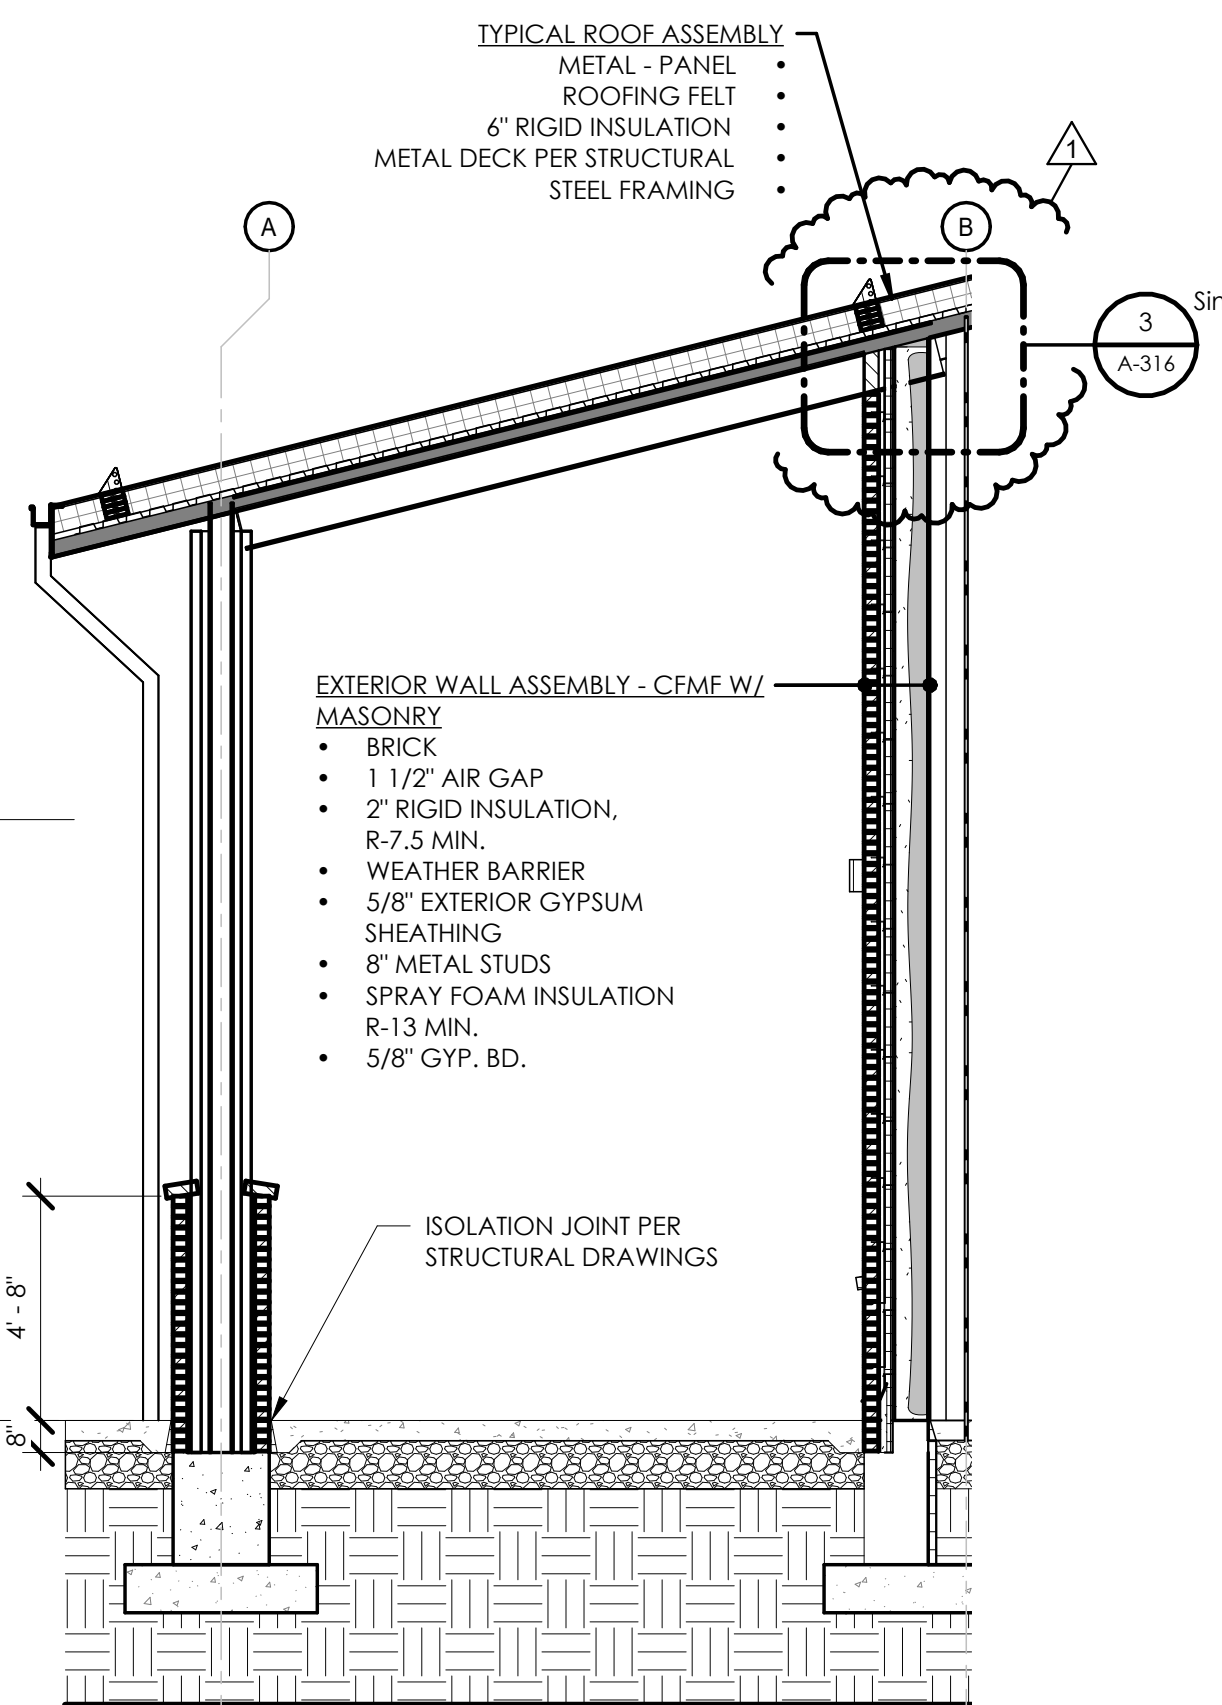


TYPICAL ROOF ASSEMBLY
METAL - PANEL
ROOFING FELT
6" RIGID INSULATION
METAL DECK PER STRUCTURAL
STEEL FRAMING

EXTERIOR WALL ASSEMBLY - CFMF W/
MASONRY


- BRICK
- 1 1/2" AIR GAP
- 2" RIGID INSULATION, R-7.5 MIN.
- WEATHER BARRIER
- 5/8" EXTERIOR GYPSUM SHEATHING
- 8" METAL STUDS
- SPRAY FOAM INSULATION R-13 MIN.
- 5/8" GYP. BD.

ISOLATION JOINT PER
STRUCTURAL DRAWINGS

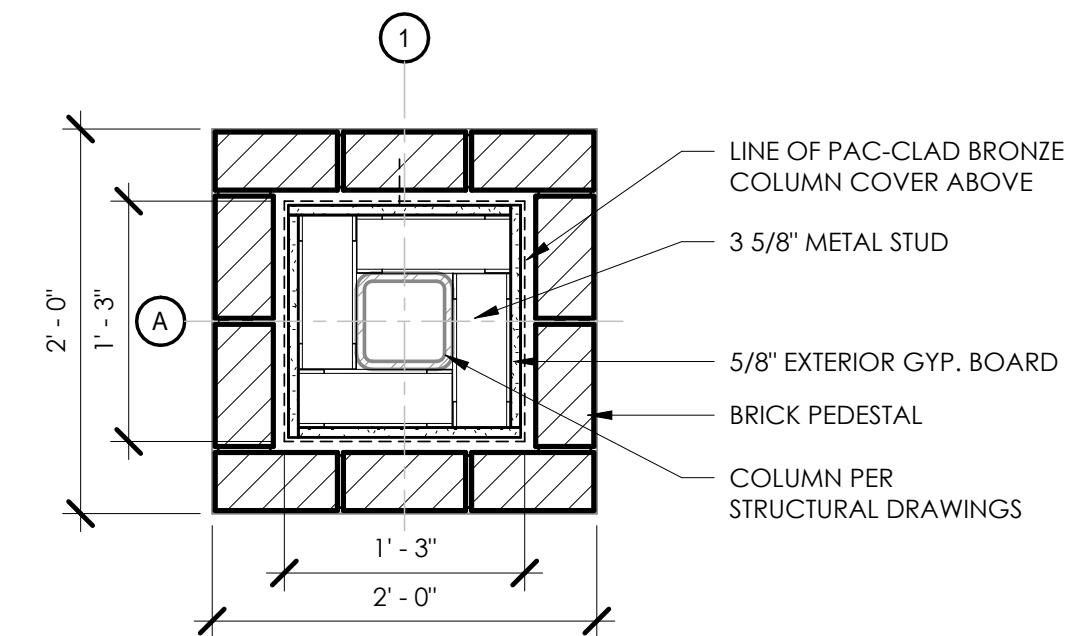


5 COLUMN AT BASE

0' 3" 6" 1" 2"
1" = 1'-0"

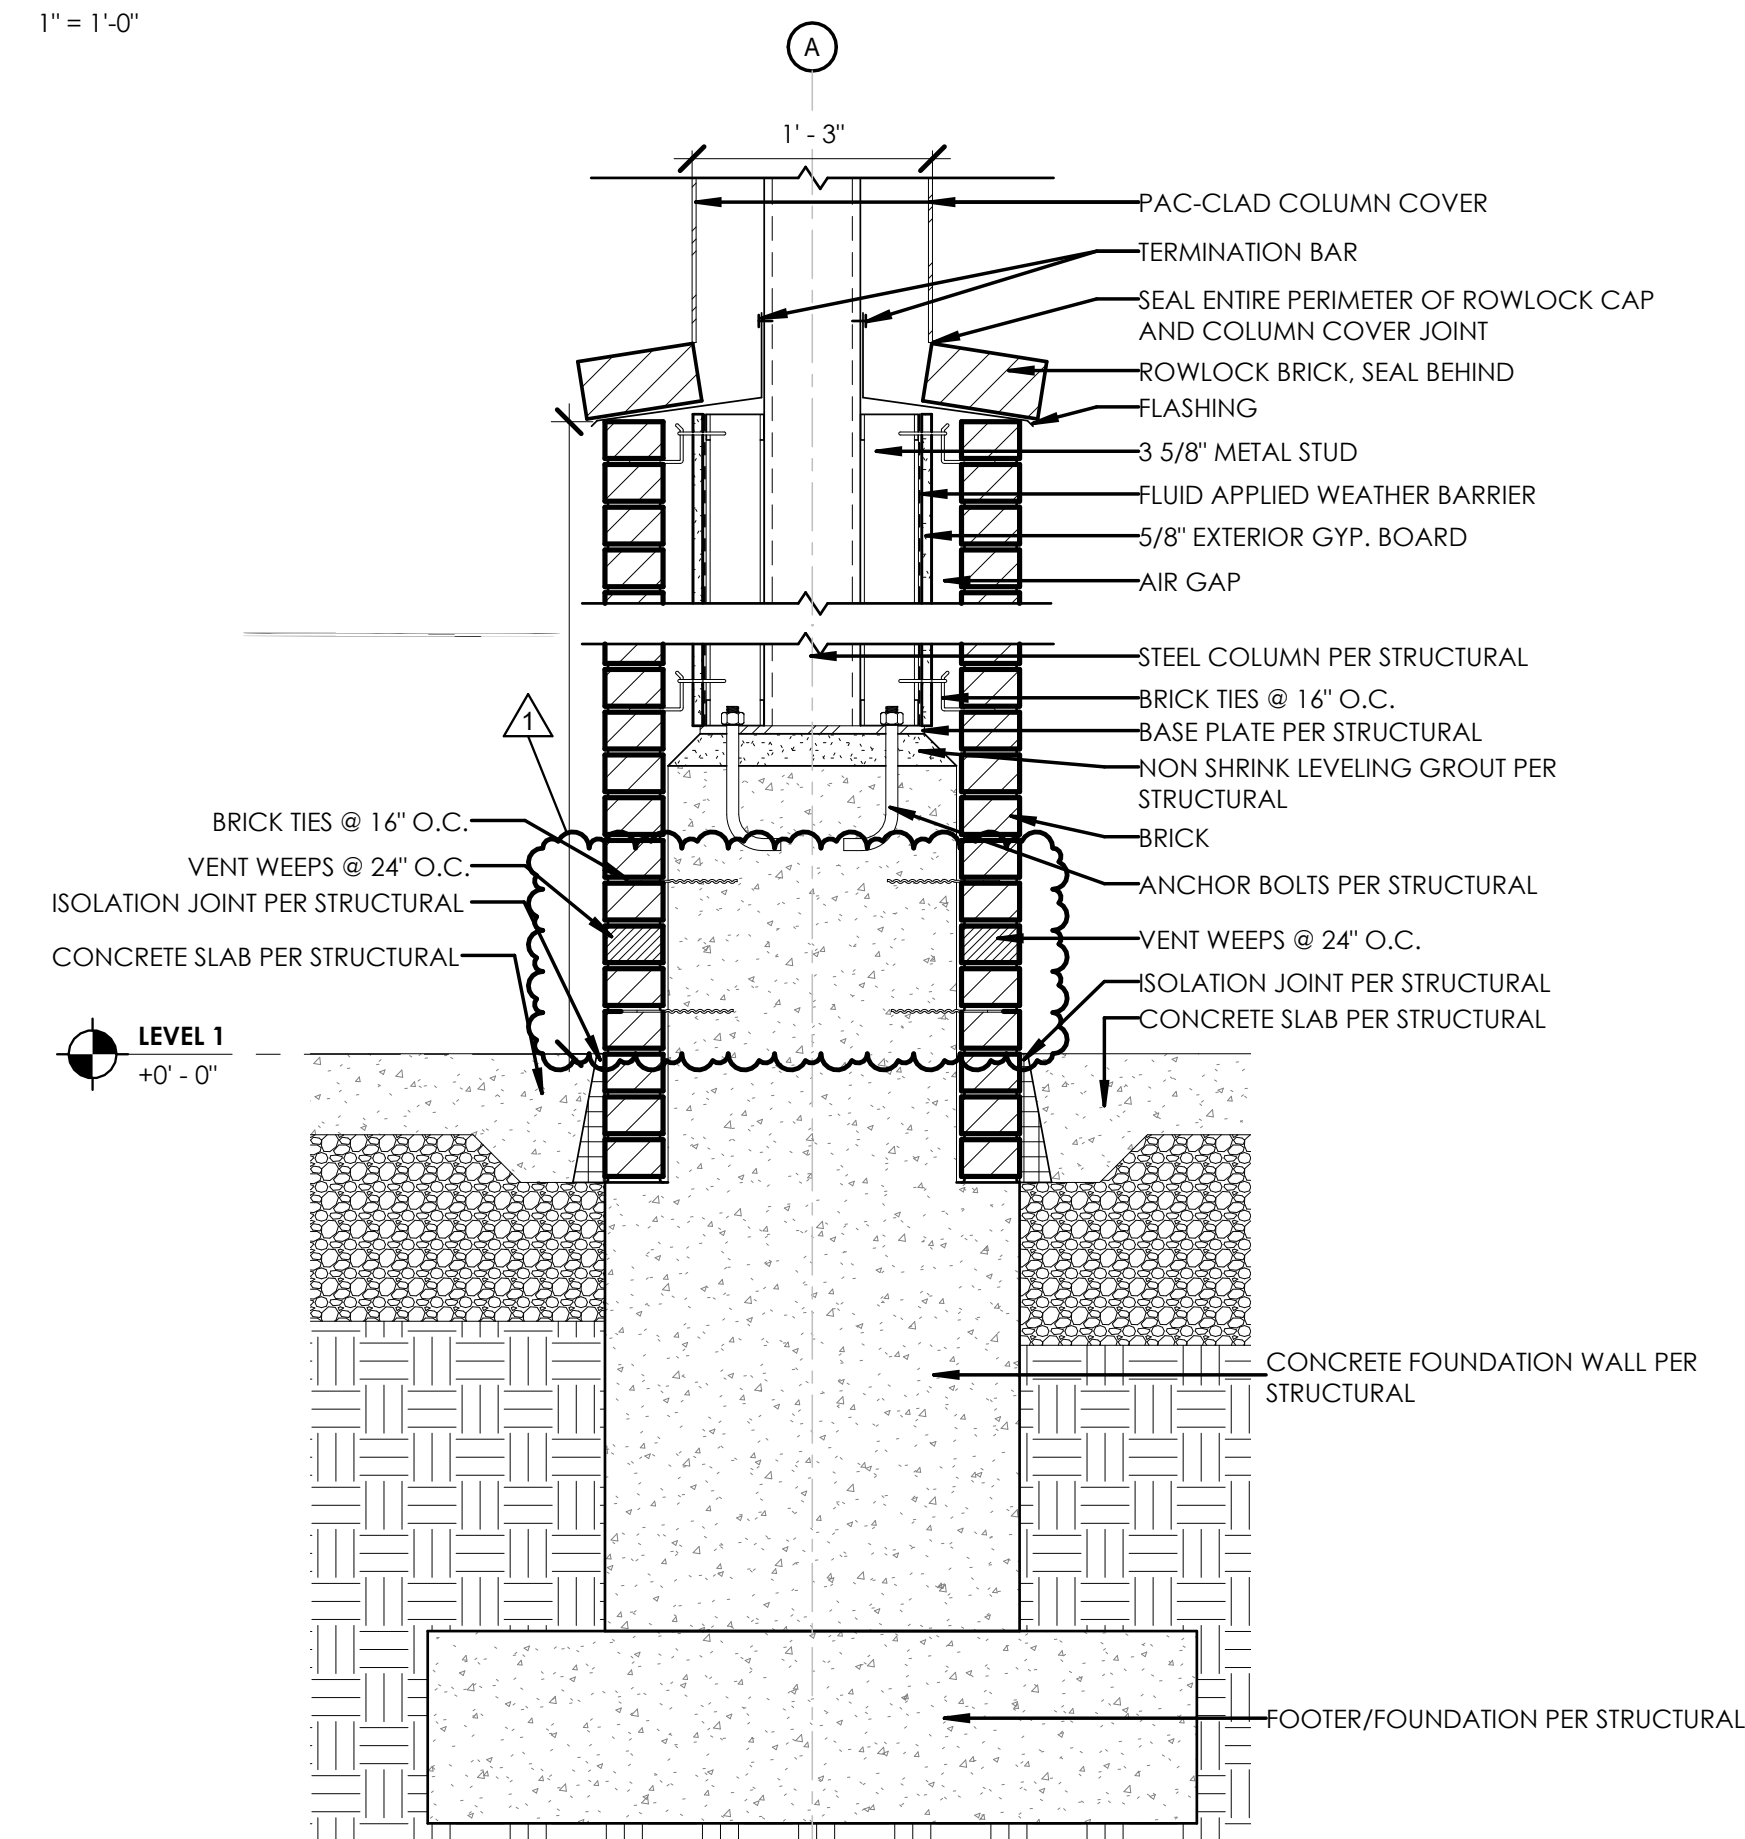

1 SECTION AT FITNESS ROOM NORTH - FOUNDATION

0' 3" 6" 1" 2"
1" = 1'-0"

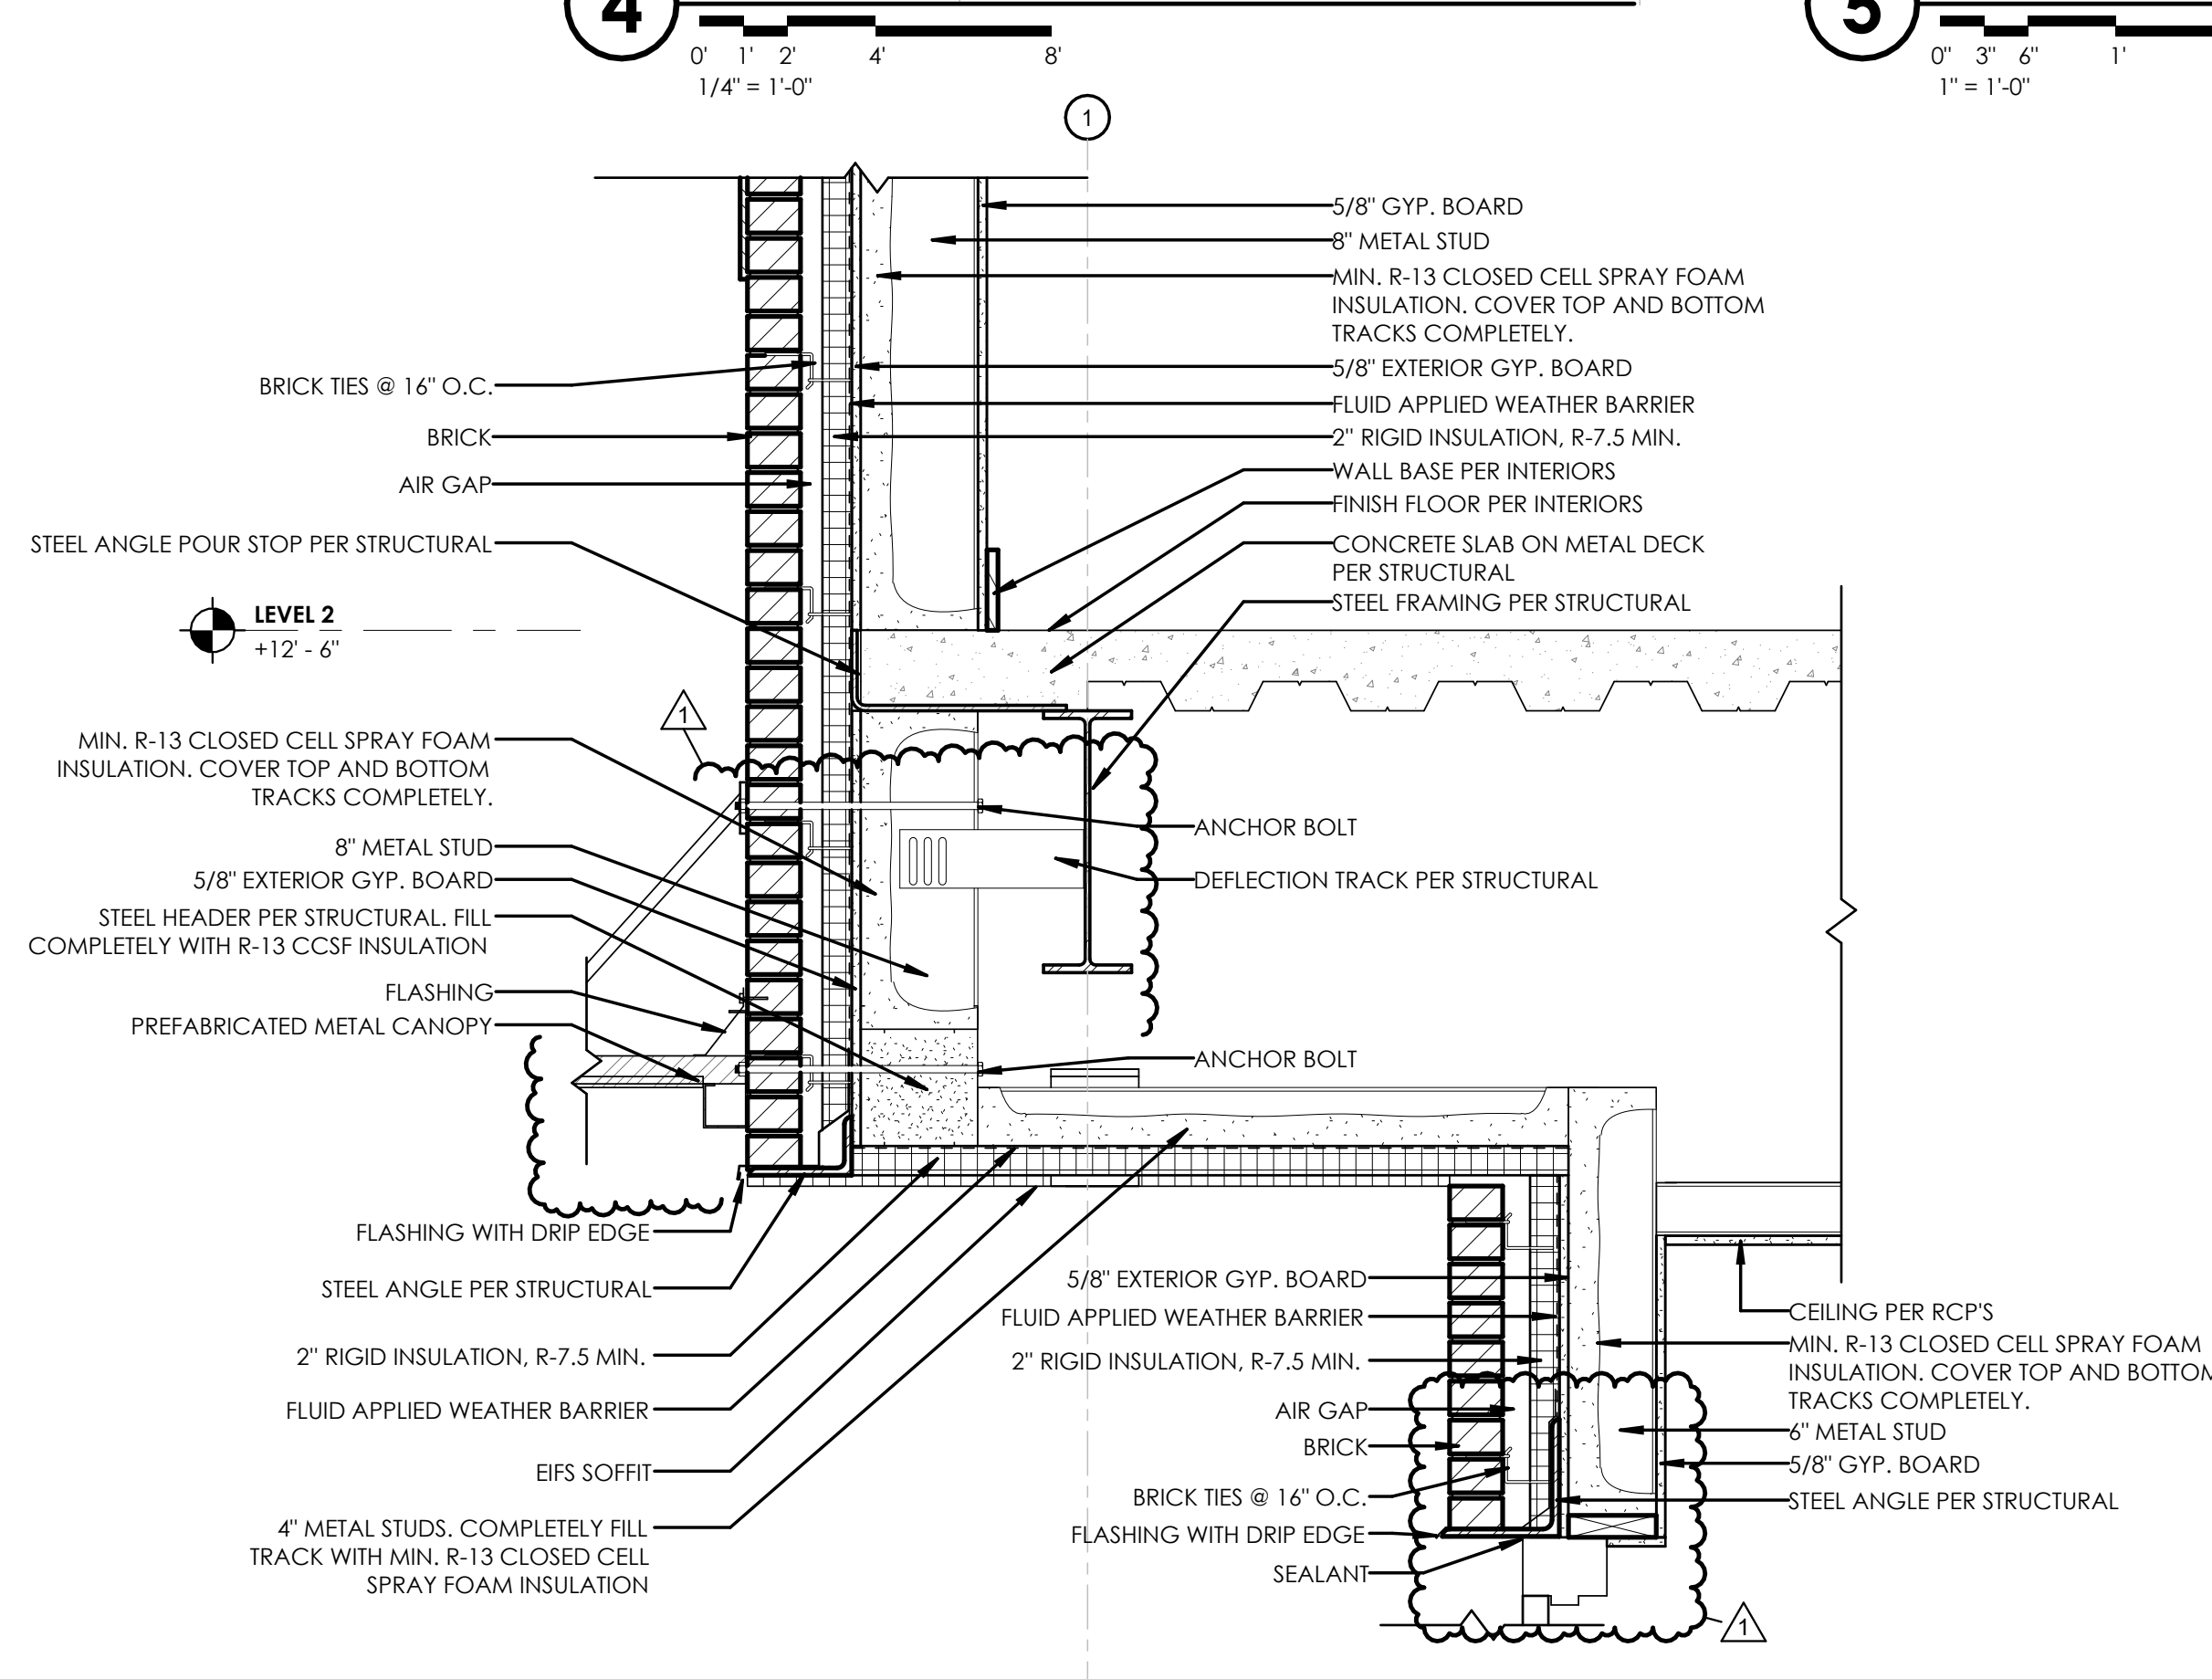

2 SECTION AT PUBLIC ENTRANCE - OVERHANG

0' 3" 6" 1" 2"
1" = 1'-0"

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**WALL SECTION
DETAILS**

1816 ENGLISH RD

NGFD - ENGLISH ROAD
STATION

TOWN/CITY: GREECE

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PROJECT NO.:

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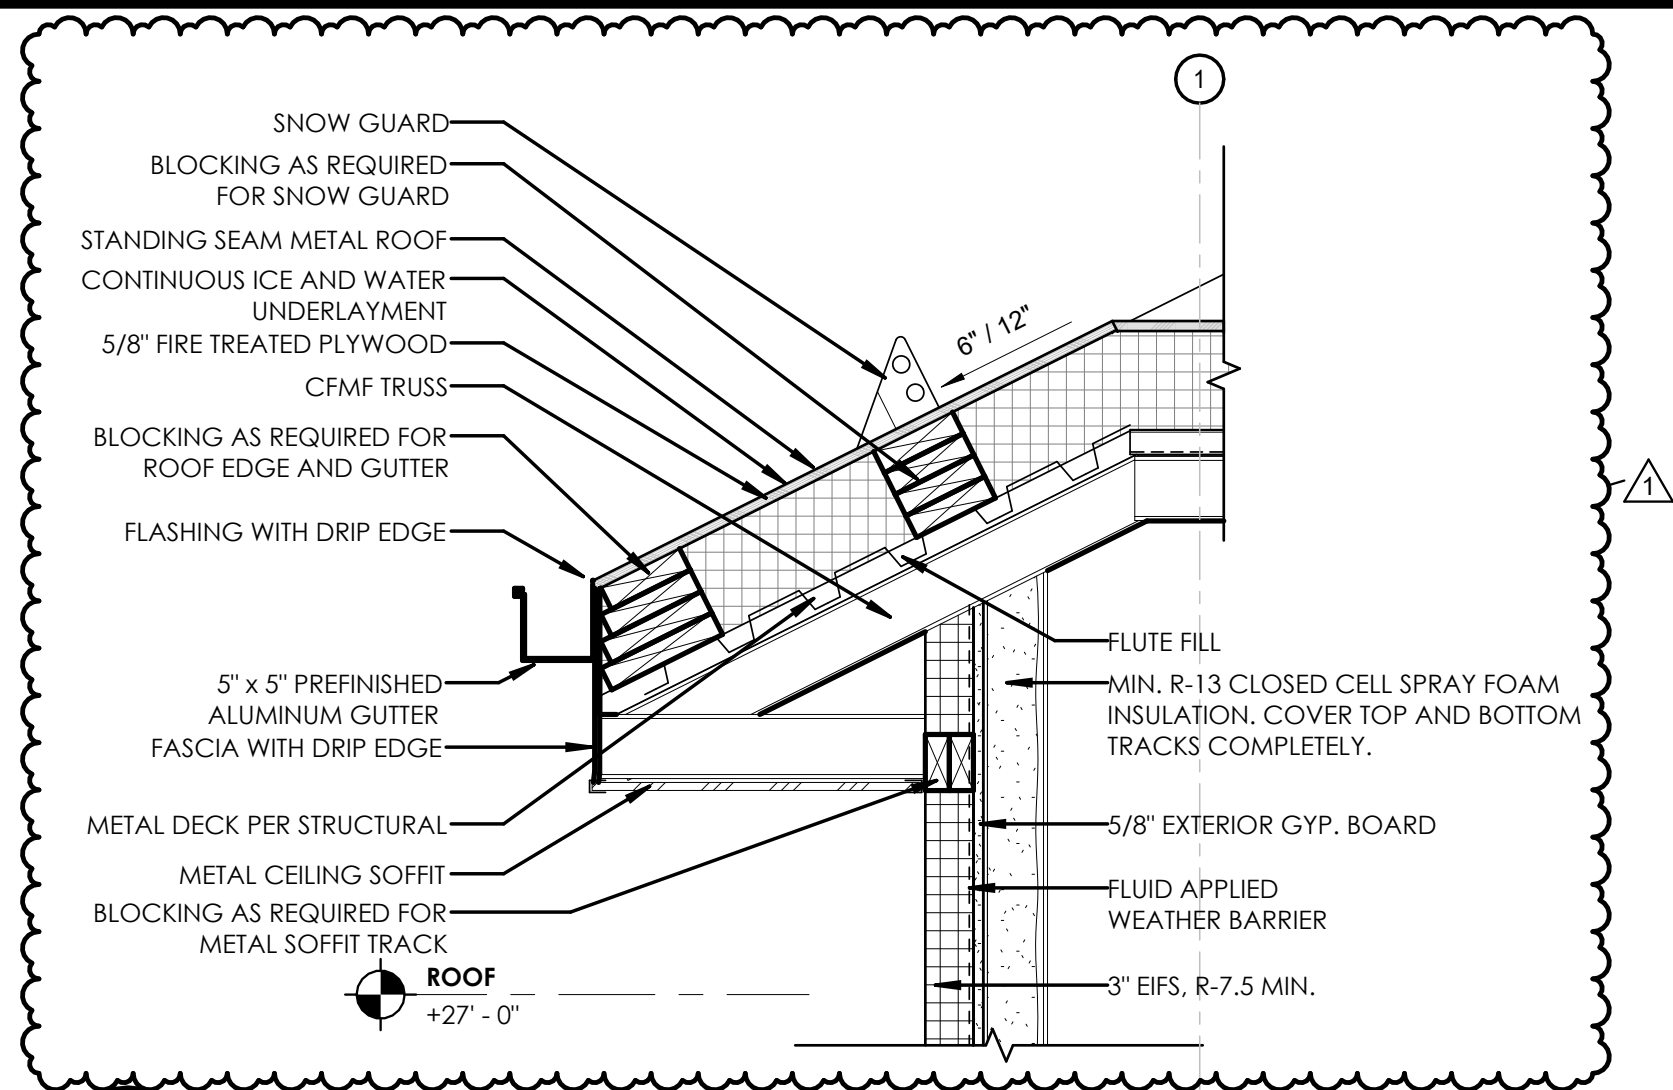
DRAWING NO.:

A-316

DATE:


JANUARY 22, 2025

BID SET




4 SECTION AT LOUNGE BUMP OUT - ROOF

0' 3' 6' 1' 2'
1" = 1'-0"

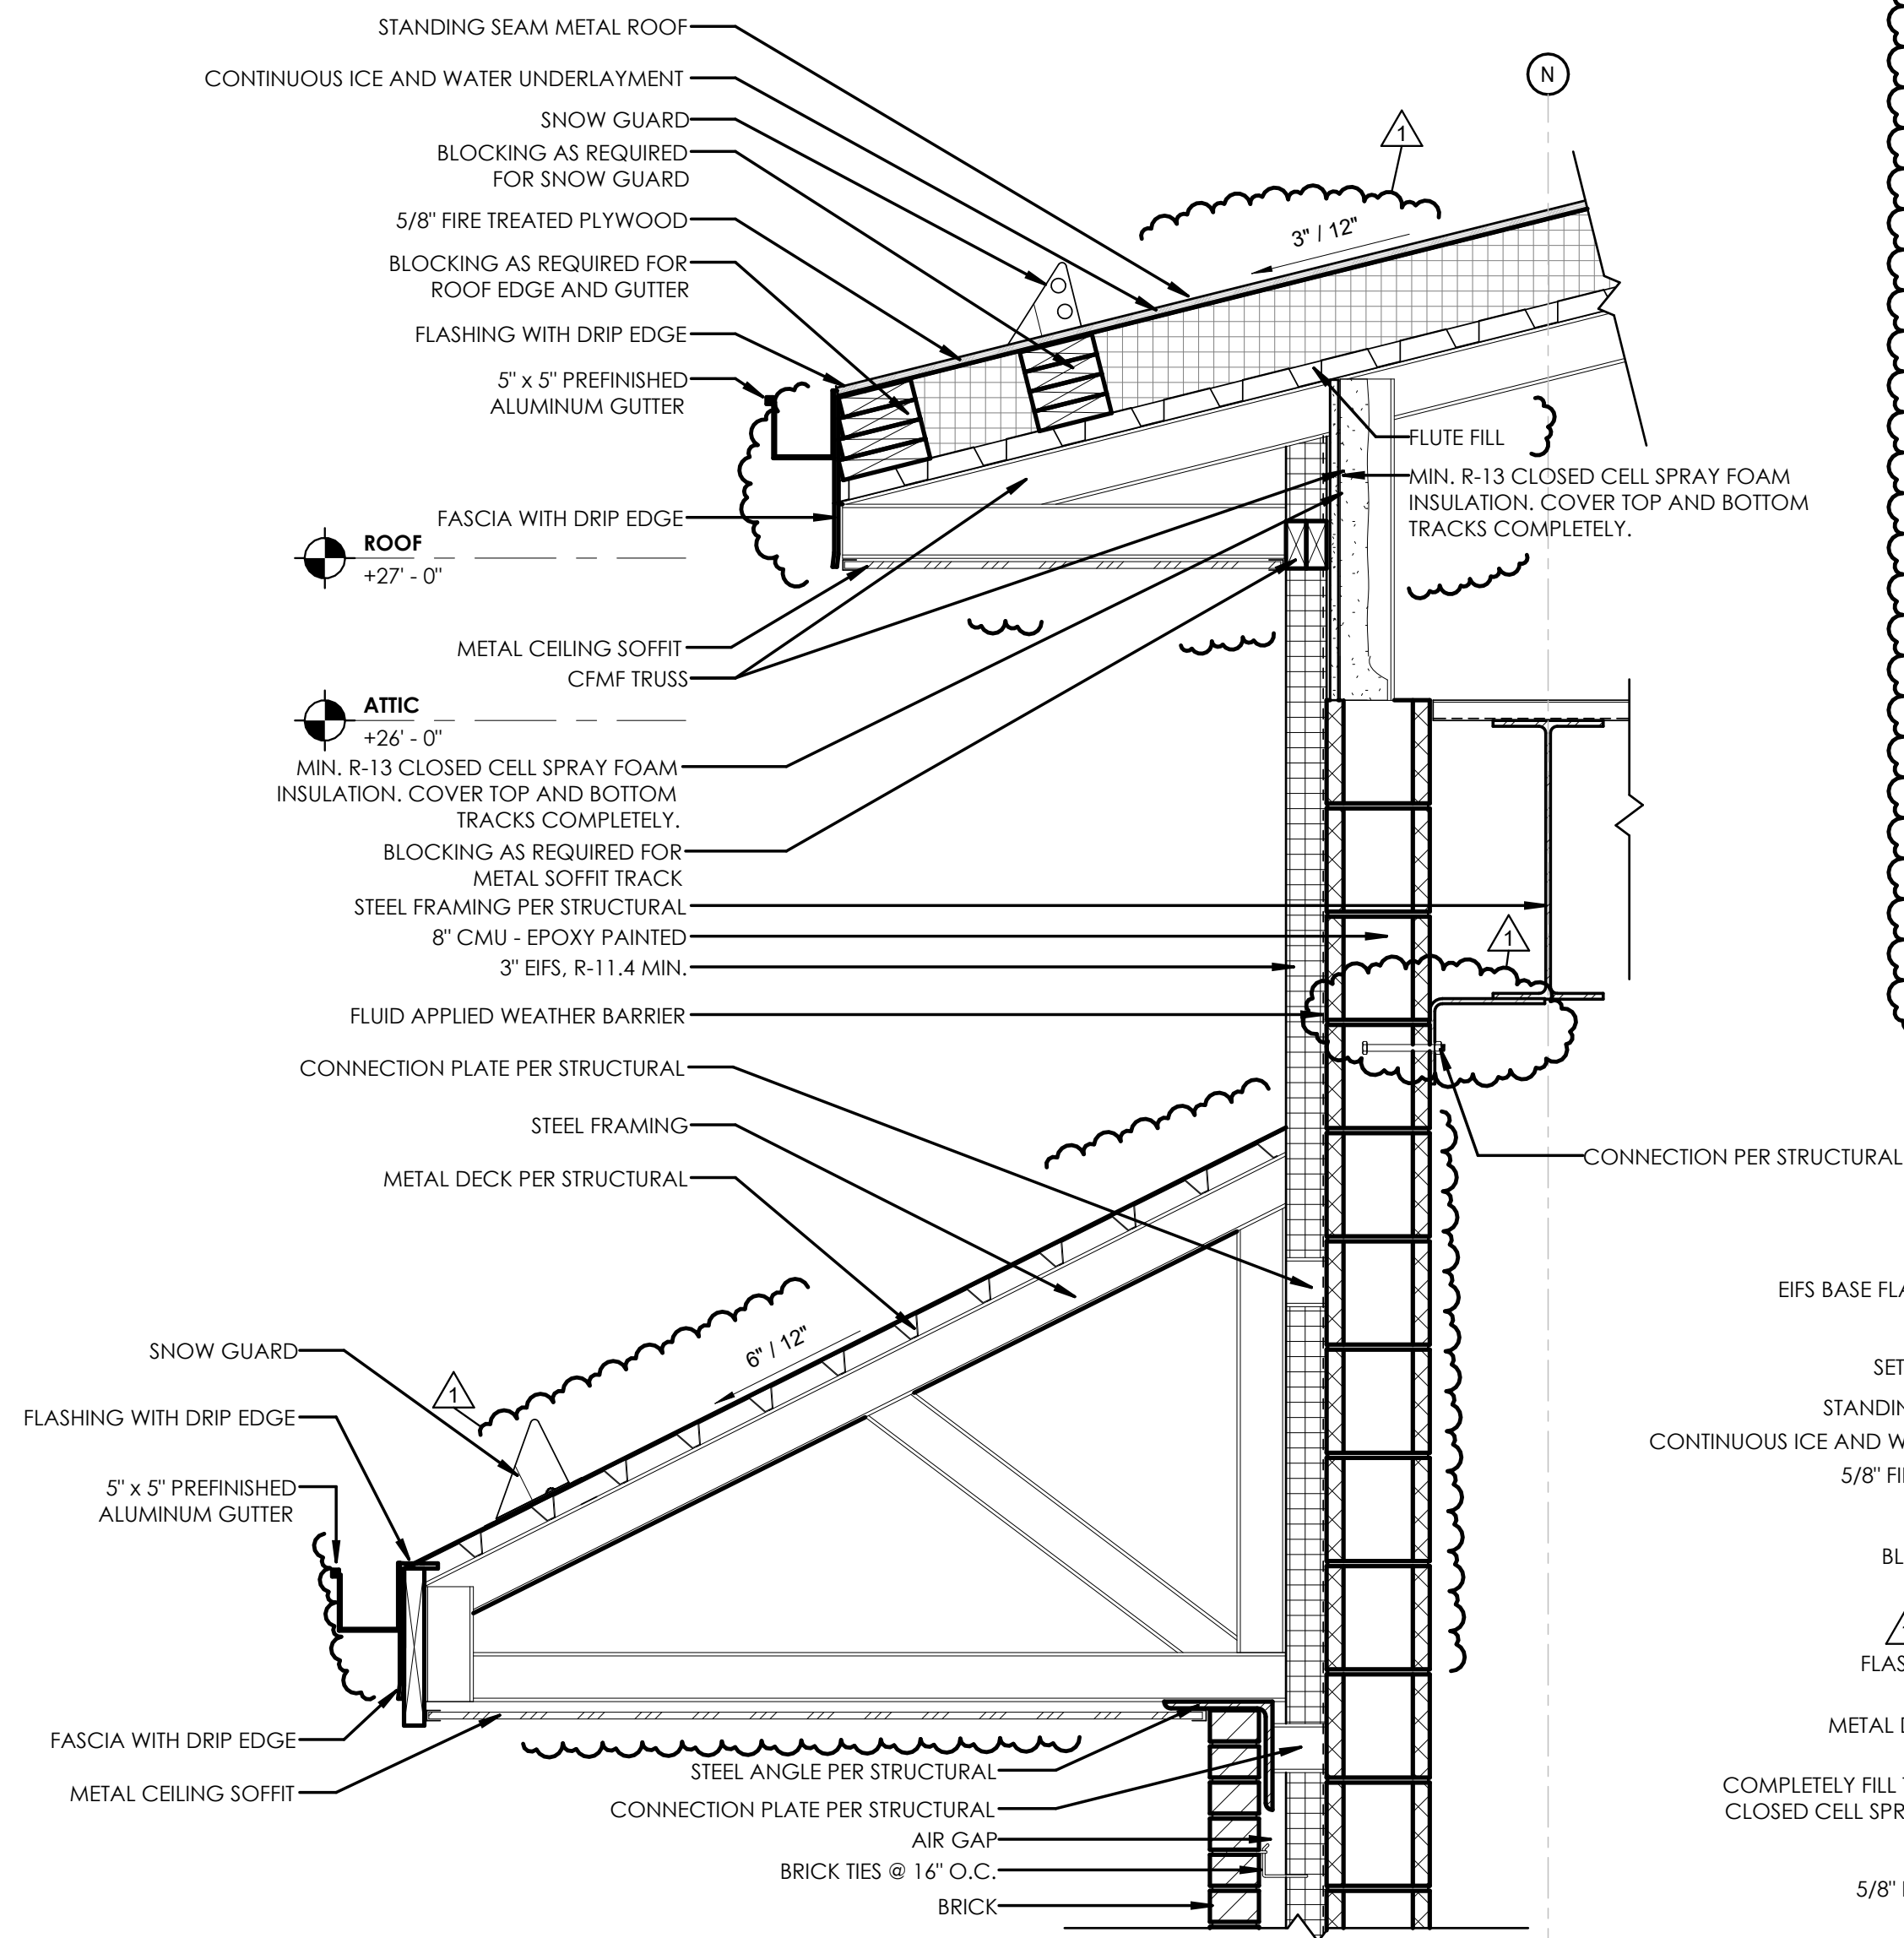


1 SECTION AT APPARATUS BAY SOUTH WALL - ROOF

0' 3' 6' 1' 2'
1" = 1'-0"

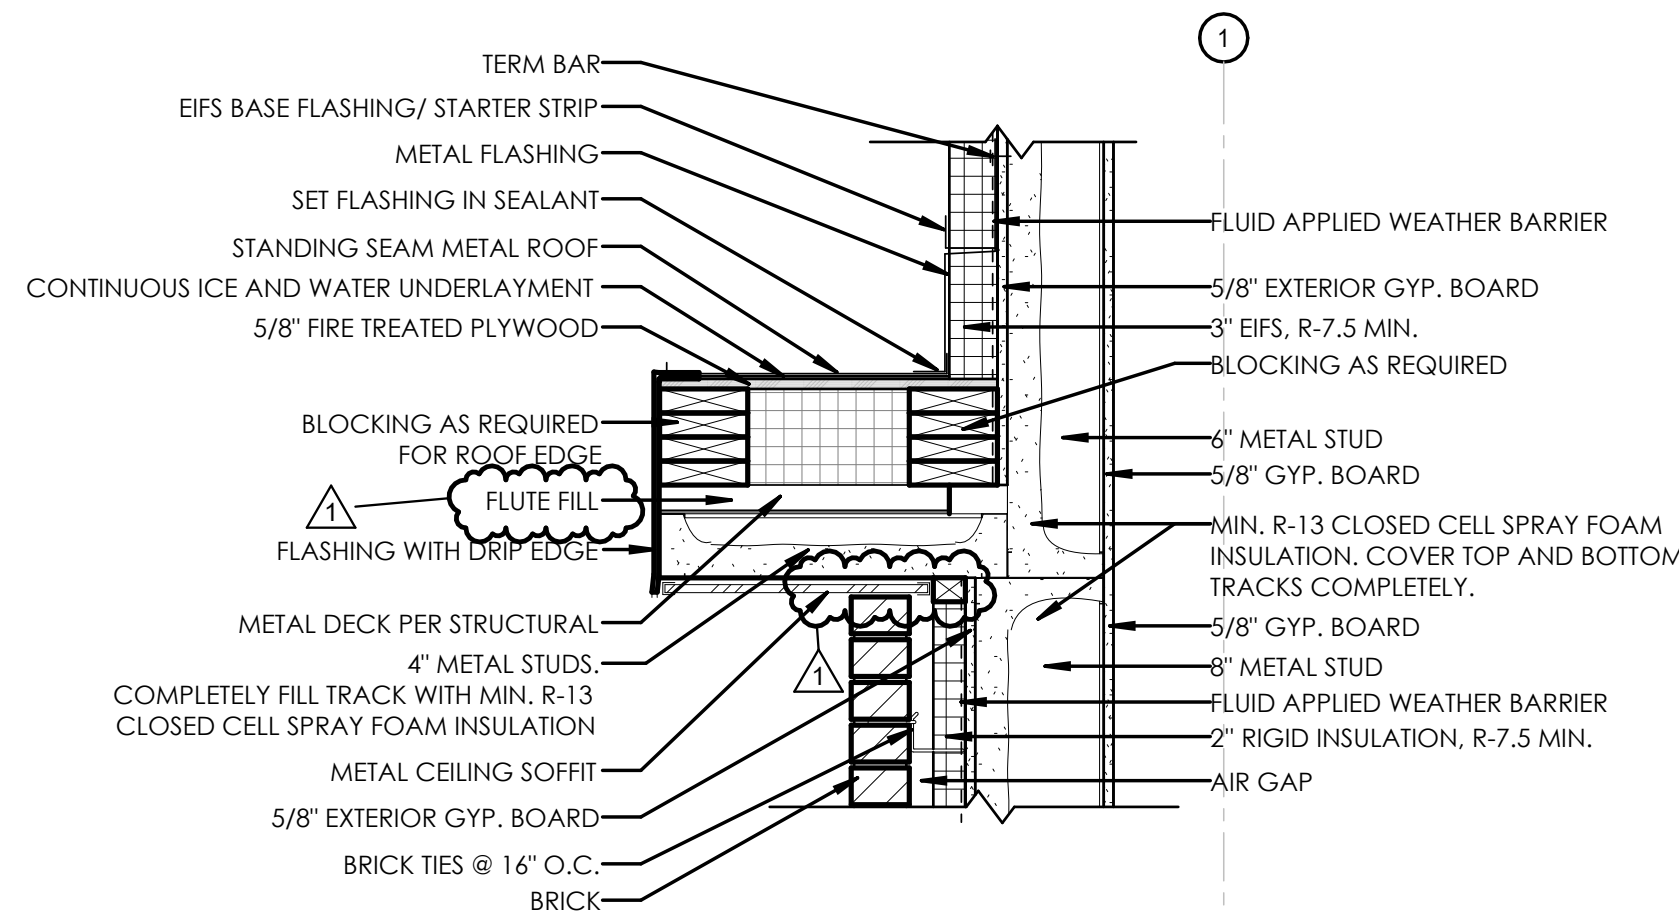


2 SECTION AT LOUNGE BUMP OUT - OVERHANG

0' 3' 6' 1' 2'
1" = 1'-0"

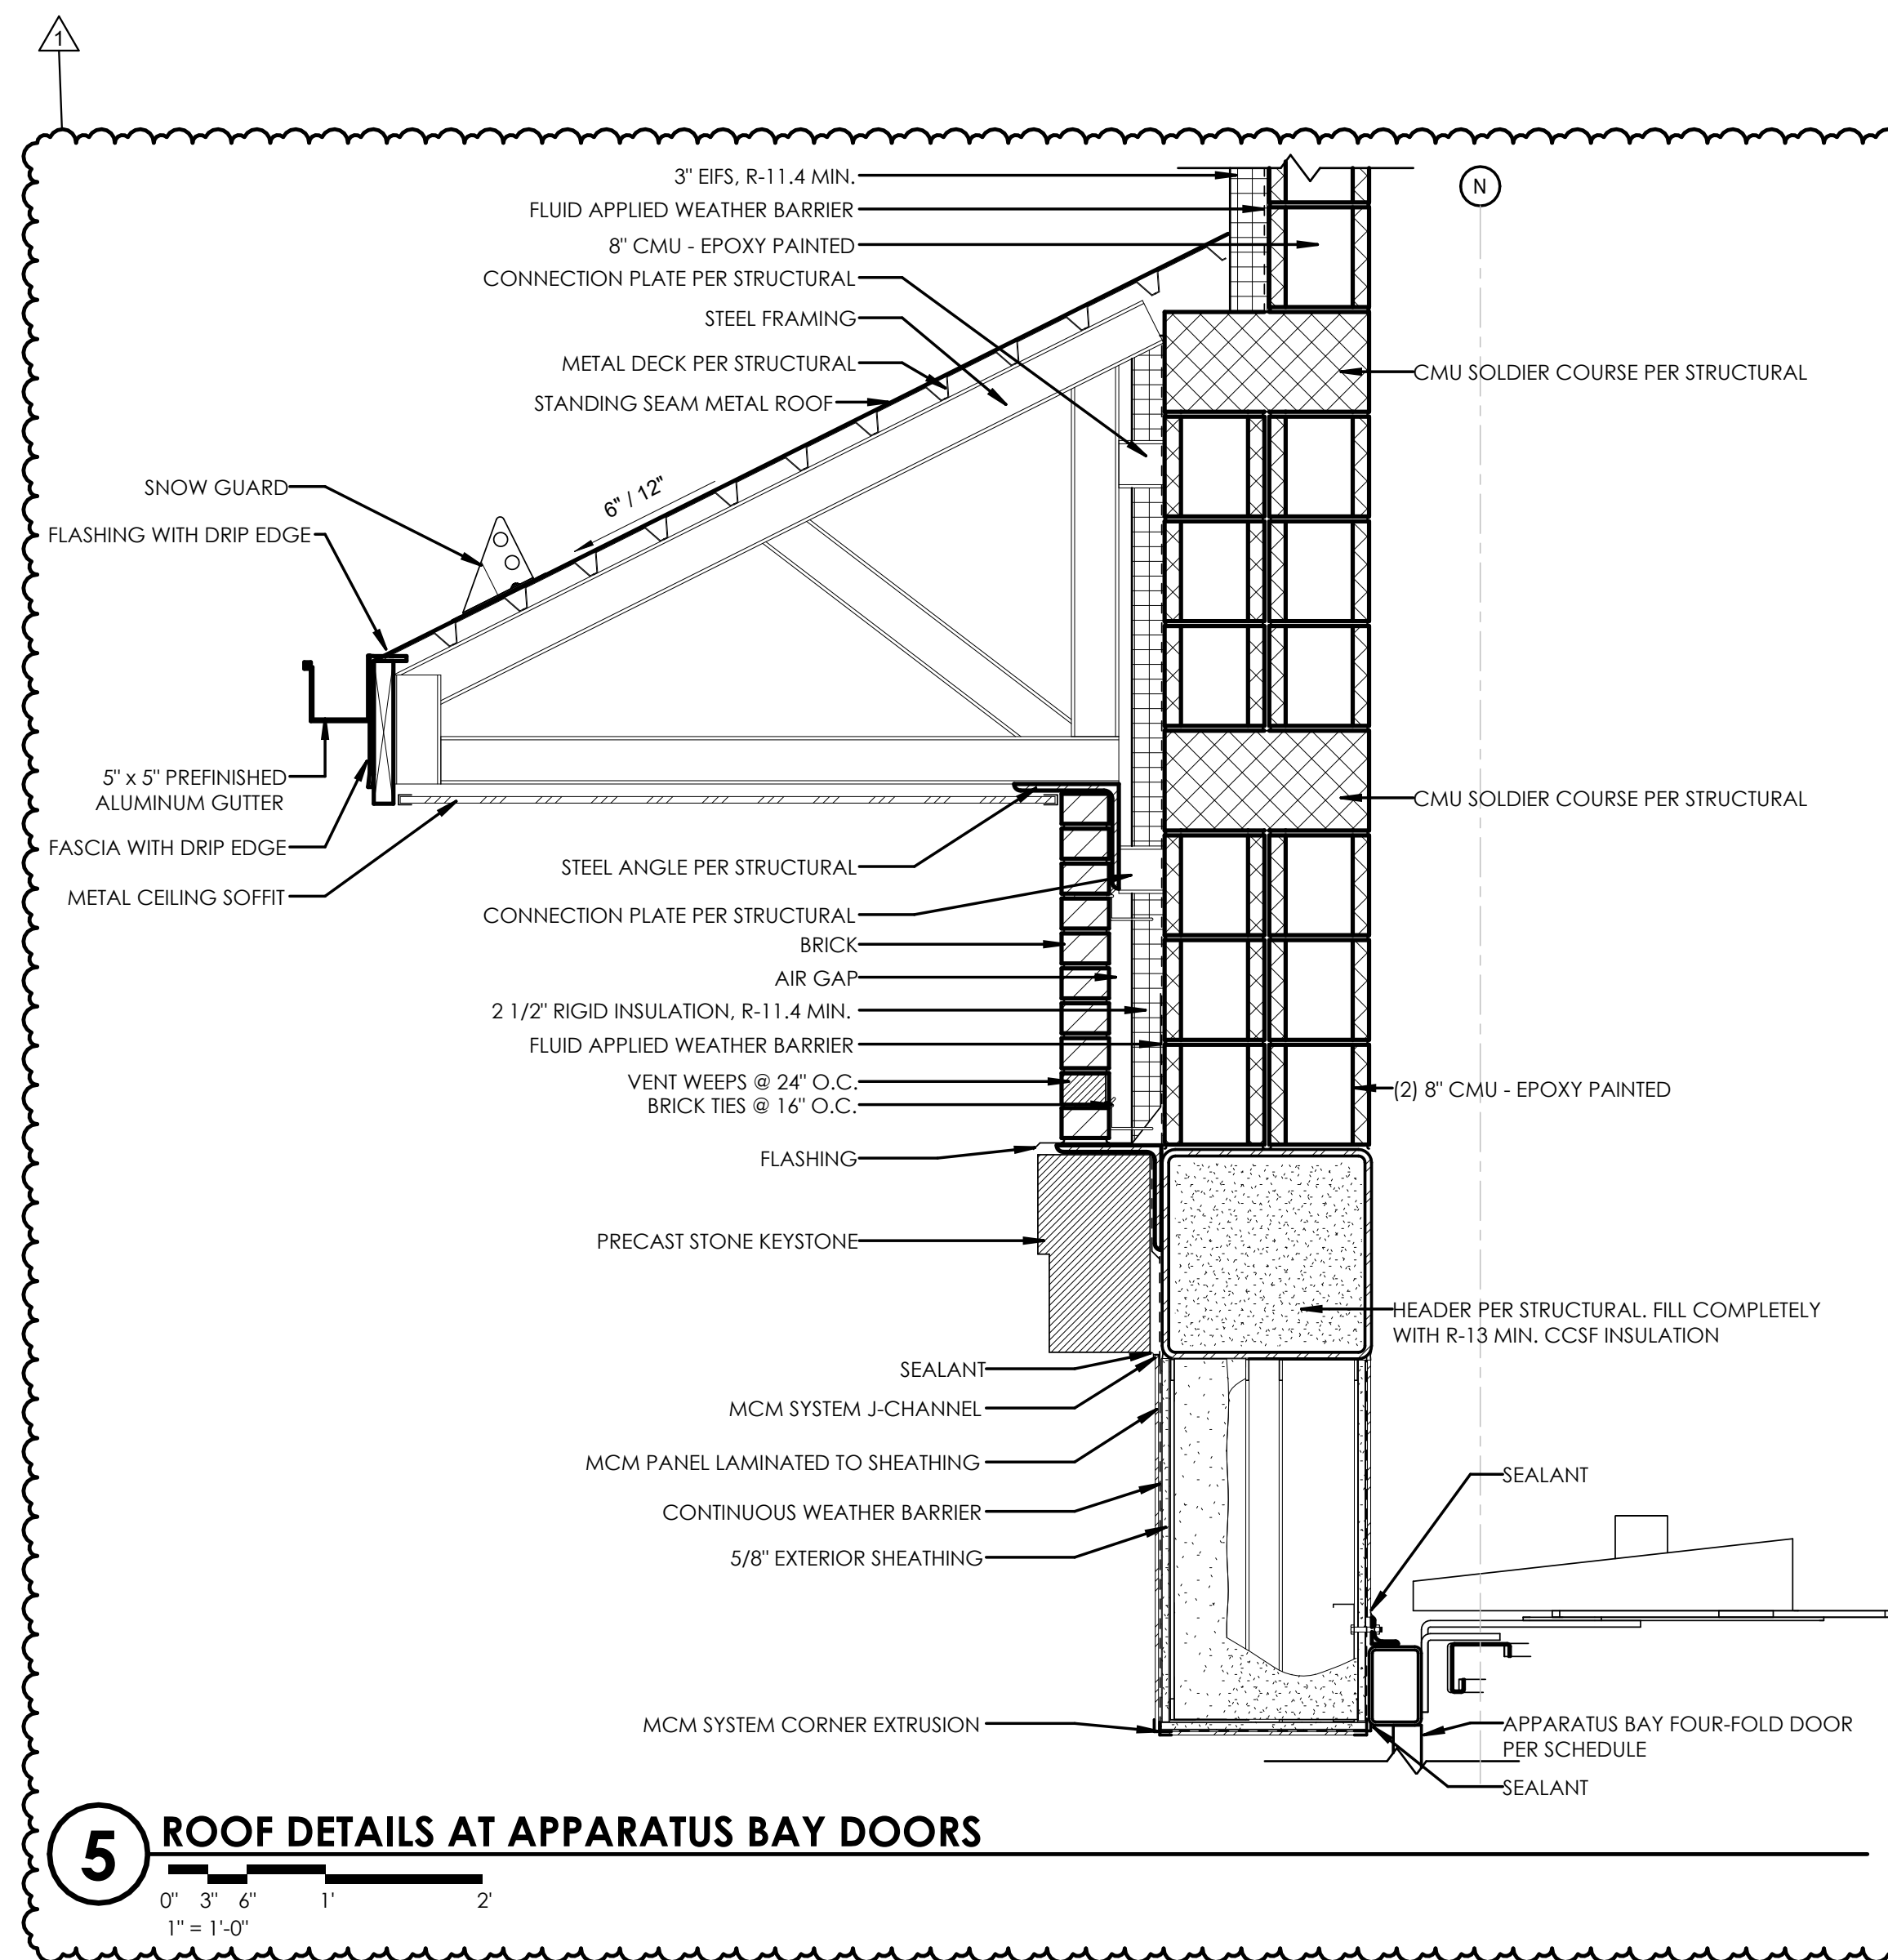

5 ROOF DETAILS AT APPARATUS BAY DOORS

0' 3' 6' 1' 2'
1" = 1'-0"

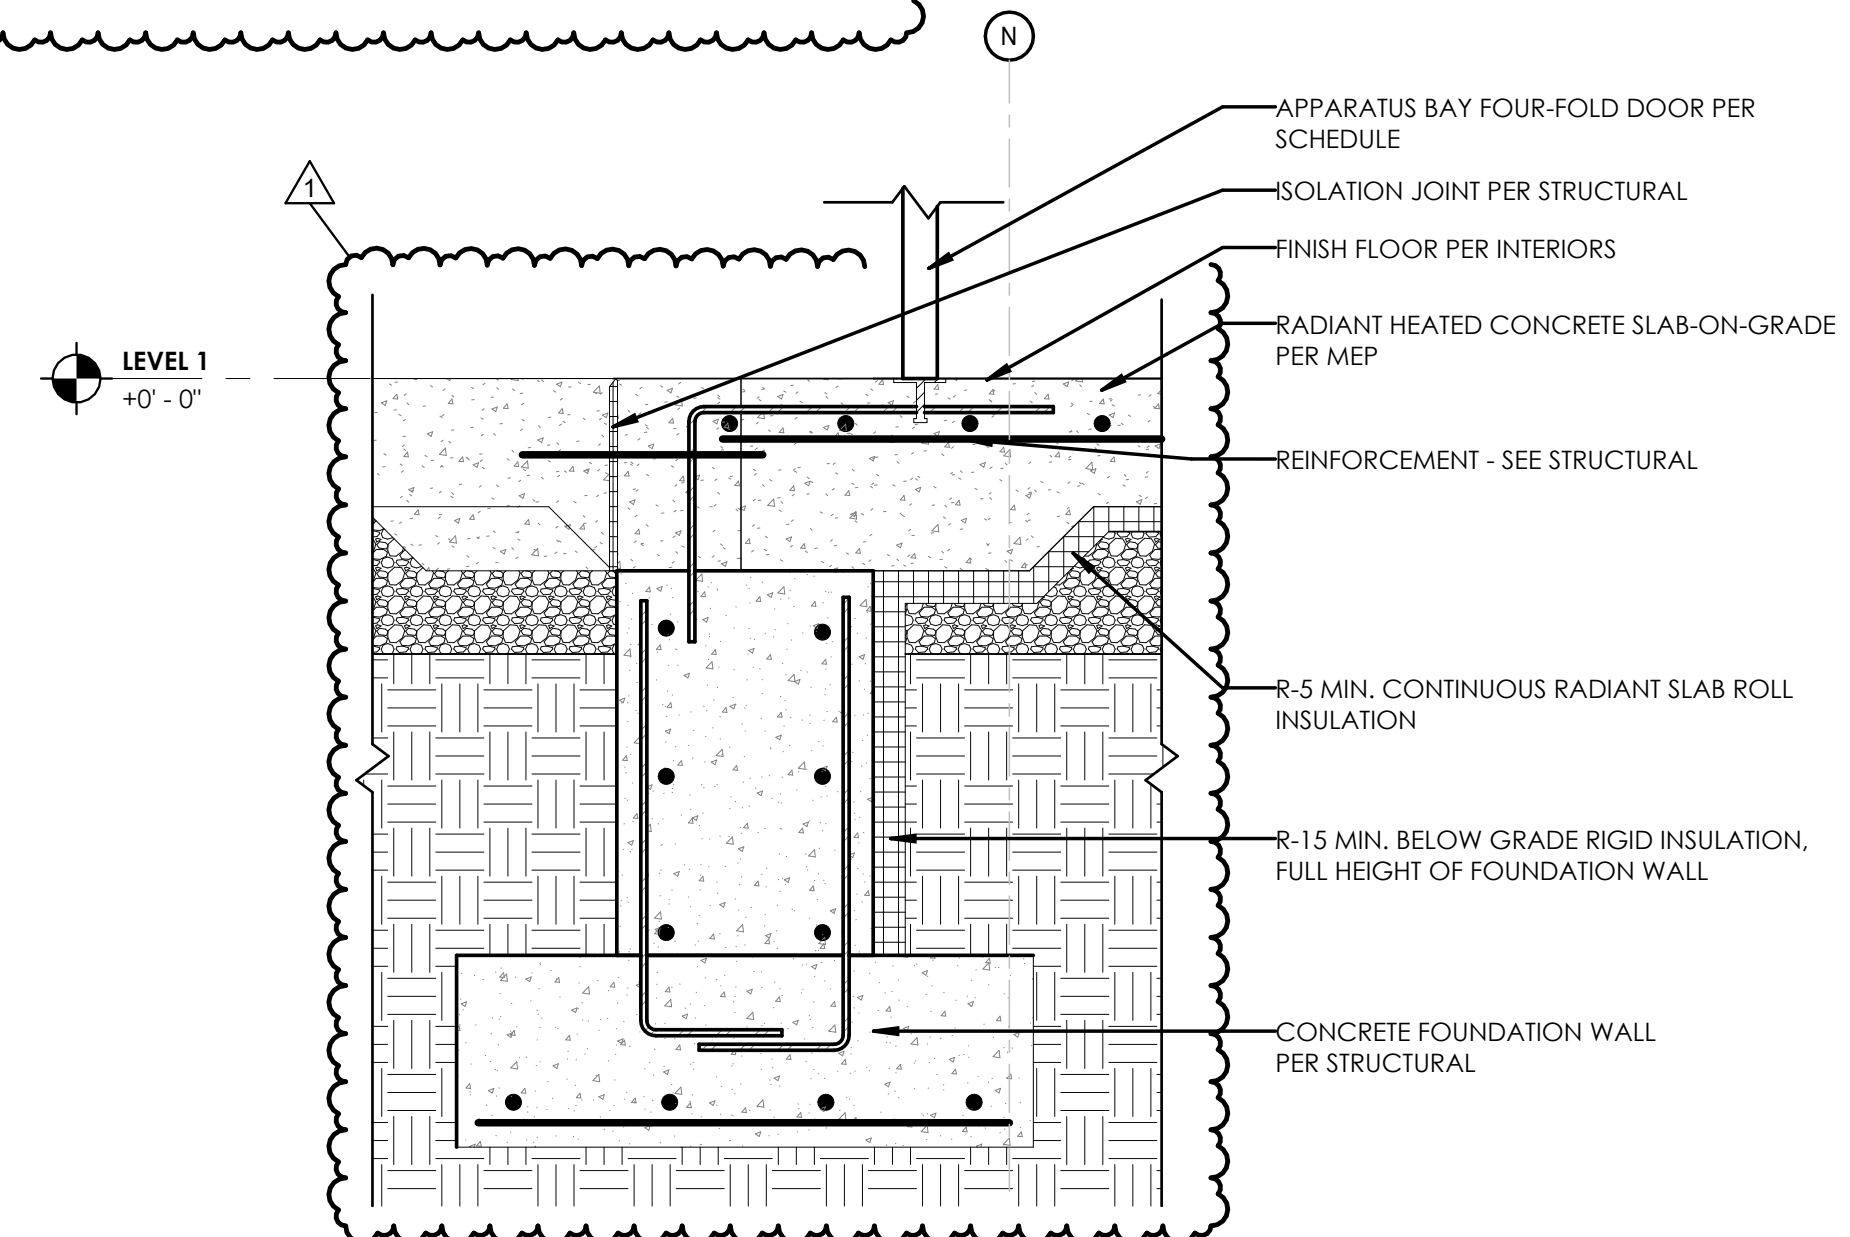

3 FOUNDATION AT APPARATUS BAY FRONT WALL

0' 3' 6' 1' 2'
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- PROVIDE THROUGH WALL FLASHING WITH END DAMS AND WEEPS AT 16" ON CENTER MAX. AT EACH EXTERIOR LITE. ALL EXTERIOR STEEL LITE'S SHALL BE GALVANIZED AND PAINTED (COLOR BY ARCHITECT).
- PROVIDE THROUGH WALL FLASHING WITH END DAMS AND WEEPS AT 16" ON CENTER MAX. AT EACH EXTERIOR SILL.
- ALL EXPOSED STEEL, CONDUIT, PIPING, AND DUCTWORK TO BE PAINTED.
- ALL MATERIALS THAT ARE TO BE INSTALLED IN CONTACT WITH THE WEATHER BARRIER SHALL BE REVIEWED FOR COMPATIBILITY BY THE MANUFACTURER PRIOR TO SUBMITTAL. ALL SUCH SUBMITTALS SHALL INCLUDE MANUFACTURER'S CERTIFICATE OF COMPATIBILITY.
- PROVIDE INTUMESCENT COATING ON ALL SPRAY FOAM AREAS EXPOSED IN SOFFIT CAVITIES.

STAMP:

CLIENT:
N. GREECE FIRE DISTRICT
1766 LATTA RD
ROCHESTER, NY 14612

Passero Associates

242 WEST MAIN ST., SUITE 100 (585) 325-1000
ROCHESTER, NY 14614 FAX: (585) 325-1691

PROJECT MANAGER: TIM GEIER
PROJECT ARCHITECT: TIM GEIER
DESIGNER: QUILL HUGHES

NO.	DATE	BY	DESCRIPTION
1	01/30/25		ADDENDUM 1

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**WALL SECTION
DETAILS**

1816 ENGLISH RD

NGFD - ENGLISH ROAD
STATION
TOWN/CITY: GREECE


COUNTY: MONROE STATE: NY

20233530.0001


DRAWING NO.:
A-317

DATE:
JANUARY 22, 2025


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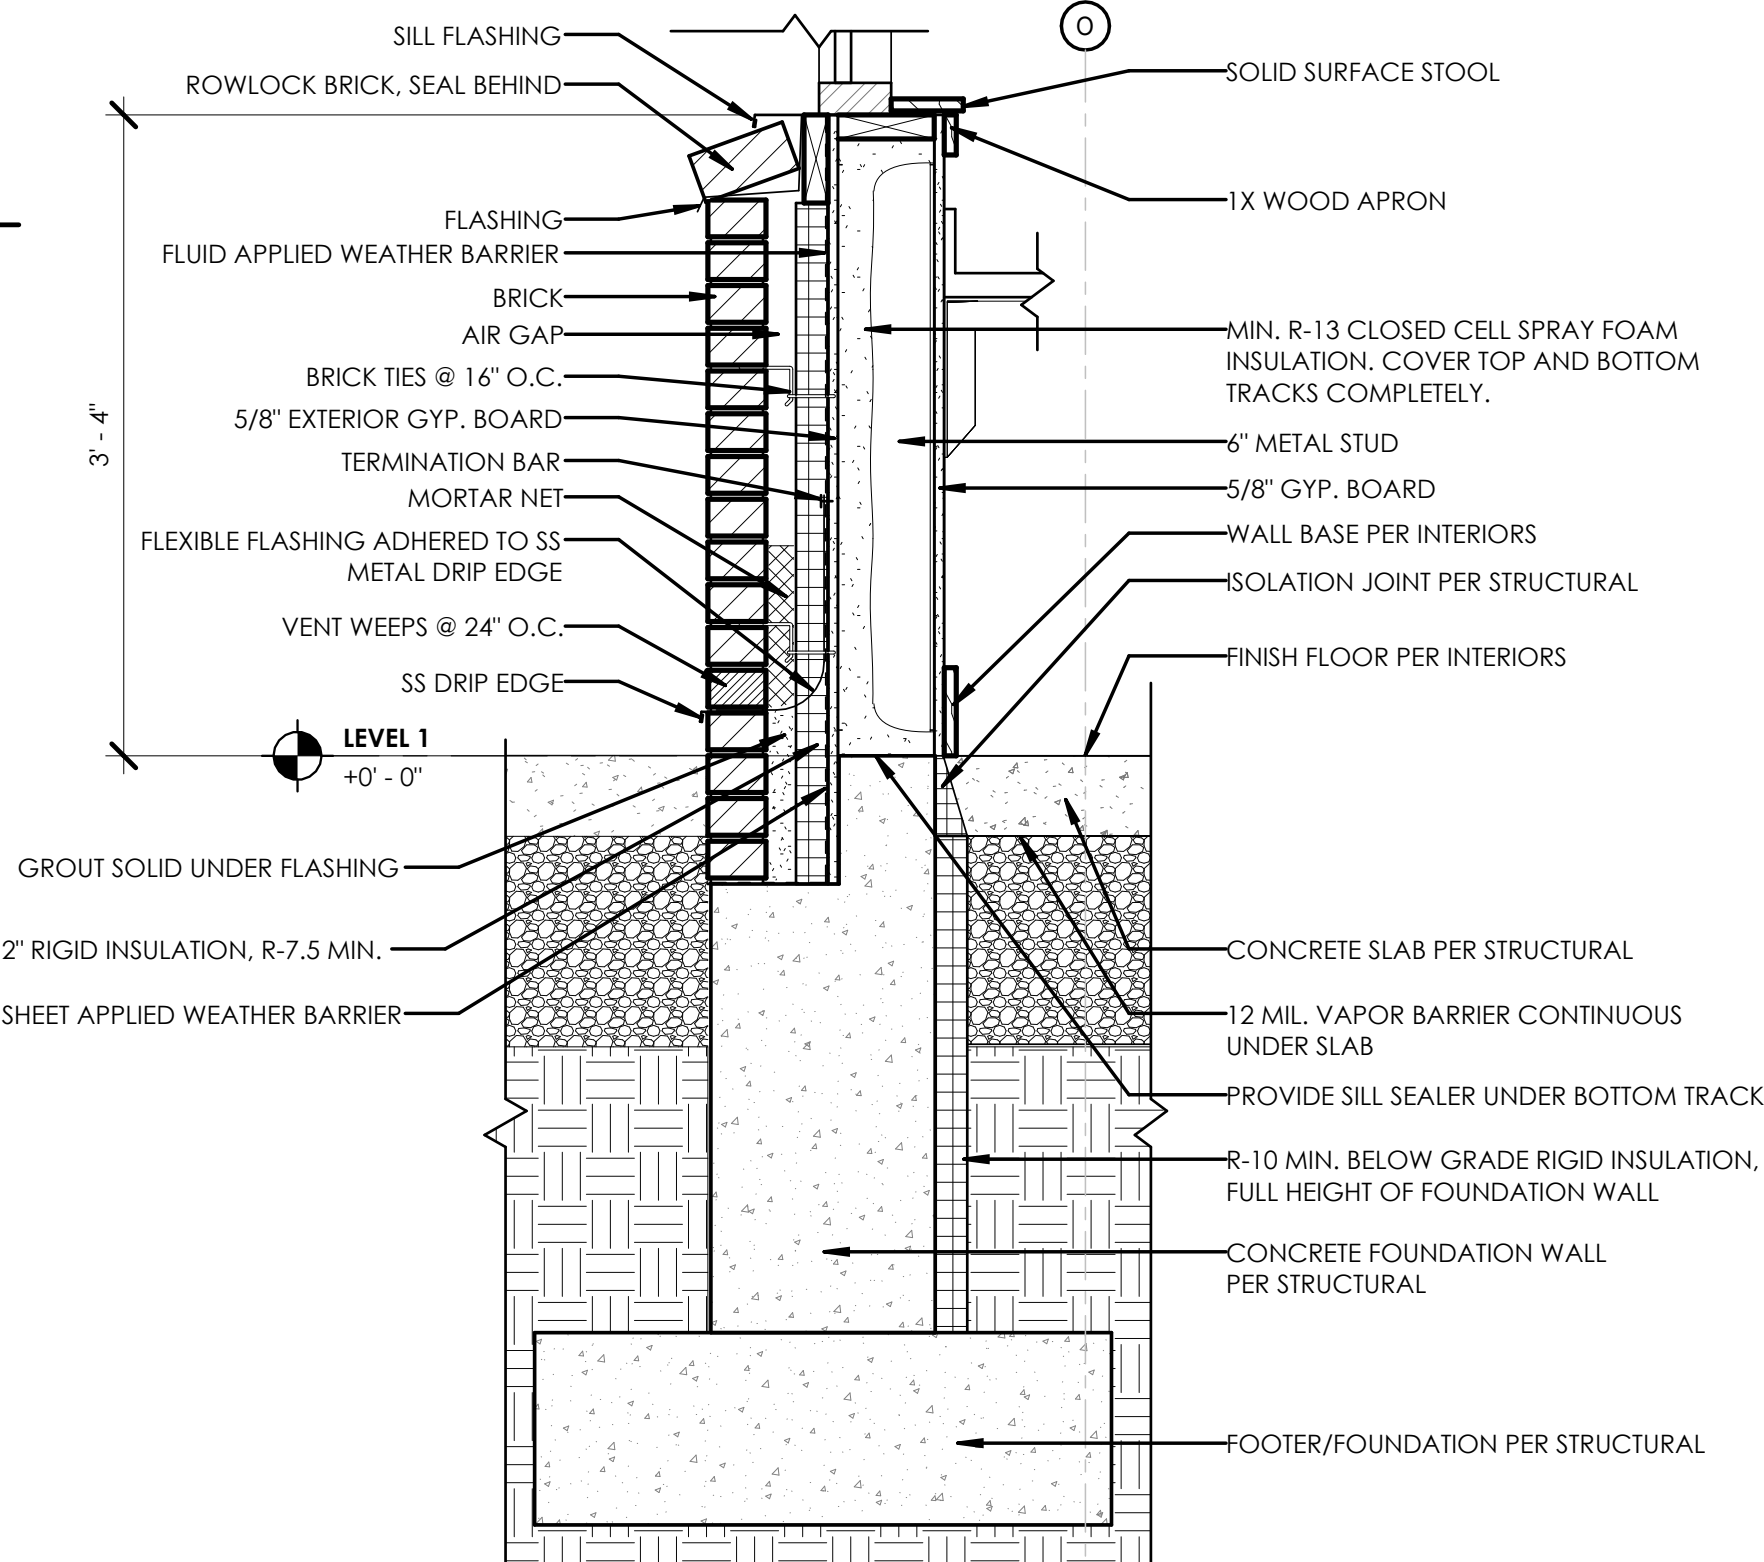
4 ROOF AT RADIO & WATCH ROOM TOWER
0' 3' 6' 1' 2'
1" = 1'-0"

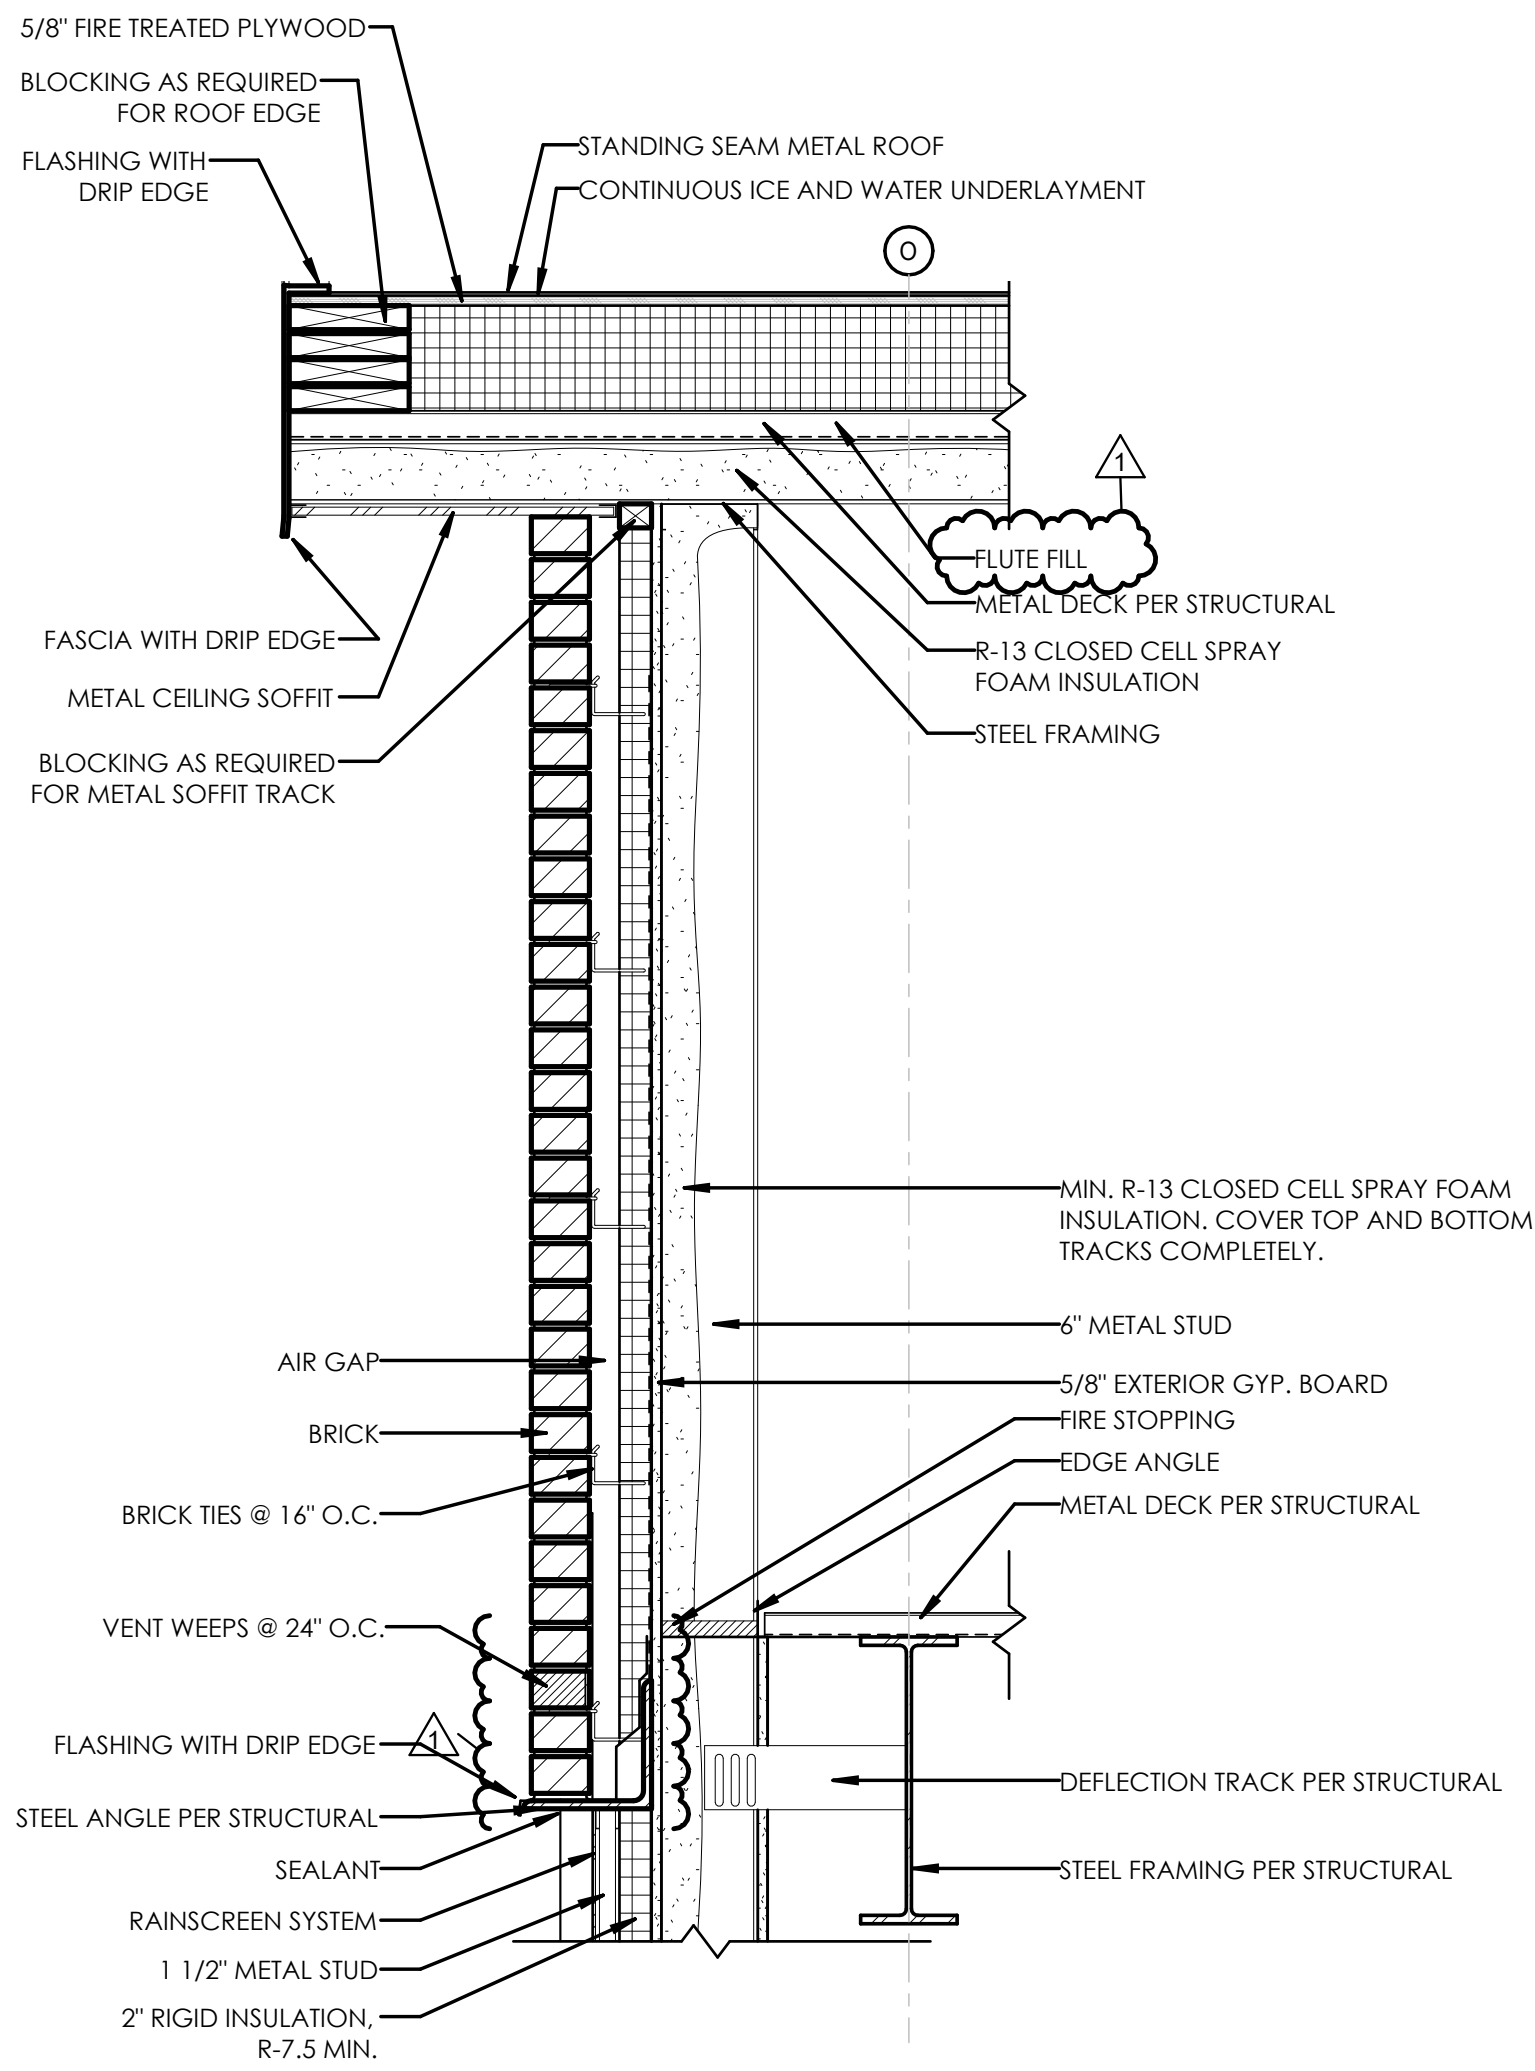



1 SECTION AT RADIO & WATCH ROOM TOWER RAINSCREEN TO STOREFRONT TRANSITION
0' 3' 6' 1' 2'
1" = 1'-0"

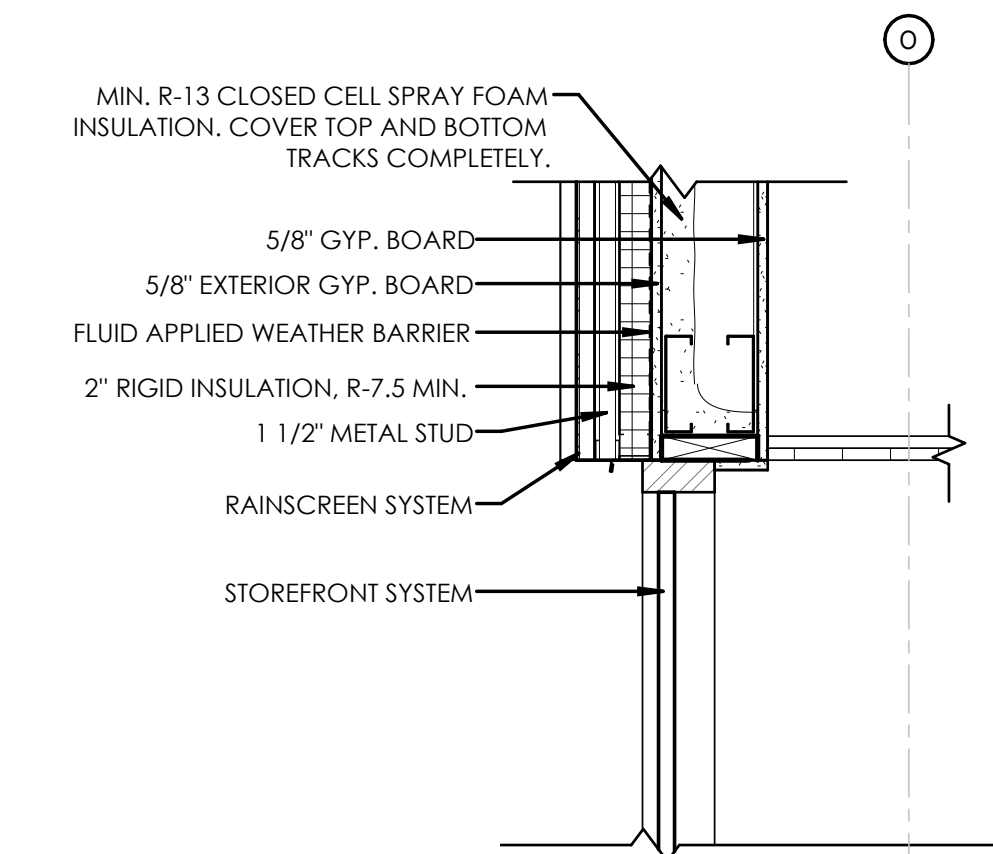

5 SECTION AT SECOND FLOOR RADIO & WATCH ROOM TOWER
0' 3' 6' 1' 2'
1" = 1'-0"

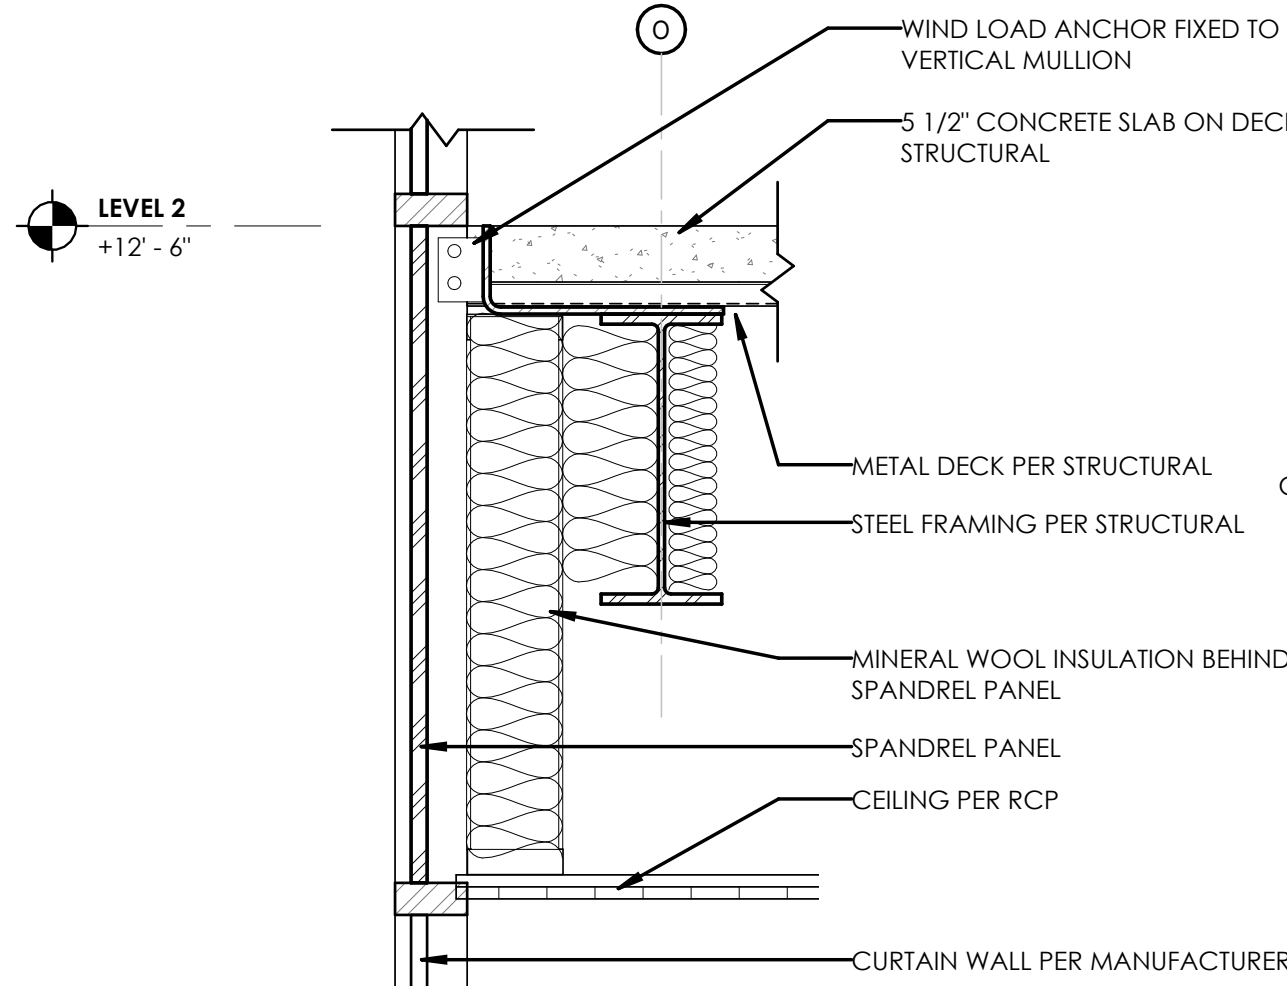

2 FOUNDATION AT RADIO & WATCH ROOM TOWER
0' 3' 6' 1' 2'
1" = 1'-0"

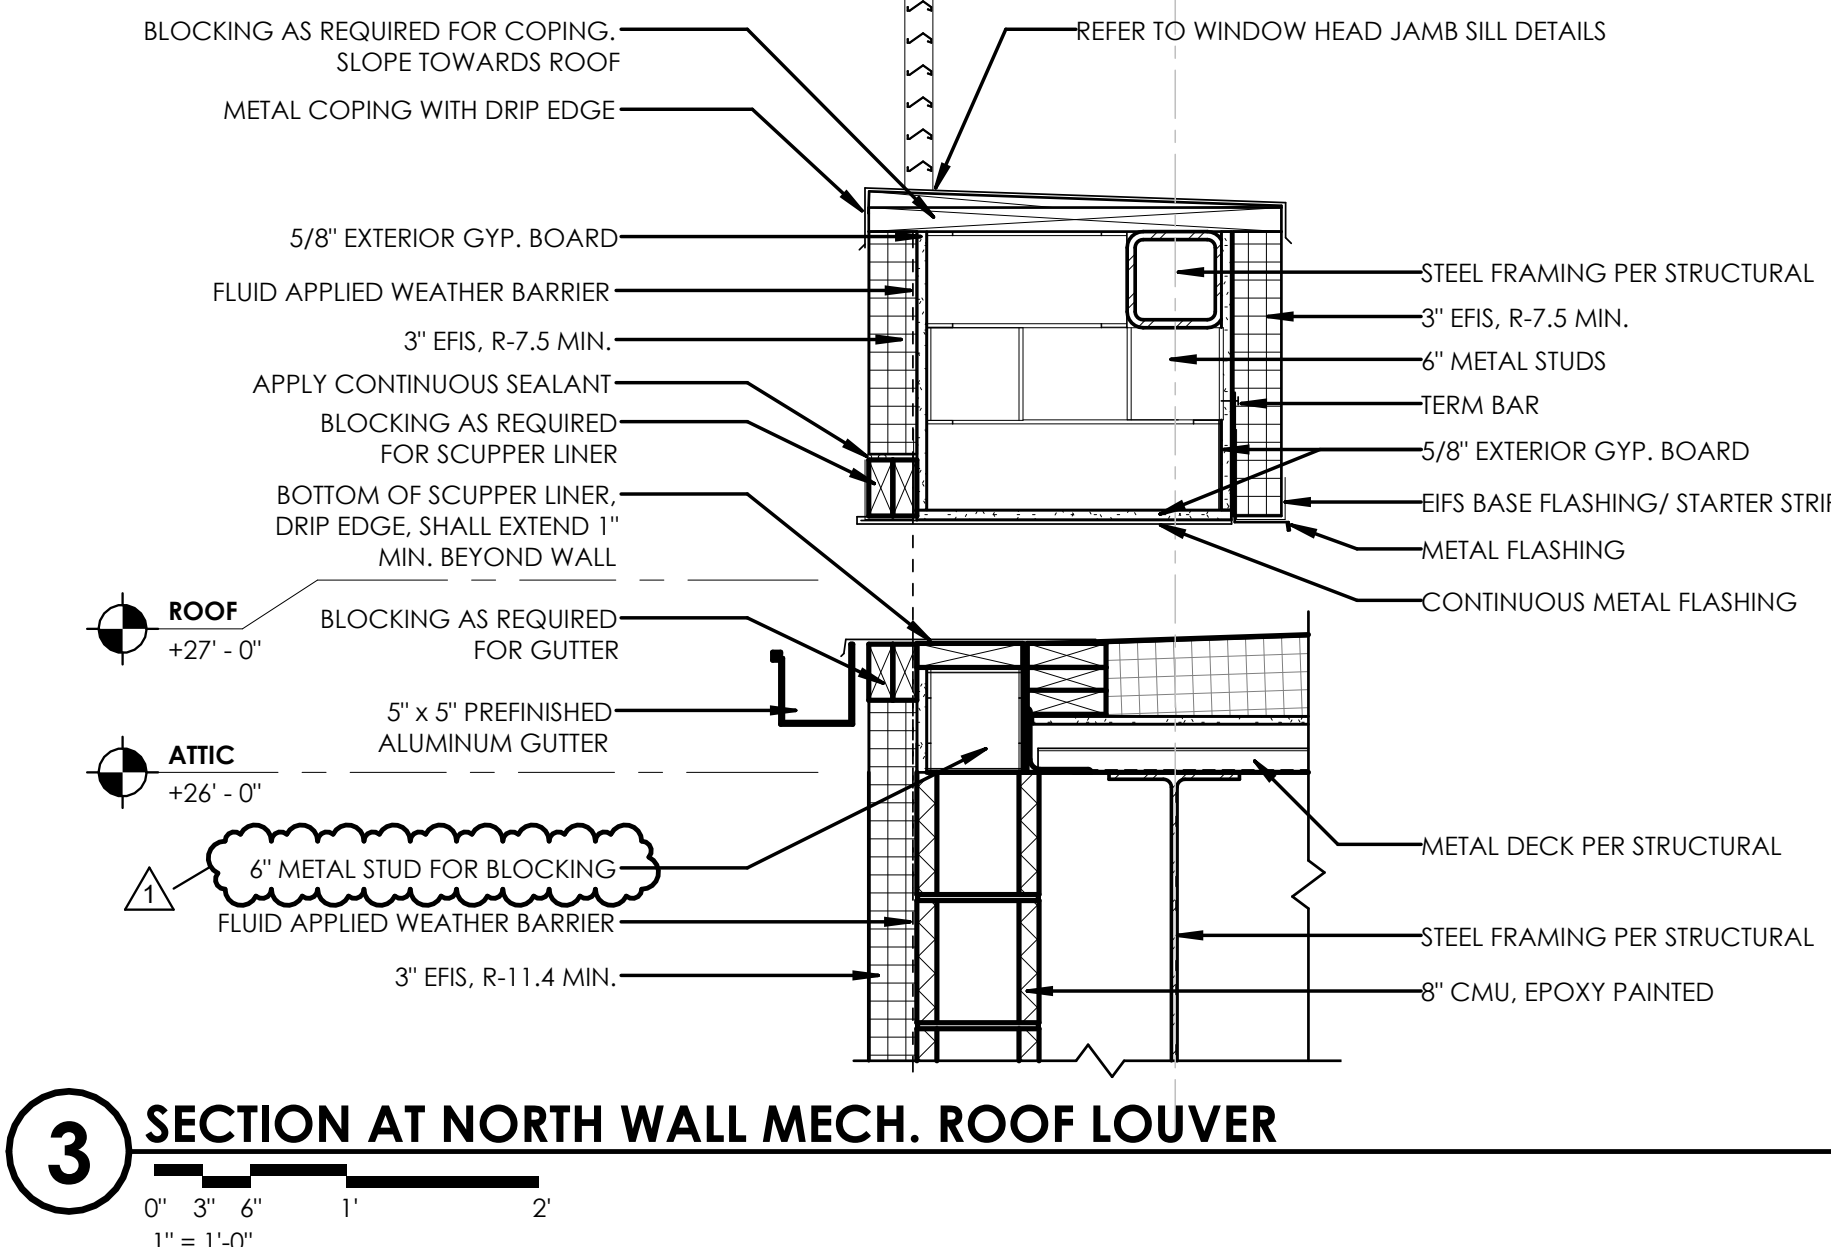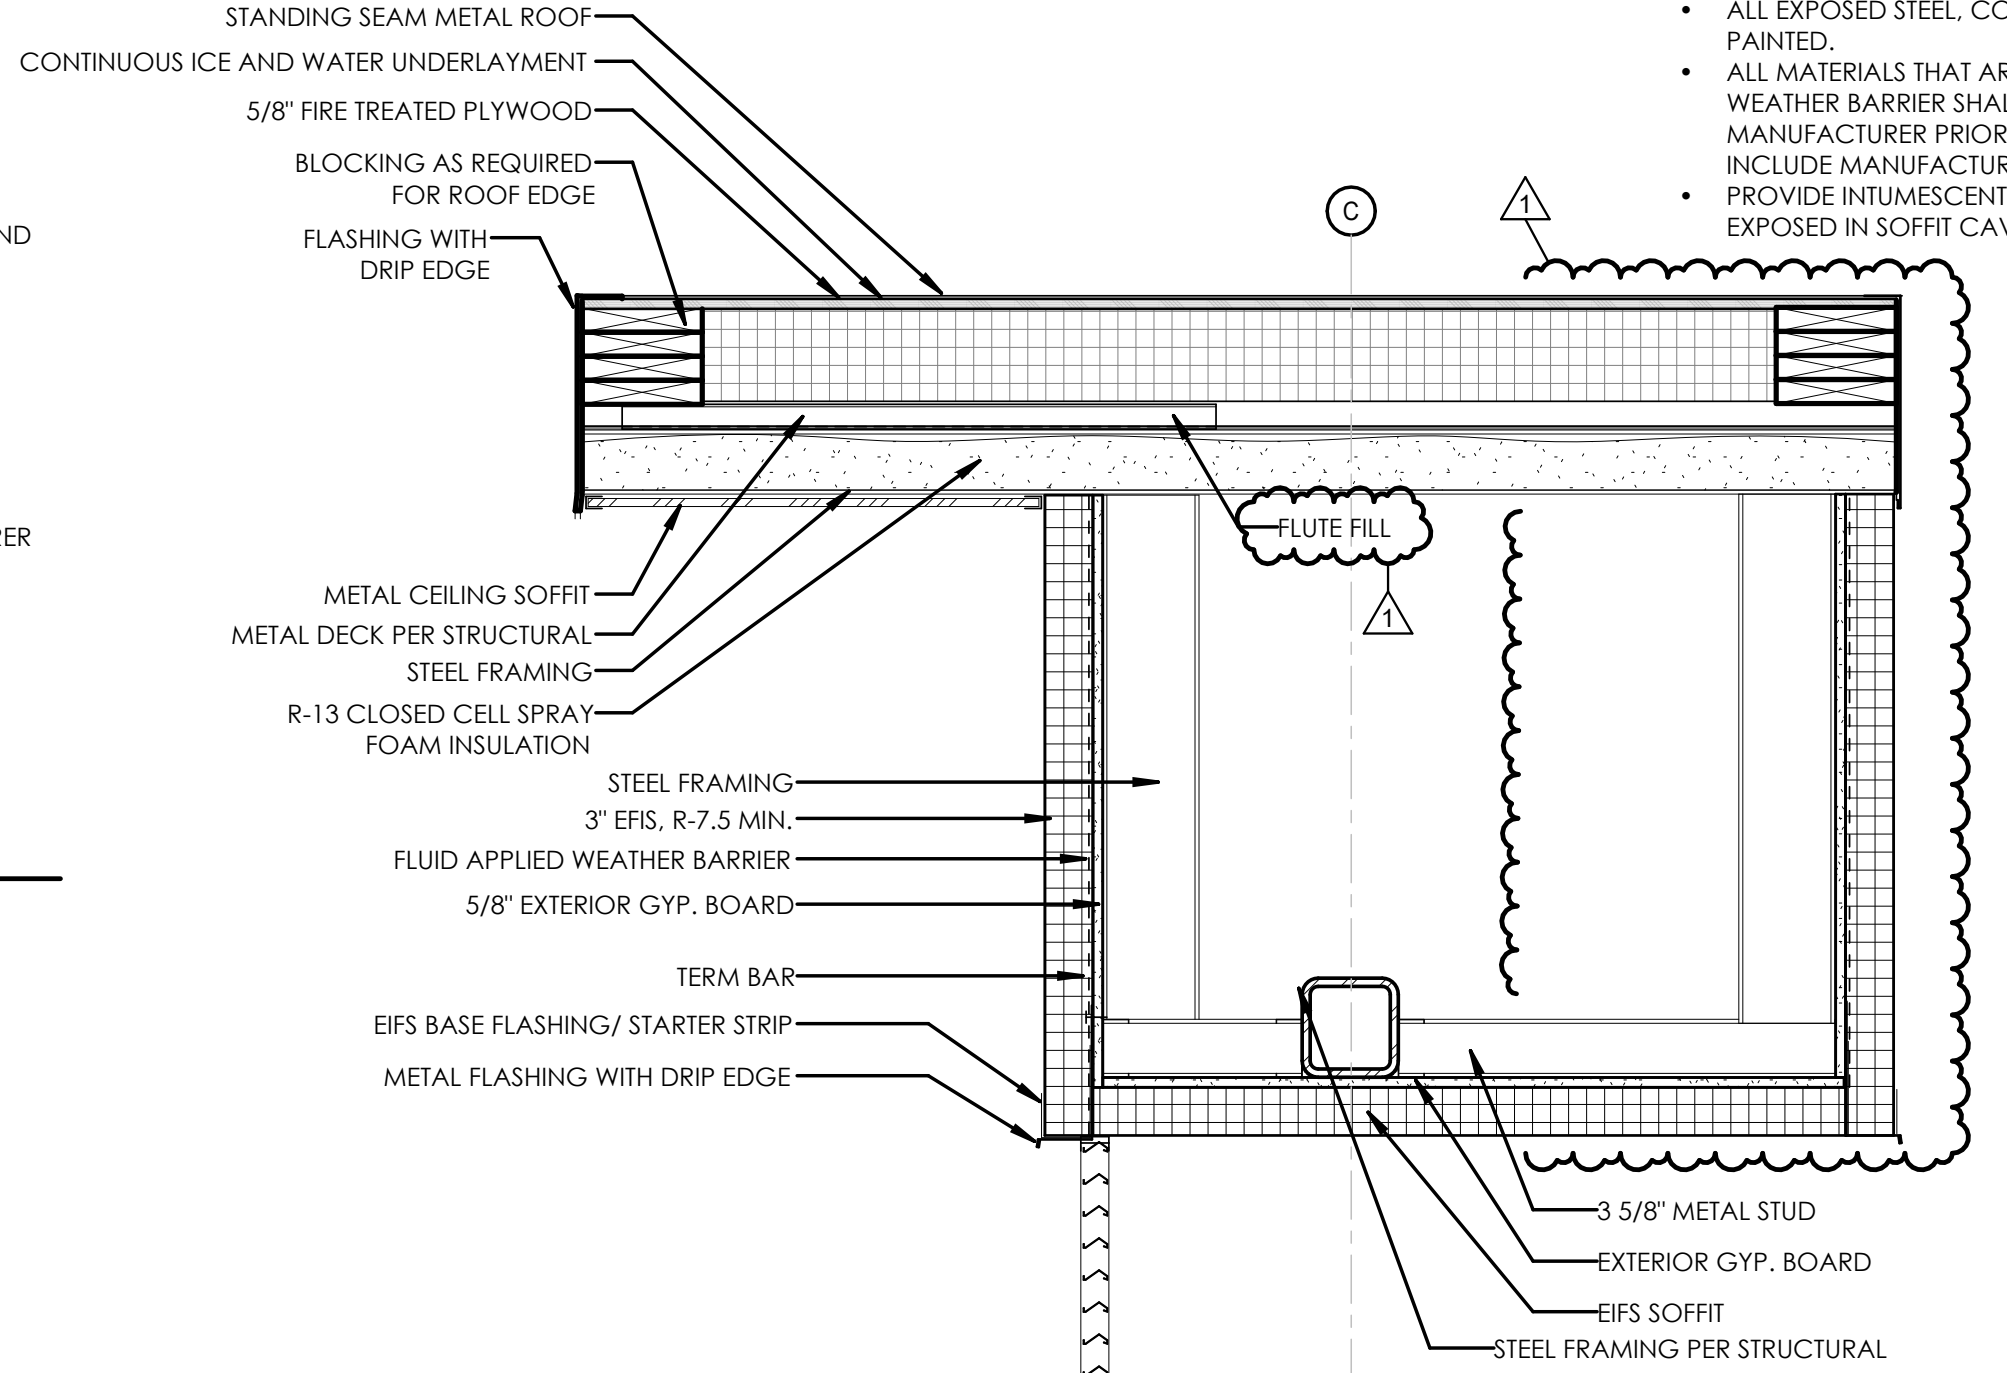

3 SECTION AT NORTH WALL MECH. ROOF LOUVER
0' 3' 6' 1' 2'
1" = 1'-0"

WALL SECTION GENERAL NOTES:

- THE CONTRACTOR SHALL REVIEW ALL DIMENSIONS AND NOTIFY THE ARCHITECT OF ANY DISCREPANCIES PRIOR TO CONSTRUCTION.
- PROVIDE THROUGH WALL FLASHING WITHIN 4" - 8" FROM FINISHED GRADE WITH WEEPS AT 16" MAXIMUM ON CENTER, MINIMUM OF (2) PER RUN AT ALL EXTERIOR MASONRY WALLS.
- ALL FLASHING SHALL EXTEND SHINGLES STYLE BEHIND THE DRAINAGE PLANE OF THE WALL SYSTEM AND SHALL SHINGLE TO DAYLIGHT. FLASHING AT FLUID APPLIED MEMBRANES SHALL BE INTEGRATED PER MEMBRANE MANUFACTURER'S RECOMMENDATIONS.
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- PROVIDE INTUMESCENT COATING ON ALL SPRAY FOAM AREAS EXPOSED IN SOFFIT CAVITIES.

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ROCHESTER, NY 14612

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ROCHESTER, NY 14614 FAX: (585) 325-1691

PROJECT MANAGER: TIM GEIER
PROJECT ARCHITECT: TIM GEIER
DESIGNER: QUILLIE HUGHES

NO.	DATE	BY	DESCRIPTION
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WALL SECTION DETAILS

1816 ENGLISH RD

NGFD - ENGLISH ROAD
STATION
TOWN/CITY: GREECE


COUNTY: MONROE STATE: NY

PROJECT NO.:
20233530.0001

DRAWING NO.:
A-318


DATE:
JANUARY 22, 2025

BID SET

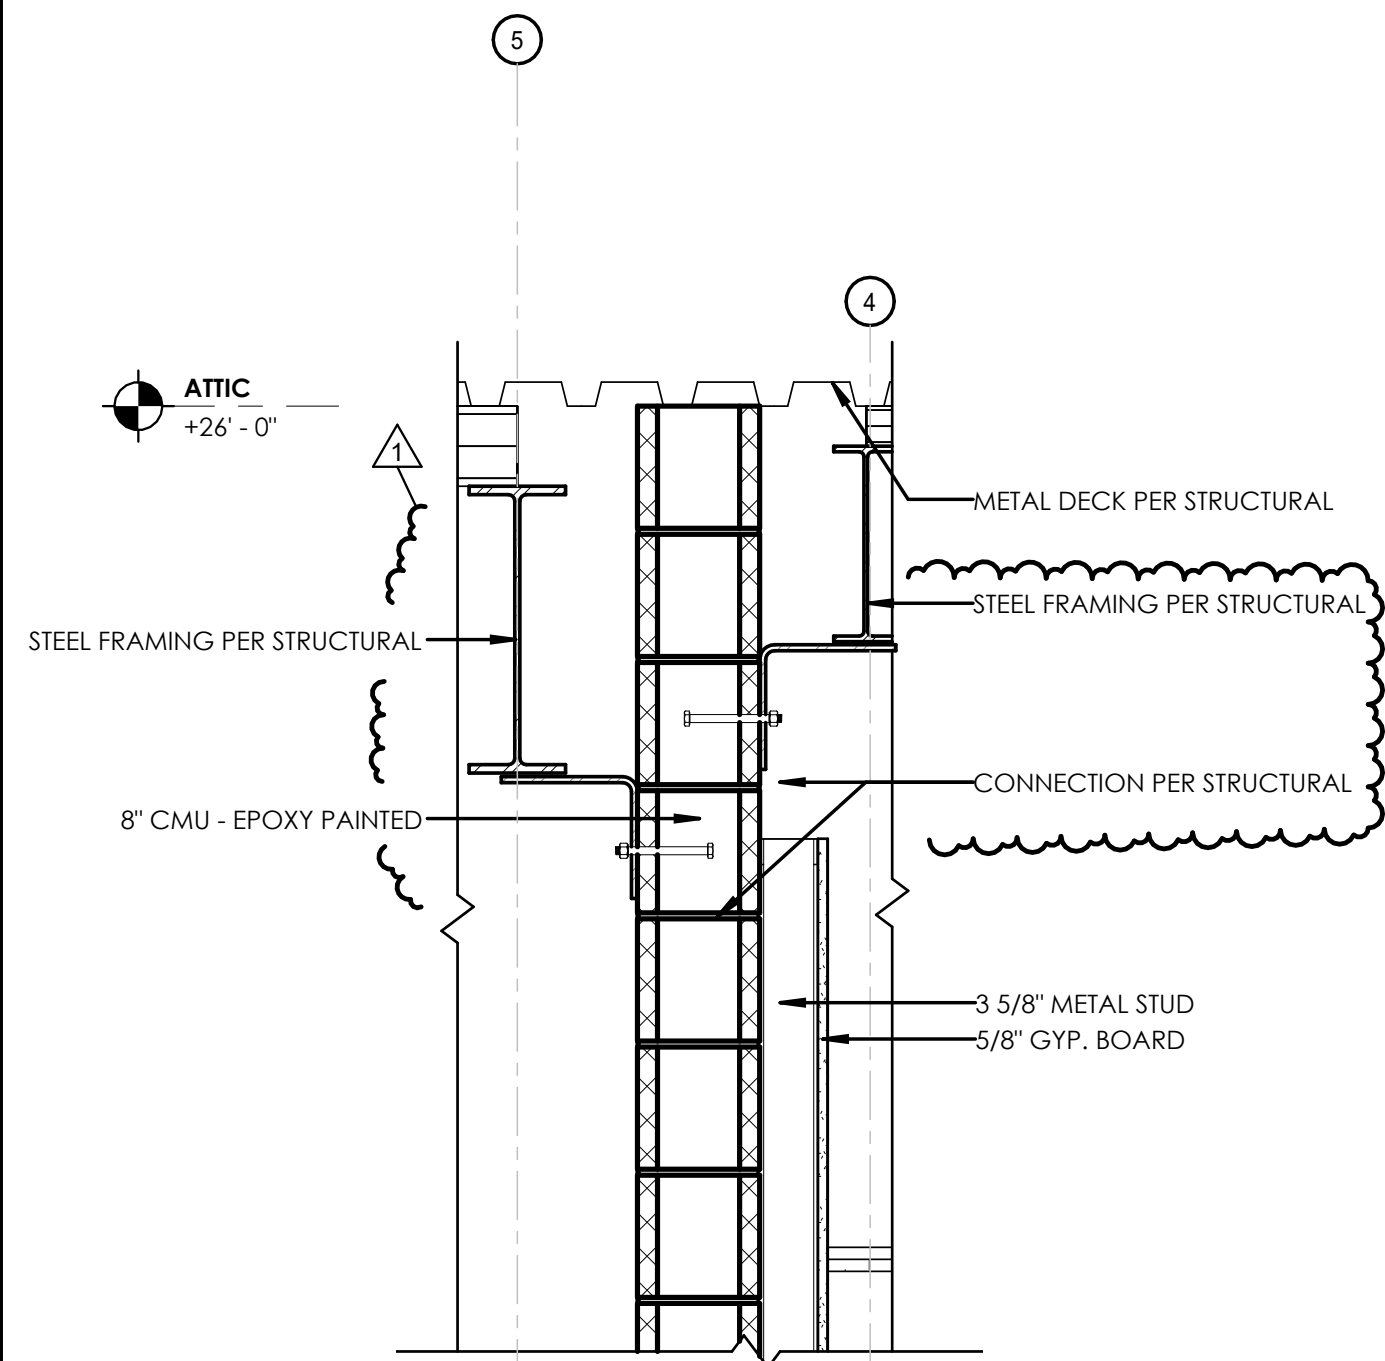


5 SECTION AT ATTIC OF INTERIOR APPARATUS WALL

0' 3' 6' 1' 2'
1" = 1'-0"

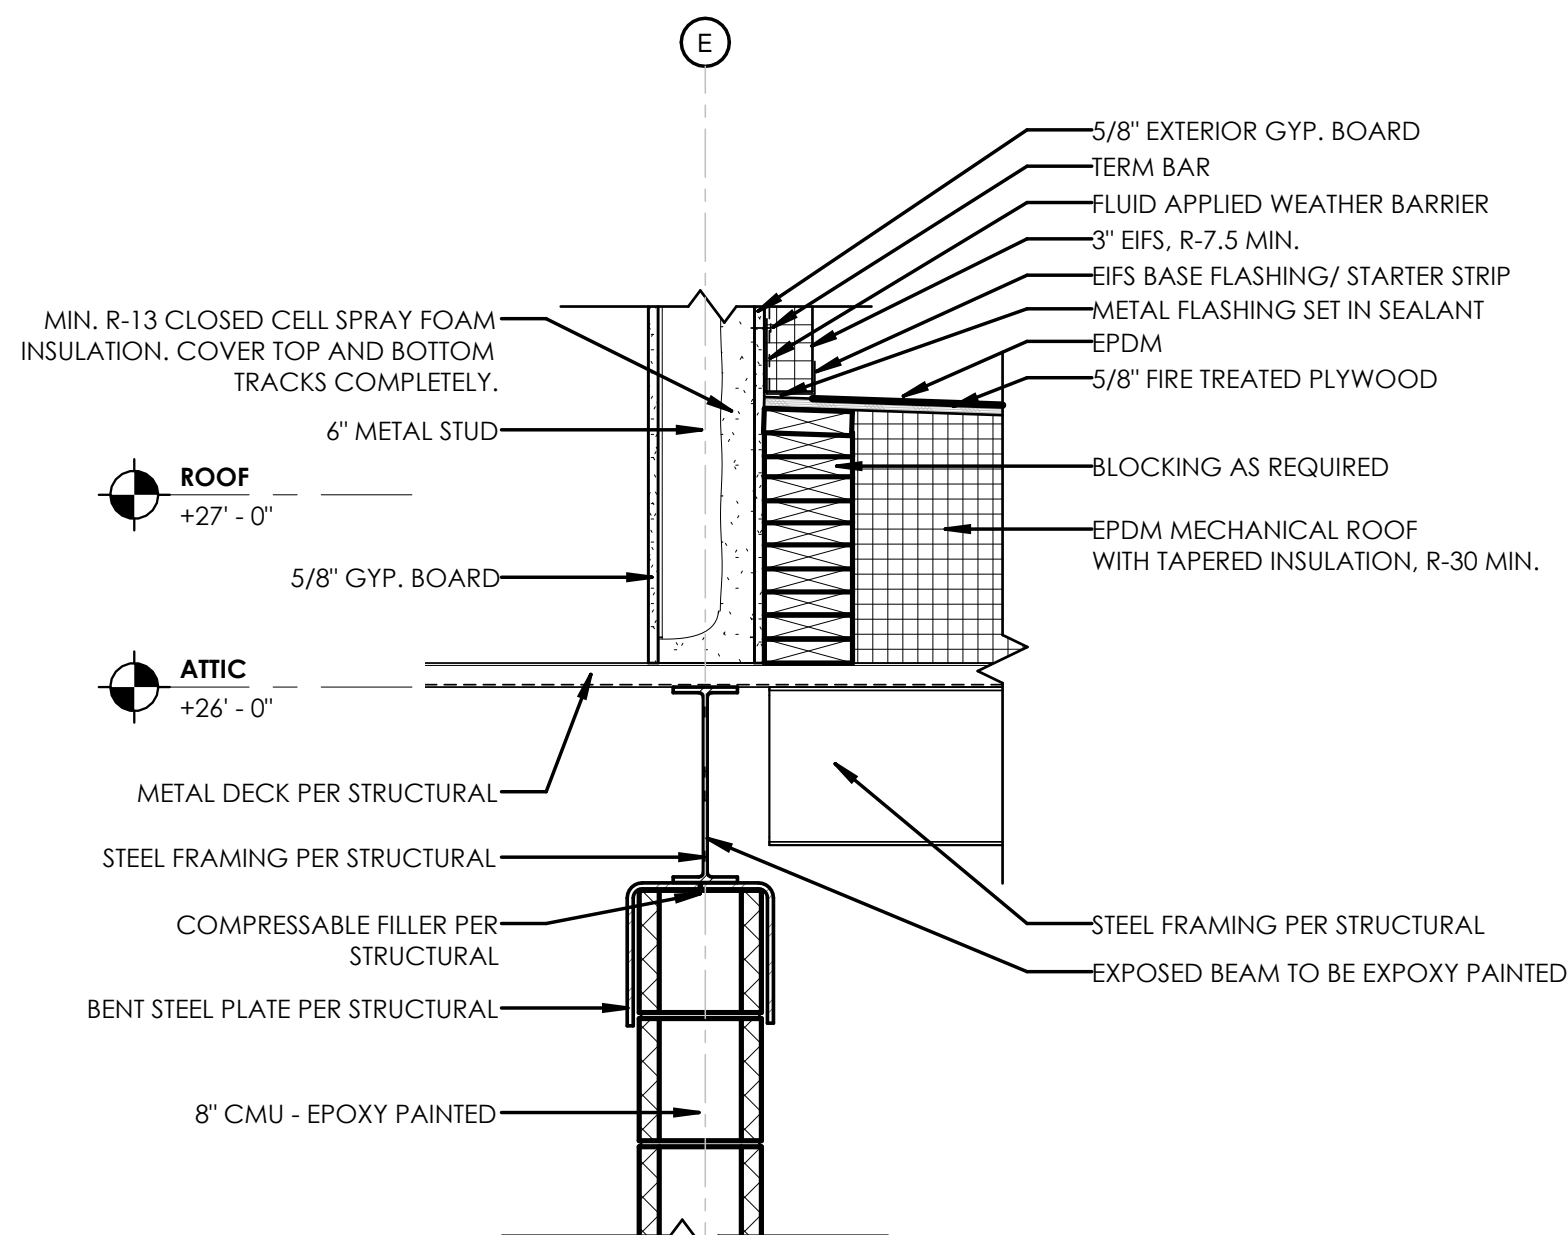


6 SECTION AT ATTIC OF MEZZANINE

0' 3' 6' 1' 2'
1" = 1'-0"

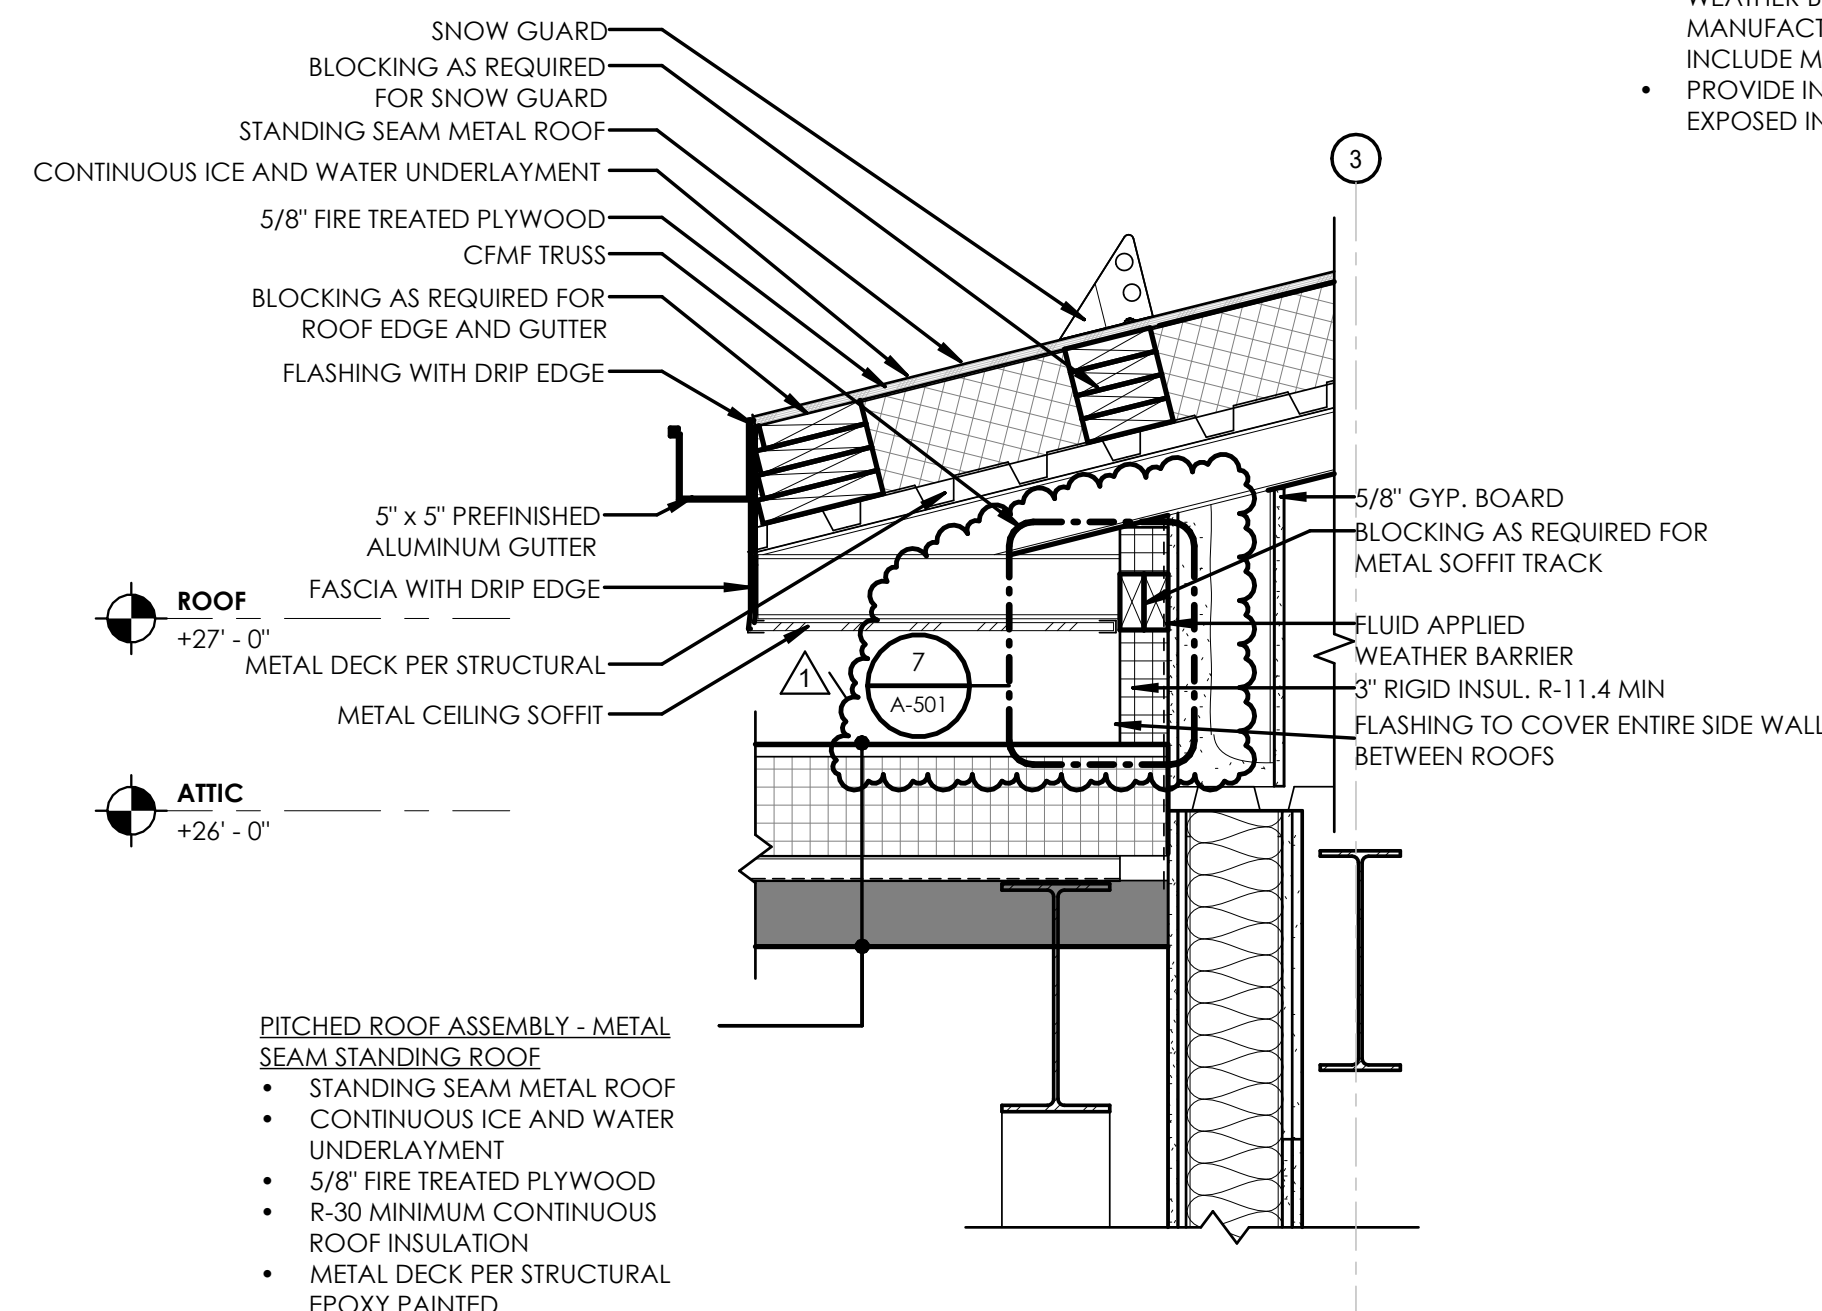


7 SECTION AT FITNESS ROOM CORRIDOR ROOF CONDITION

0' 3' 6' 1' 2'
1" = 1'-0"

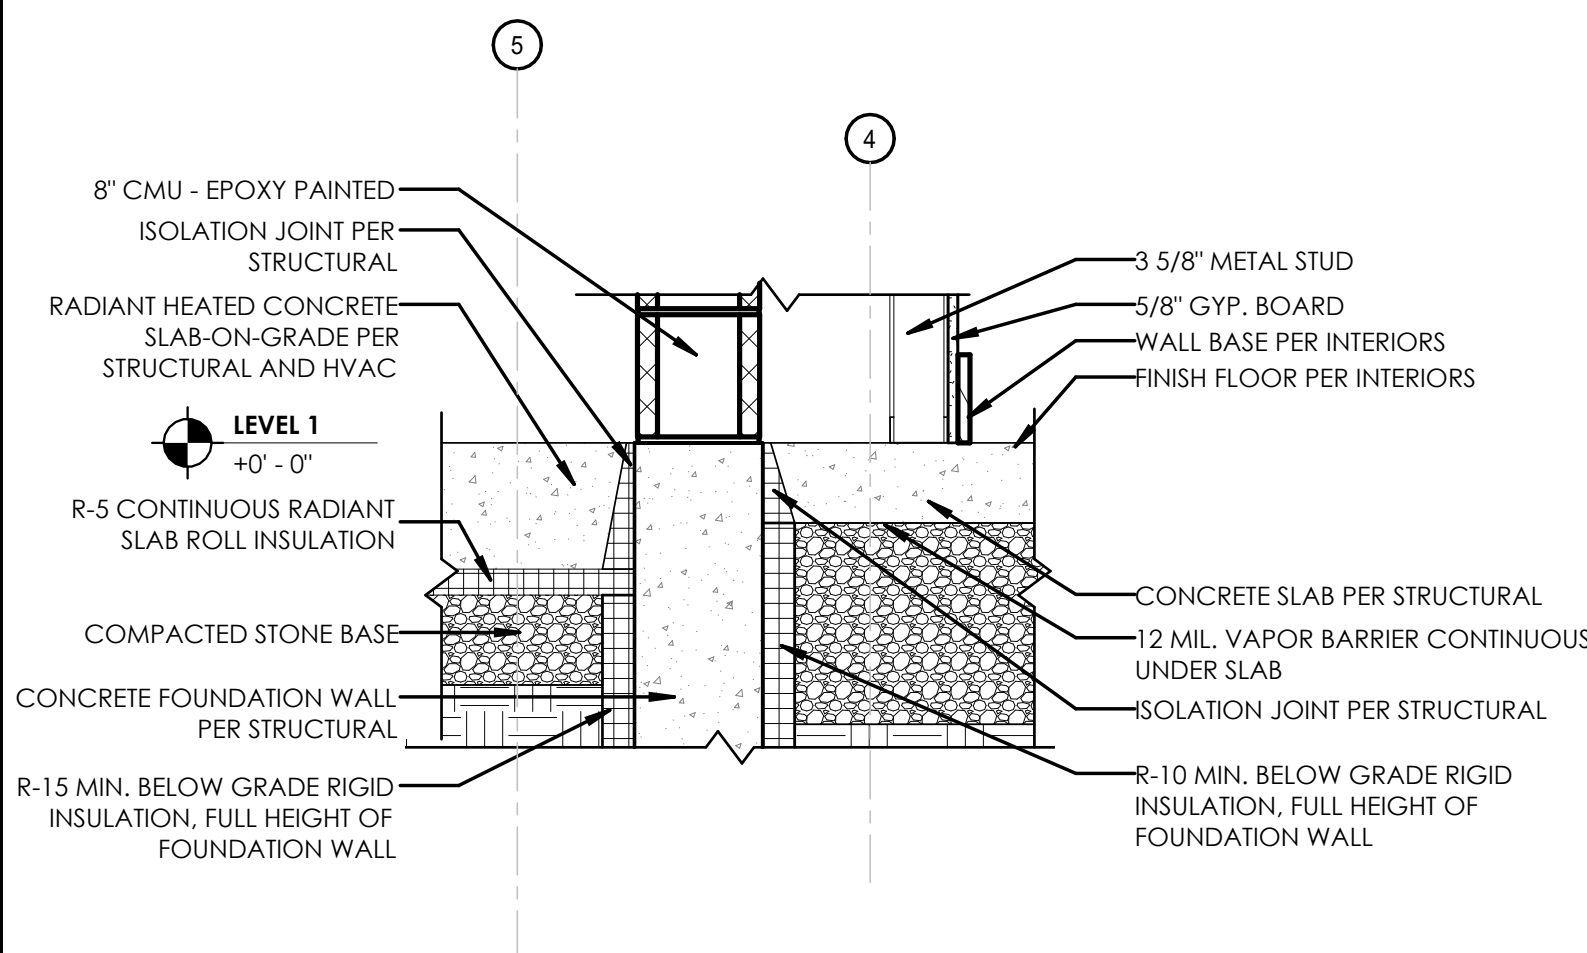


1 SECTION AT LEVEL 1 OF INTERIOR APPARATUS WALL

0' 3' 6' 1' 2'
1" = 1'-0"

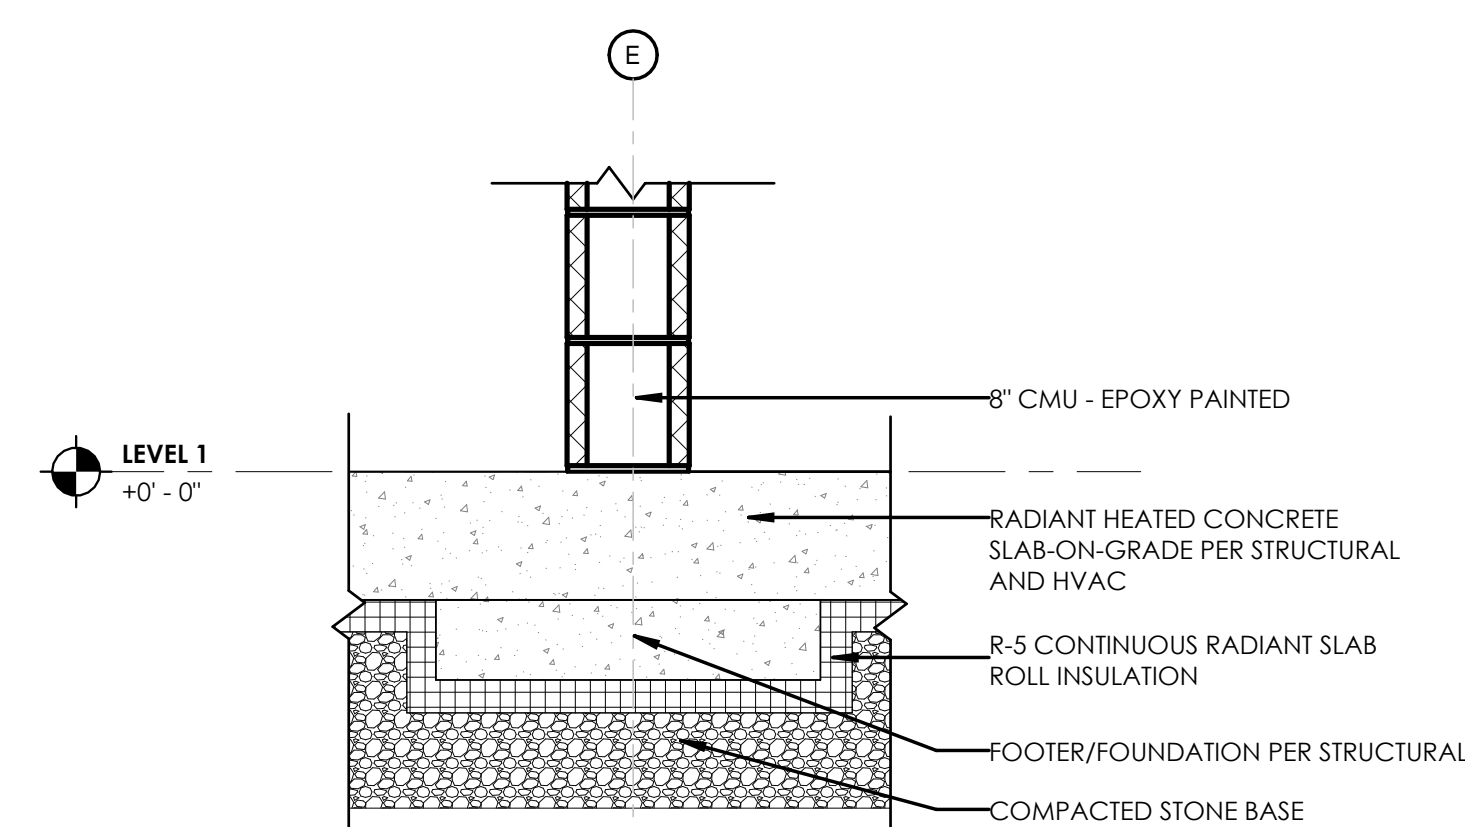


2 SECTION AT LEVEL 1 OF MEZZANINE

0' 3' 6' 1' 2'
1" = 1'-0"

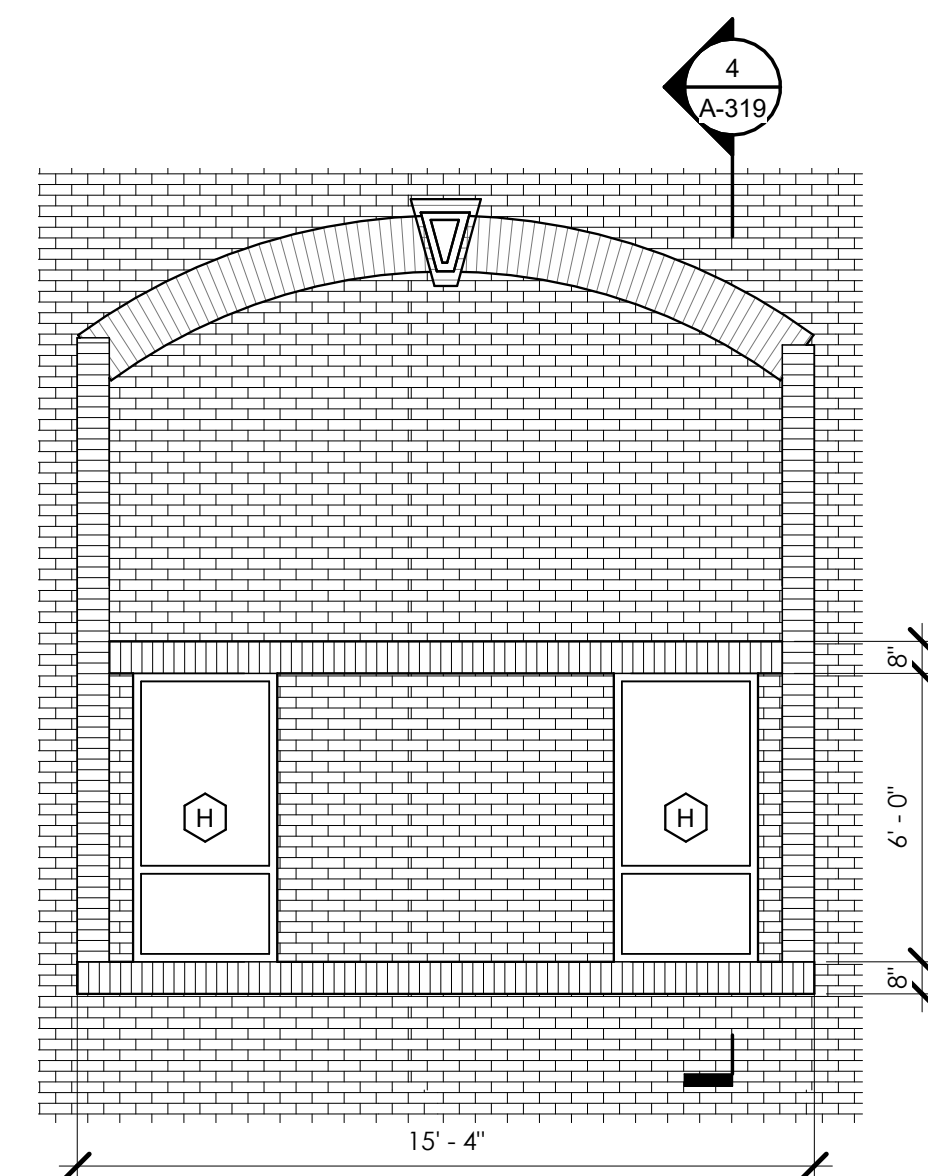

3 WEST ELEVATION BRICK EXTRUSION

0' 1' 2' 4' 8'
1/4" = 1'-0"

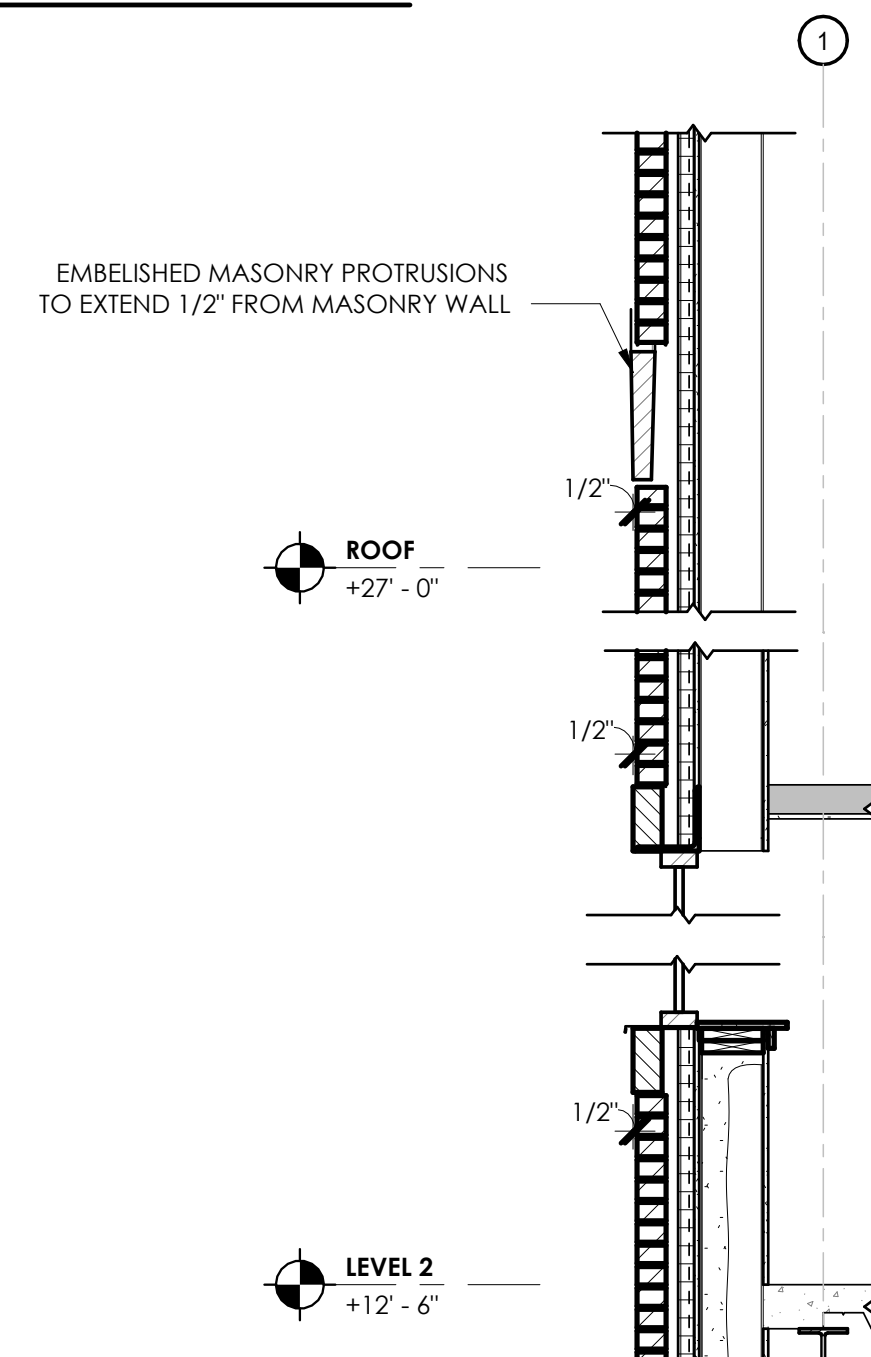

4 SECTION AT BRICK EXTRUSION

0' 6' 1' 2' 4'
1/2" = 1'-0"

WALL SECTION GENERAL NOTES:

- THE CONTRACTOR SHALL REVIEW ALL DIMENSIONS AND NOTIFY THE ARCHITECT OF ANY DISCREPANCIES PRIOR TO CONSTRUCTION.
- PROVIDE THROUGH WALL FLASHING WITHIN 4" - 8" FROM FINISHED GRADE WITH WEEPS AT 16" MAXIMUM ON CENTER, MINIMUM OF (2) PER RUN AT ALL EXTERIOR MASONRY WALLS.
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- PROVIDE INTUMESCENT COATING ON ALL SPRAY FOAM AREAS EXPOSED IN SOFFIT CAVITIES.

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CLIENT:
N. GREECE FIRE DISTRICT
1766 LATTA RD
ROCHESTER, NY 14612

Passero Associates

242 WEST MAIN ST., SUITE 100 (585) 325-1000
ROCHESTER, NY 14614 FAX: (585) 325-1691

PROJECT MANAGER: TIM GEIER
PROJECT ARCHITECT: TIM GEIER
DESIGNER: TIM GEIER, QUILLIE HUGHES

NO.	DATE	BY	DESCRIPTION
1	01/30/25		ADDENDUM 1

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WALL SECTION DETAILS

1816 ENGLISH RD

NGFD - ENGLISH ROAD
STATION
TOWN/CITY: GREECE

COUNTY: MONROE STATE: NY

PROJECT NO.:

20233530.0001

DRAWING NO.:

A-319

DATE:

JANUARY 22, 2025

BID SET

GENERAL NOTES - INTERIOR ELEVATIONS:






1. REFER TO I-600 FOR FINISH LEGEND AND I-601 FOR FINISH SCHEDULE
2. REFER TO I-100 SERIES FOR FINISH PLANS
3. REFER TO A-505 TO A-509 FOR MILLWORK DETAILS
4. REFER TO I-500 FOR INTERIOR DETAILS
5. TILE TRIM PROFILE HEIGHT AS REQUIRED TO COORDINATE WITH TILE SELECTION AND SETTING SYSTEM
6. ALIGN WALL TILE / BASE GROUT LINES WITH FLOOR TILE GROUT LINES
7. MATERIALS SHALL BE INSTALLED IN COMPLIANCE WITH MANUFACTURERS PRODUCTS AND METHODS

FLOOR PLAN GENERAL NOTES:

- REFER TO SHEET G-001 FOR WALL TYPES
- DIMENSION STYLES
 - METAL STUD WALLS (INTERIOR) ARE DIMENSIONED TO CENTER OF STUD.
 - METAL STUD WALLS (EXTERIOR) ARE DIMENSIONED TO FACE OF STUD.
 - MASONRY WALLS ARE DIMENSIONED TO FACE OF MASONRY.
- THE CONTRACTOR SHALL REVIEW ALL DIMENSIONS AND NOTIFY THE ARCHITECT OF ANY DISCREPANCIES PRIOR TO CONSTRUCTION.
- PROVIDE BLOCKING AT ALL TV/MONITOR AND FUTURE TV/MONITOR LOCATIONS. REFER TO ELECTRICAL DRAWINGS FOR LOCATIONS.
- ALL WORK COMPLETED AS PART OF THIS PROJECT SHALL MEET ALL APPLICABLE FEDERAL, STATE, AND LOCAL CODES, AND SHALL MEET THE REQUIREMENTS OF THE OWNER AND LOCAL JURISDICTION.
- ALL PENETRATIONS THROUGH RATED ASSEMBLIES SHALL BE SEALED IN ACCORDANCE WITH THE LATEST EDITION OF THE NYS BUILDING CODE.
- COMBUSTIBLE MATERIALS ARE NOT PERMITTED IN CONCEALED SPACES UNLESS ALLOWED BY EXCEPTION IN THE NYS BUILDING CODE.
- ALL MATERIALS INSTALLED IN CONTACT WITH THE WEATHER BARRIER SHALL BE REVIEWED FOR COMPATIBILITY BY THE MANUFACTURER PRIOR TO SUBMITTAL. ALL SUCH SUBMITTALS SHALL INCLUDE MANUFACTURER'S CERTIFICATE OF COMPATIBILITY.
- ALL INTERIOR COLUMNS ARE TO BE WRAPPED WITH 1/4" METAL FURRING AND 5/8" GYP. BD. U.N.O.

KEYNOTES - ELEVATIONS INTERIOR

NO.	DESCRIPTION
1	EMERGENCY EYEWASH STATION
2	TURNOUT GEAR WASHING MACHINE
3	DRYER
4	KITCHEN SINK PER PLUMBING
5	DISHWASHER - OWNER PROVIDED, INSTALLED BY GC
6	COFFEE STATION - HARD PIPED PER PLUMBING. OWNER PROVIDED, INSTALLED BY GC
7	MICROWAVE - OWNER PROVIDED, INSTALLED BY GC
8	GAS COOKTOP - OWNER PROVIDED, INSTALLED BY GC
9	RANGE HOOD - PROVIDED AND INSTALLED BY HVAC
10	LARGE SIZE RESIDENTIAL REFRIGERATOR W/ ICE MAKER - OWNER PROVIDED, INSTALLED BY GC
11	DRINKING FOUNTAIN W/ WATER BOTTLE FILLER
12	BENCH
13	FLOATING SHELVES
14	MOP SINK
15	MOP RACK
16	GEAR LOCKER
17	DISPLAY CASE
19	PANTRY
20	4x8x1/2" UBOLT EMBED IN CMU FOR LADDER TIE OFF POINTS
21	DOUBLE OVEN - OWNER PROVIDED, INSTALLED BY GC
22	TRASH DRAWER. REFER TO MILLWORK DETAILS
23	RECYCLING DRAWER. REFER TO MILLWORK DETAILS
24	FULL HEIGHT LOCKERS
24	LOCKERS - 72"H X 24"W X 24"D
25	HALF LOCKERS
26	FIRE EXTINGUISHER
27	STACKED RESIDENTIAL WASHER AND DRYER UNIT - PROVIDED AND INSTALLED BY OWNER
28	FLOOR DRAIN PER MEP
29	TV DISPLAY - PROVIDED AND INSTALLED BY OWNER
30	ALTERNATING TREAD DEVICE TO ATTIC

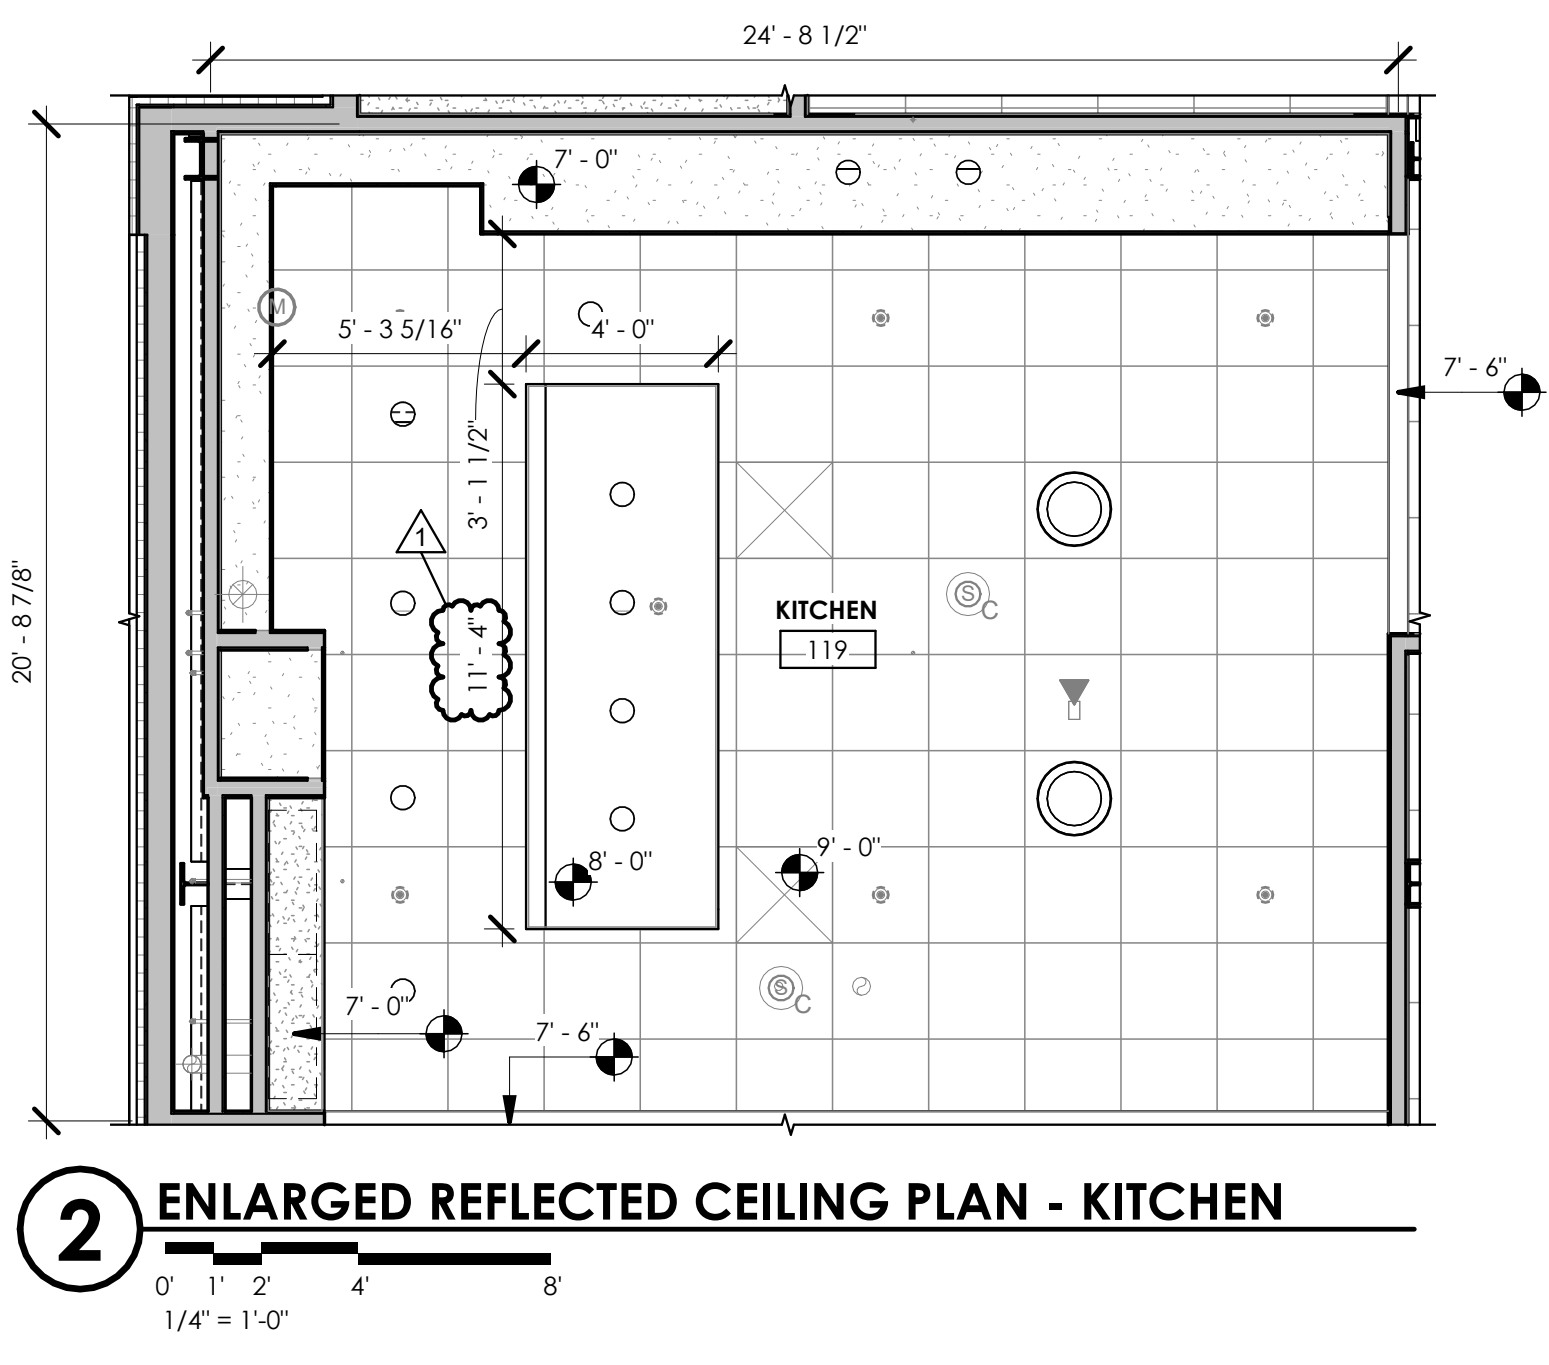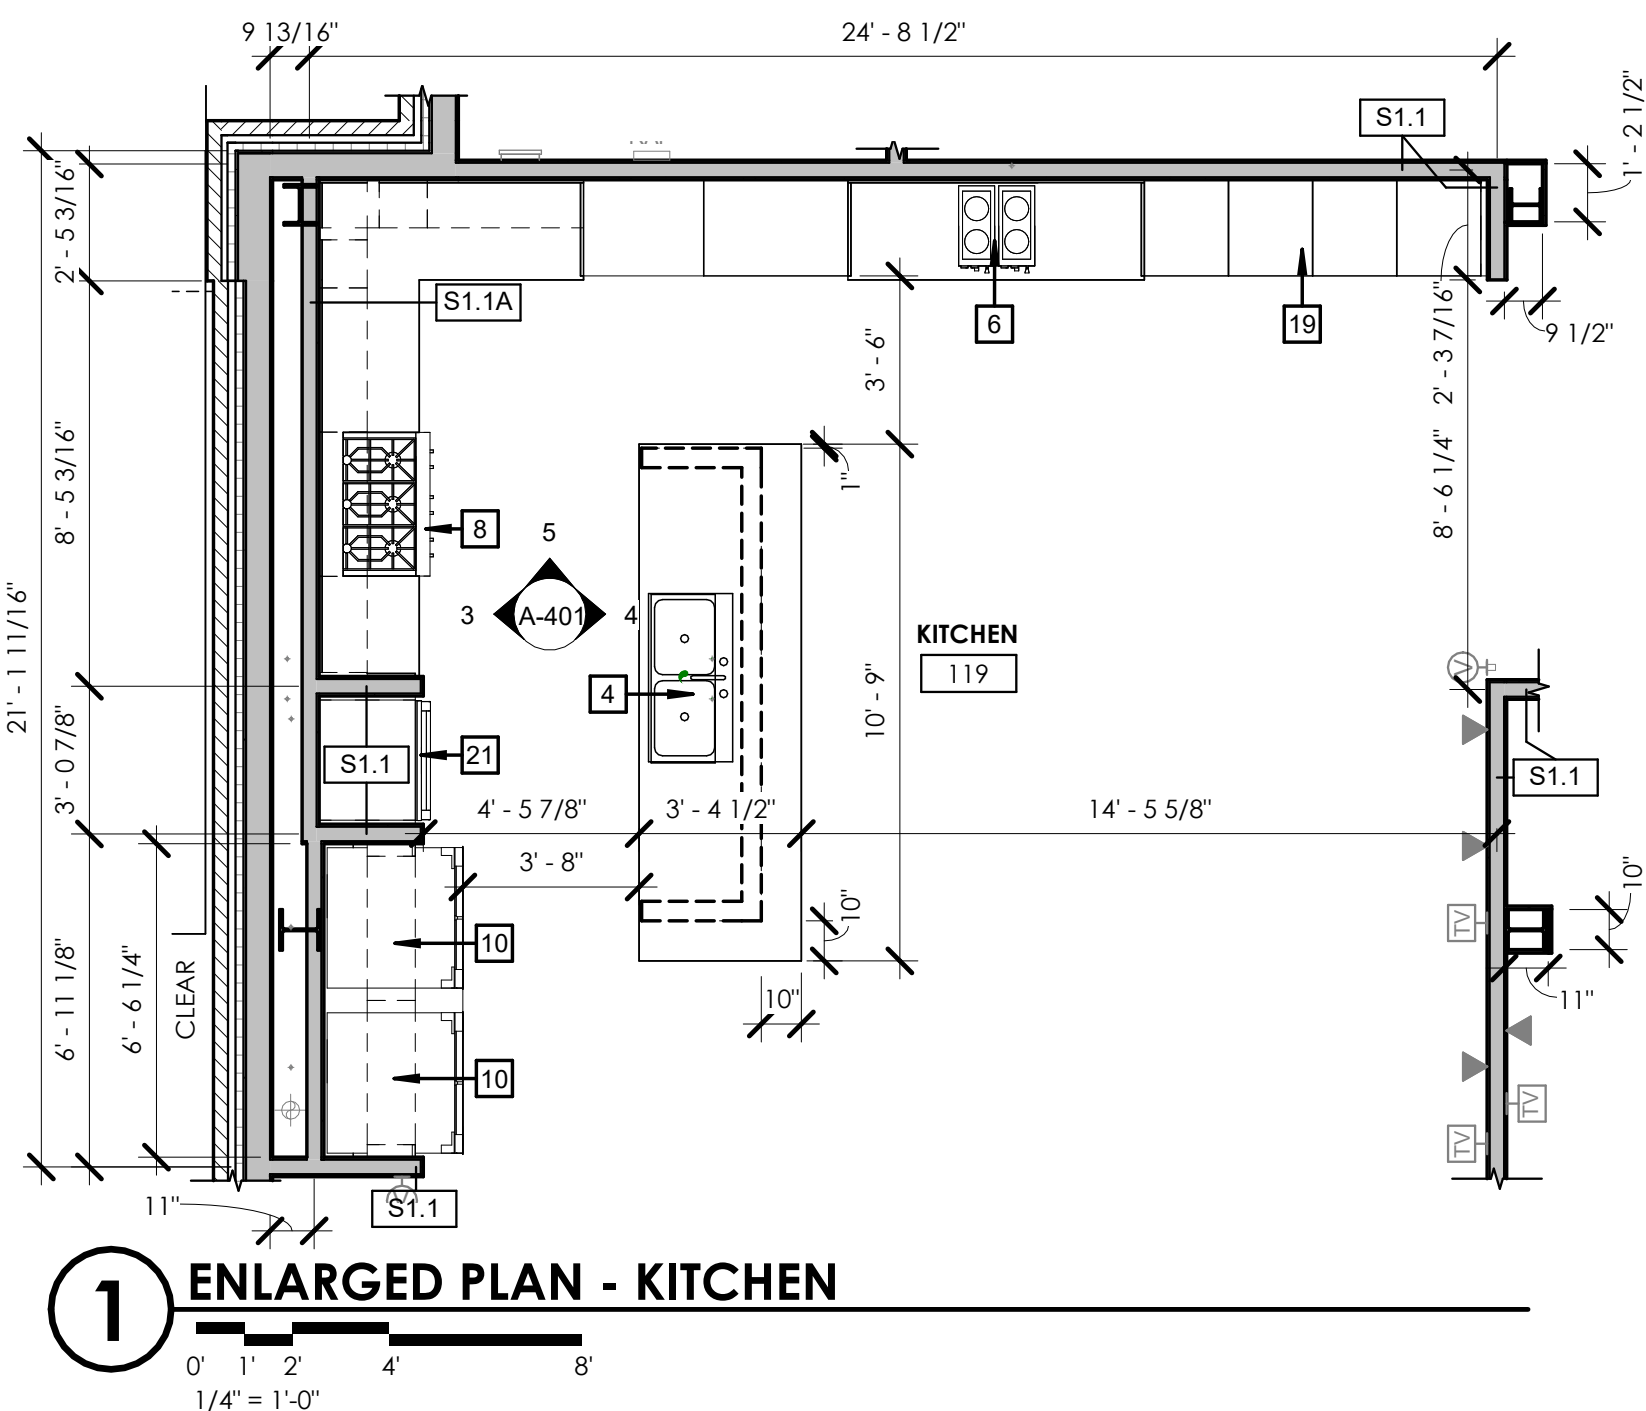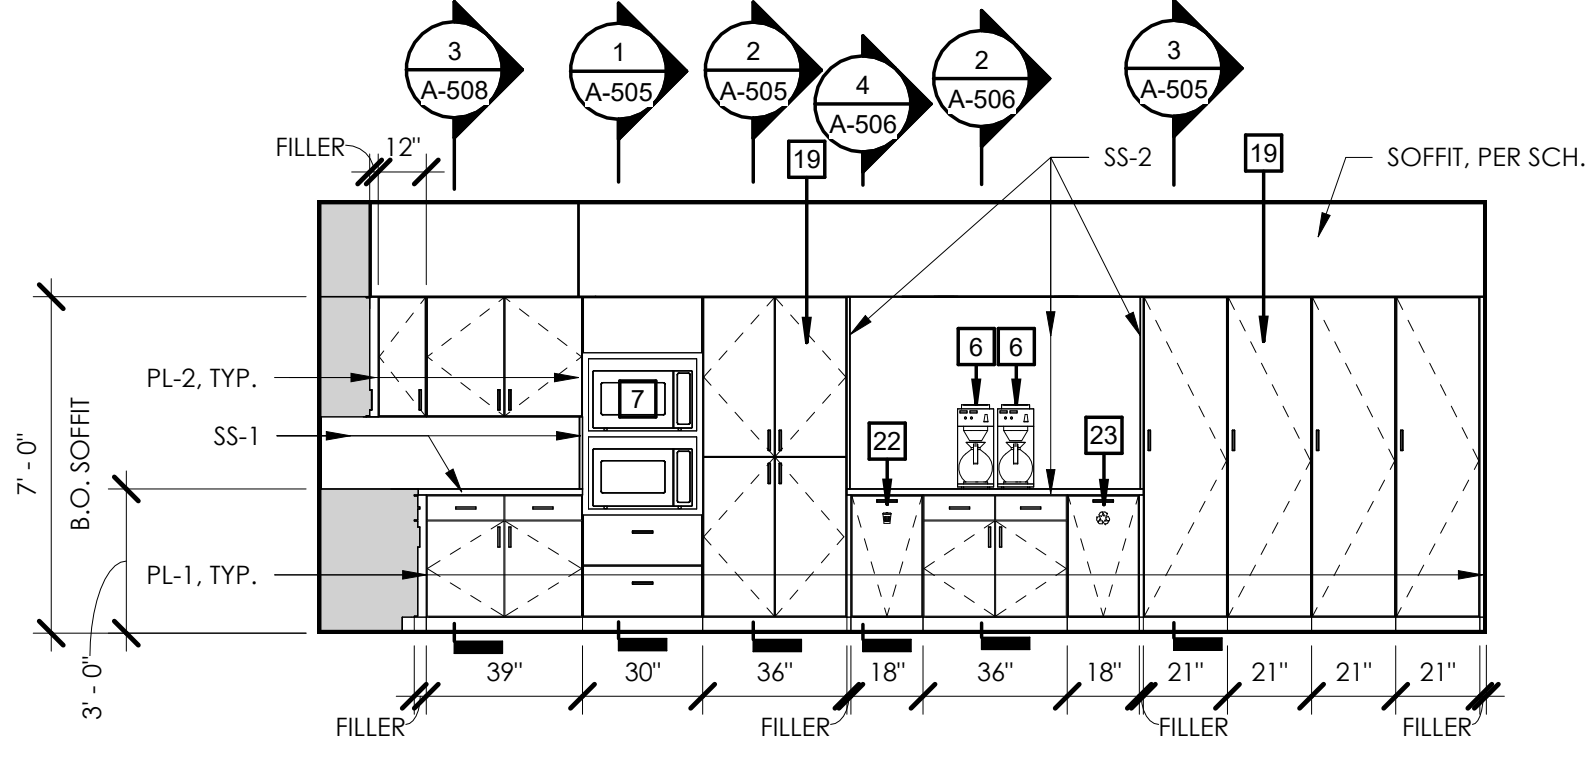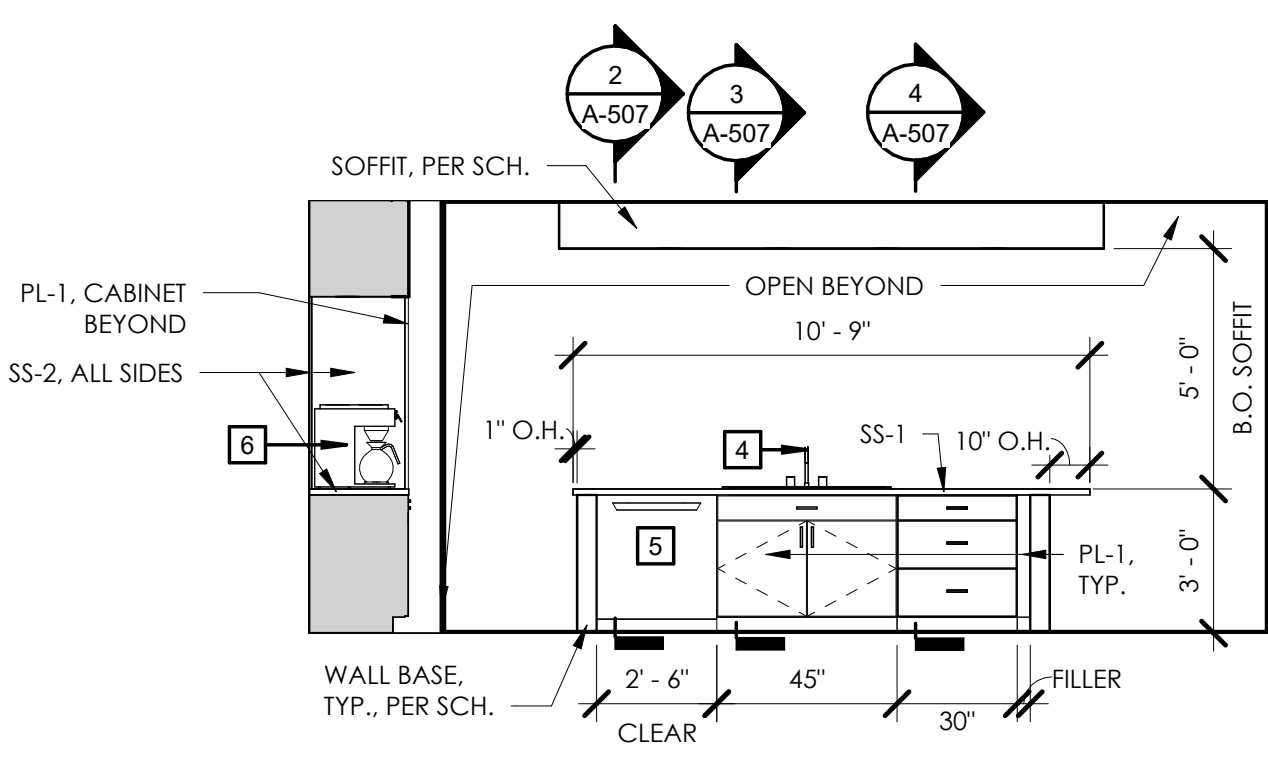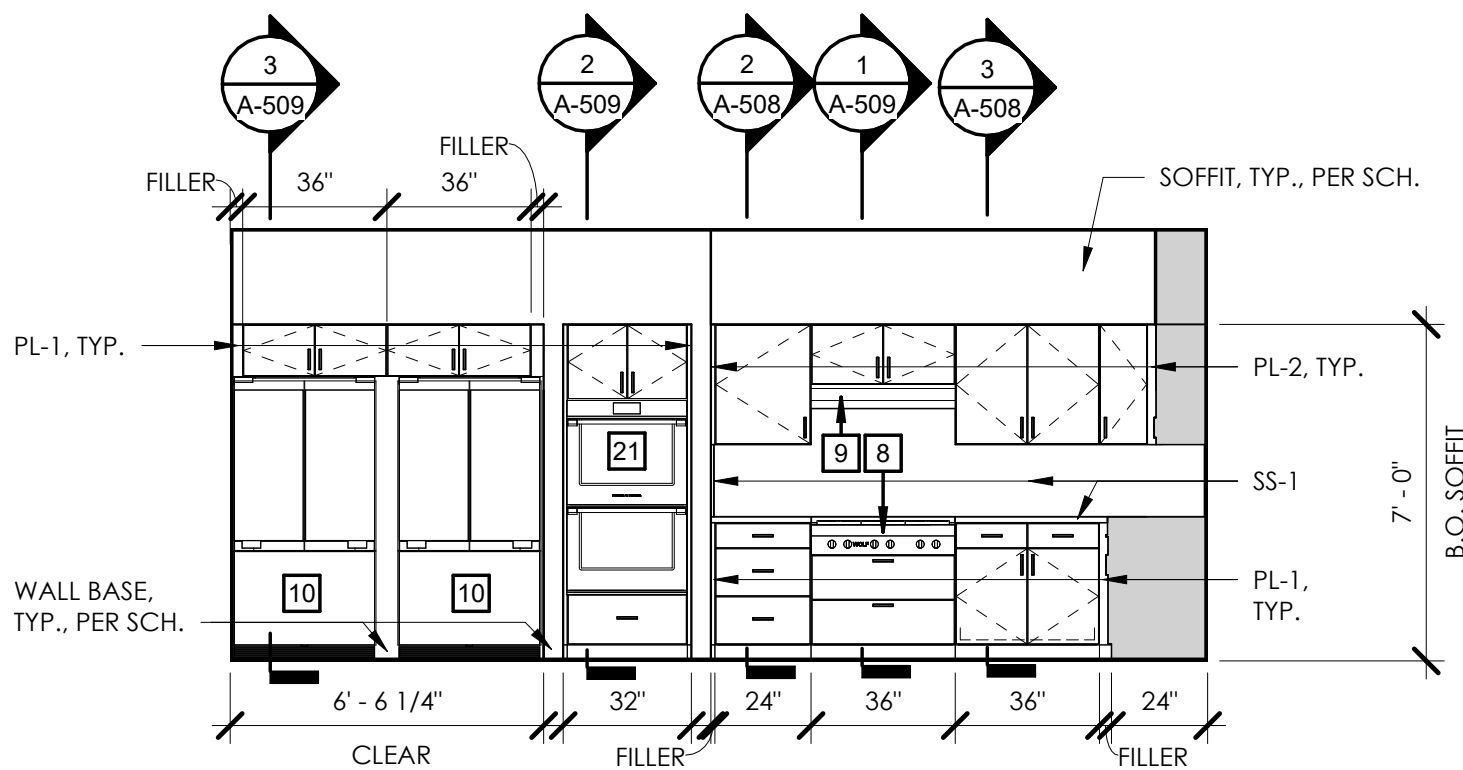

BID SET

CLIENT:
N. GREECE FIRE DISTRICT
1766 LATTA RD
ROCHESTER, NY 14612

Passero Associates

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PROJECT MANAGER TIM GEIER
PROJECT ARCHITECT TIM GEIER
DESIGNER QUILLIE HUGHES

NO.	DATE	BY	DESCRIPTION
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ENLARGED PLANS & INTERIOR ELEVATIONS


1816 ENGLISH RD

NGFD - ENGLISH ROAD
STATION
TOWN/CITY: GREECE
COUNTY: MONROE STATE: NY


PROJECT NO.:
20233530.0001

DRAWING NO.:
A-401


DATE:
JANUARY 22, 2025

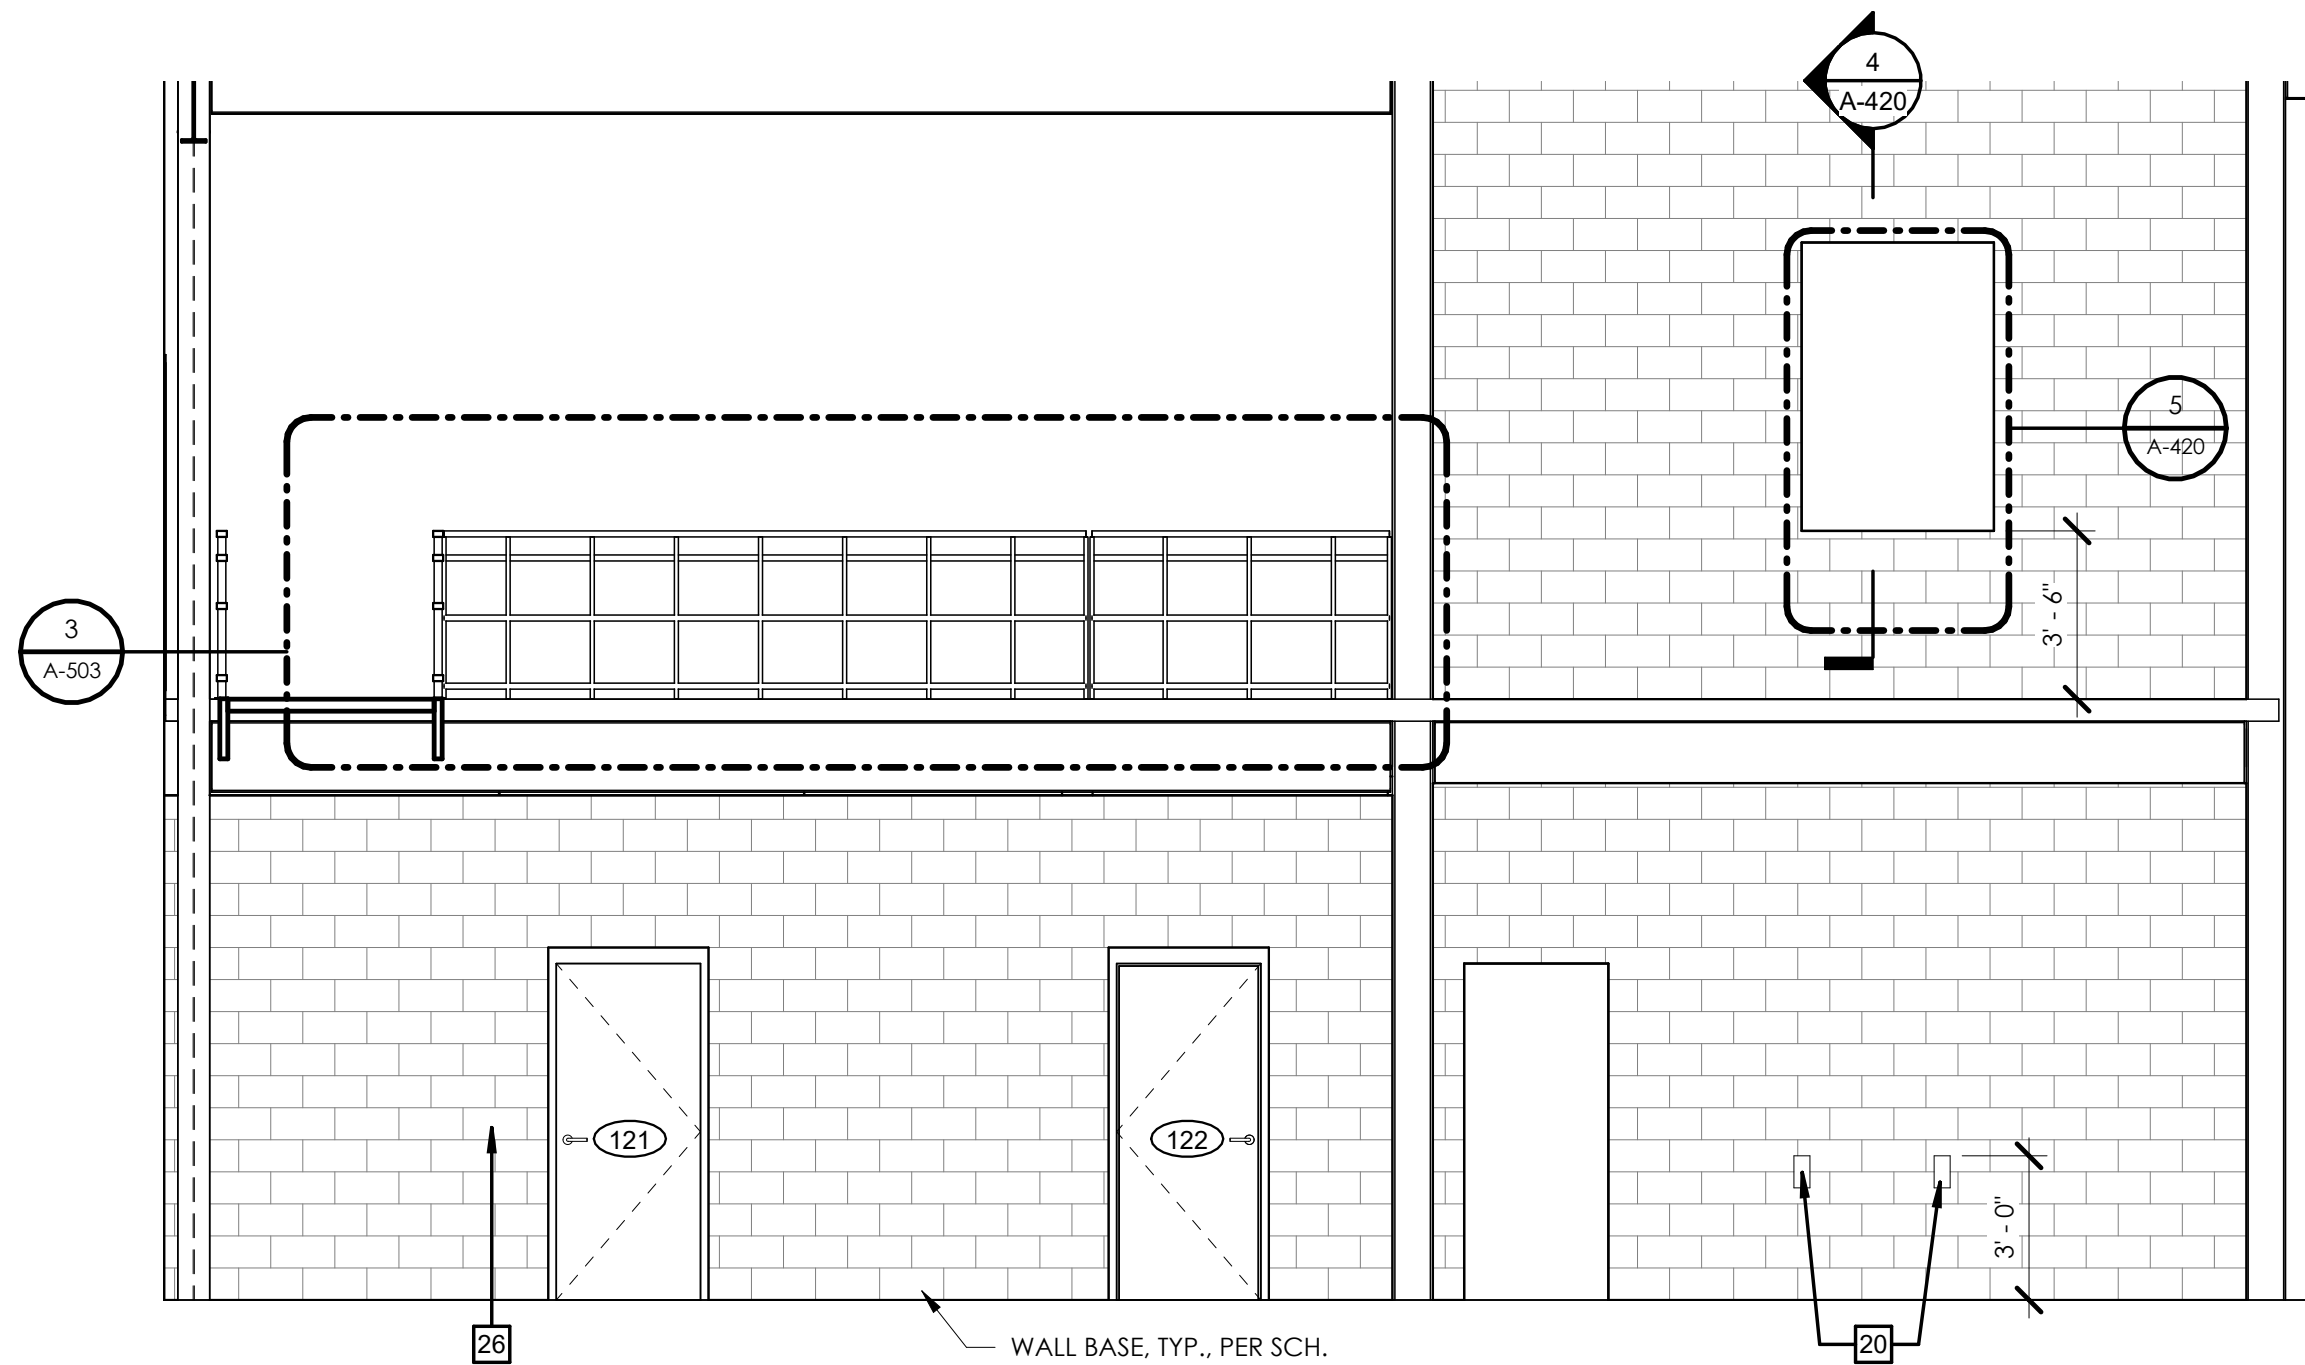


3 MEZZANINE STAIRS NORTH

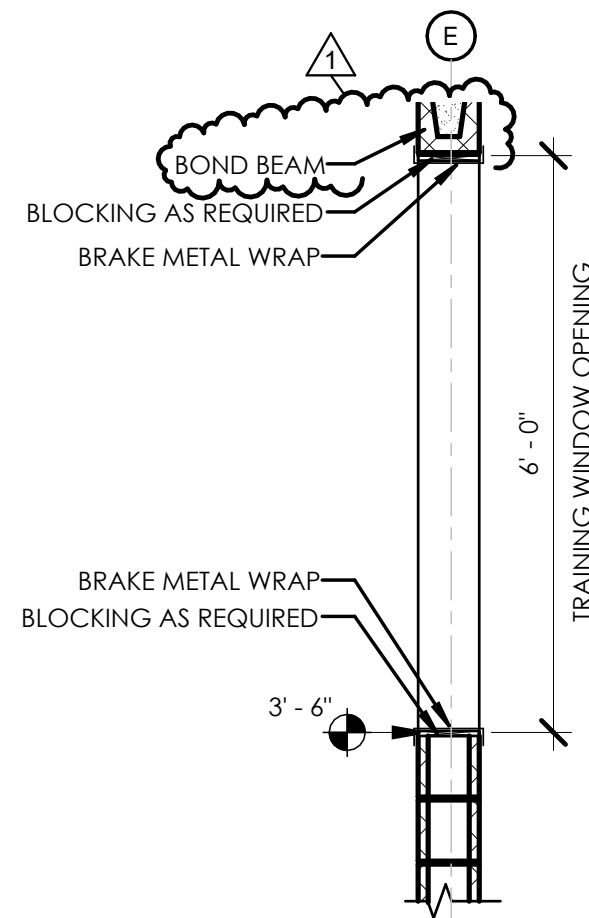


4 SECTION AT TRAINING WINDOW

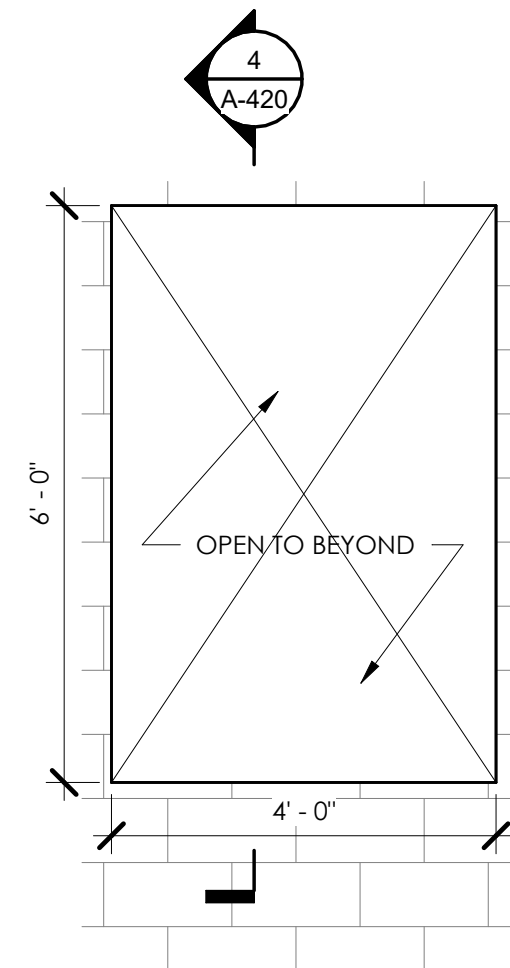

5 ELEVATION AT TRAINING WINDOW

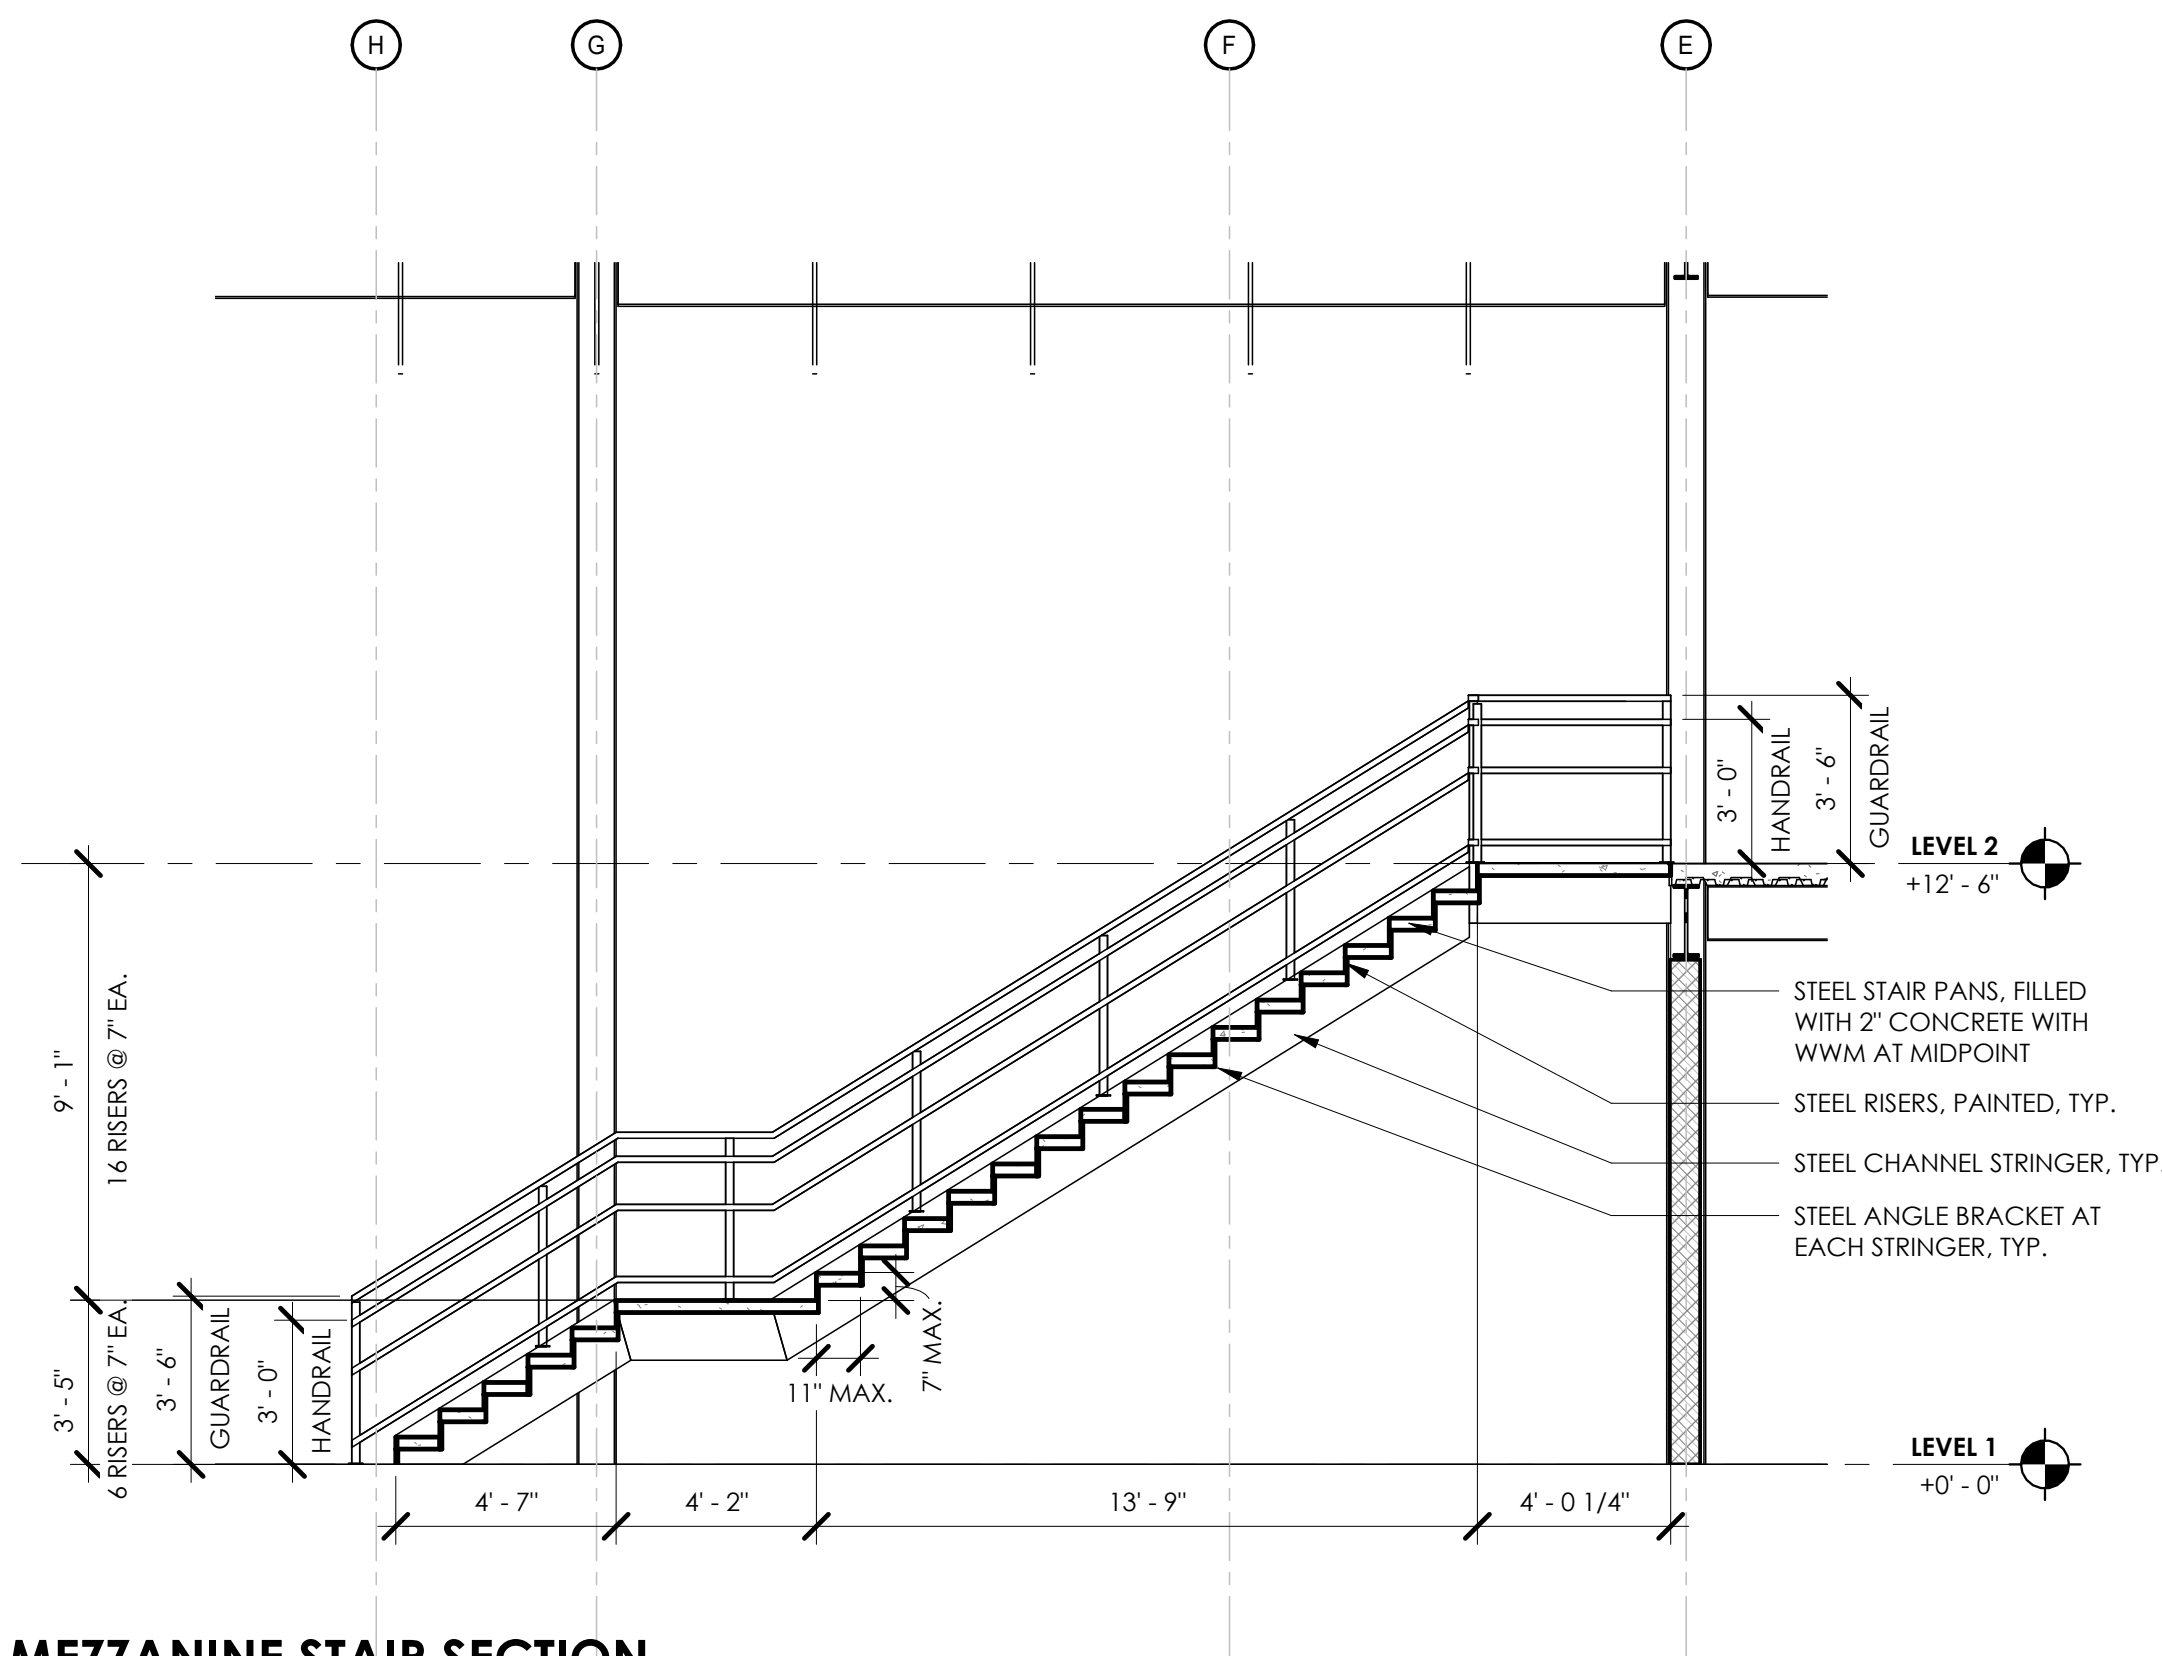

1 MEZZANINE STAIR SECTION

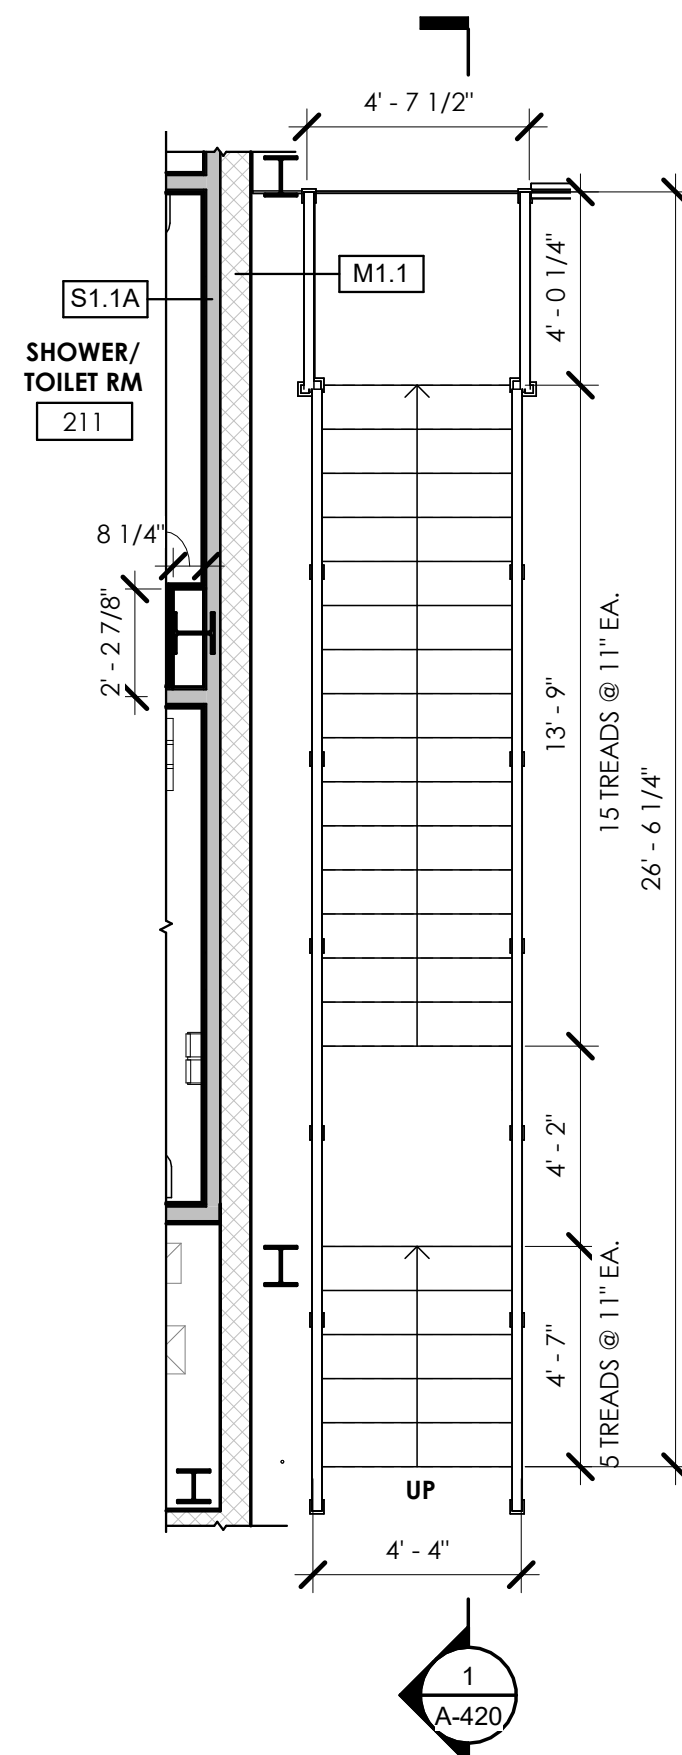

2 ENLARGED PLAN - MEZZANINE STAIRS

GENERAL NOTES - INTERIOR ELEVATIONS:

1. REFER TO I-600 FOR FINISH LEGEND AND I-601 FOR FINISH SCHEDULE
2. REFER TO I-100 SERIES FOR FINISH PLANS
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KEYNOTES - ELEVATIONS INTERIOR 0

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3	DRYER
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5	DISHWASHER - OWNER PROVIDED, INSTALLED BY GC
6	COFFEE STATION - HARD PIPED PER PLUMBING. OWNER PROVIDED, INSTALLED BY GC
7	MICROWAVE - OWNER PROVIDED, INSTALLED BY GC
8	GAS COOKTOP - OWNER PROVIDED, INSTALLED BY GC
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23	RECYCLING DRAWER. REFER TO MILLWORK DETAILS
24	FULL HEIGHT LOCKERS
24	LOCKERS - 72"H X 24"W X 24"D
25	HALF LOCKERS
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ENLARGED PLANS &
INTERIOR
ELEVATIONS

1816 ENGLISH RD


NGFD - ENGLISH ROAD
STATION
TOWN/CITY: GREECE
COUNTY: MONROE STATE: NY

PROJECT NO.:
20233530.0001

DRAWING NO.:
A-420


DATE:
JANUARY 22, 2025

BID SET

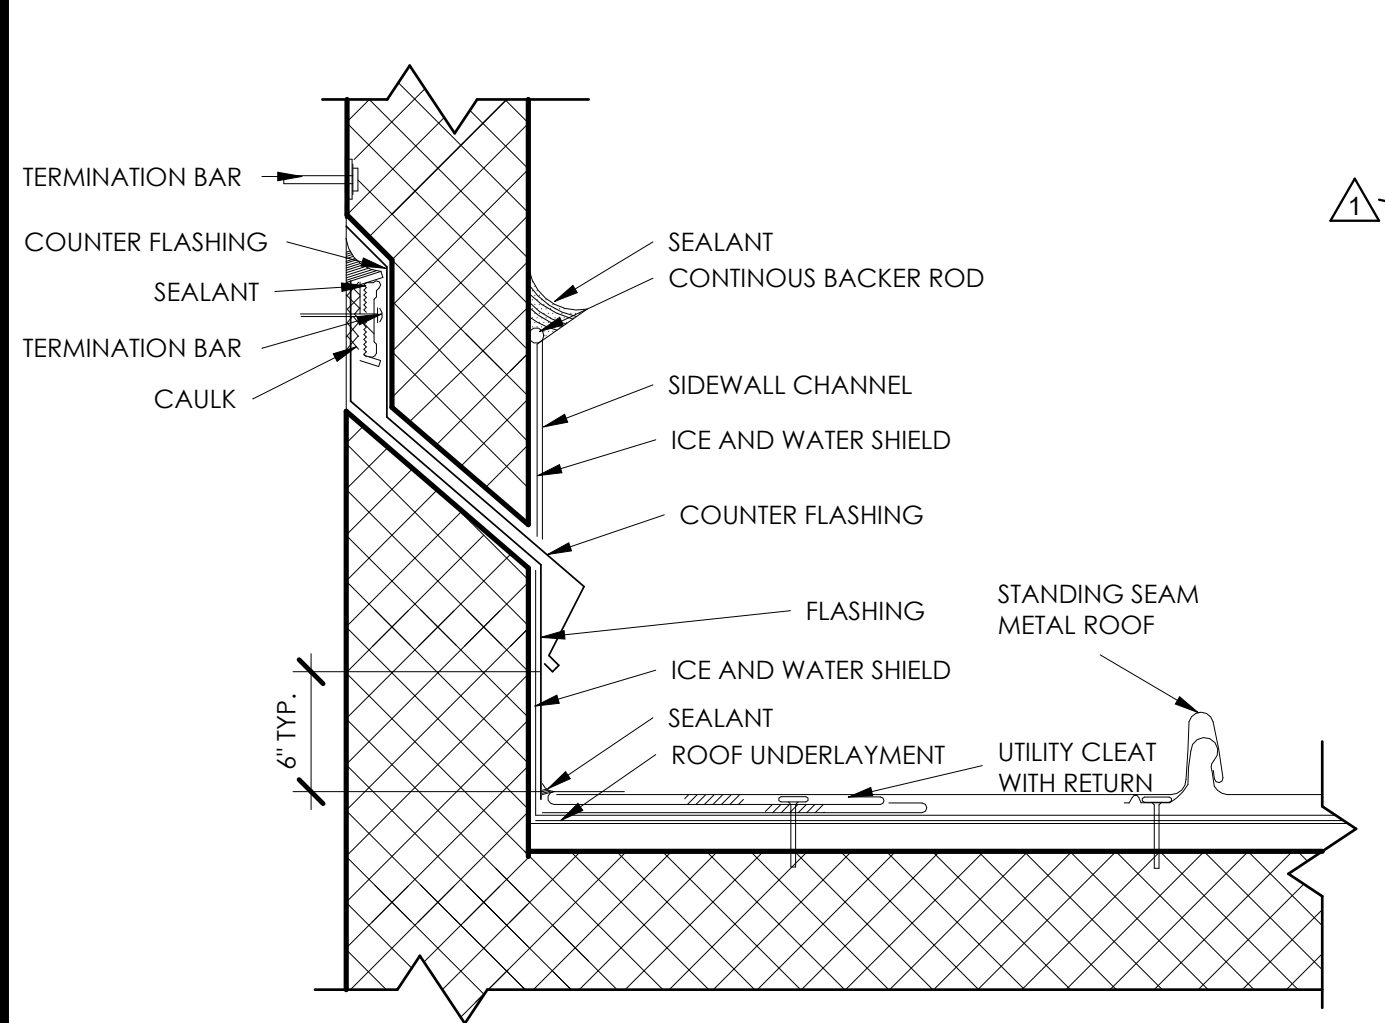

6 METAL ROOF FLASHING AT EIFS

0' 1' 2' 4' 8'
6" = 1'-0"

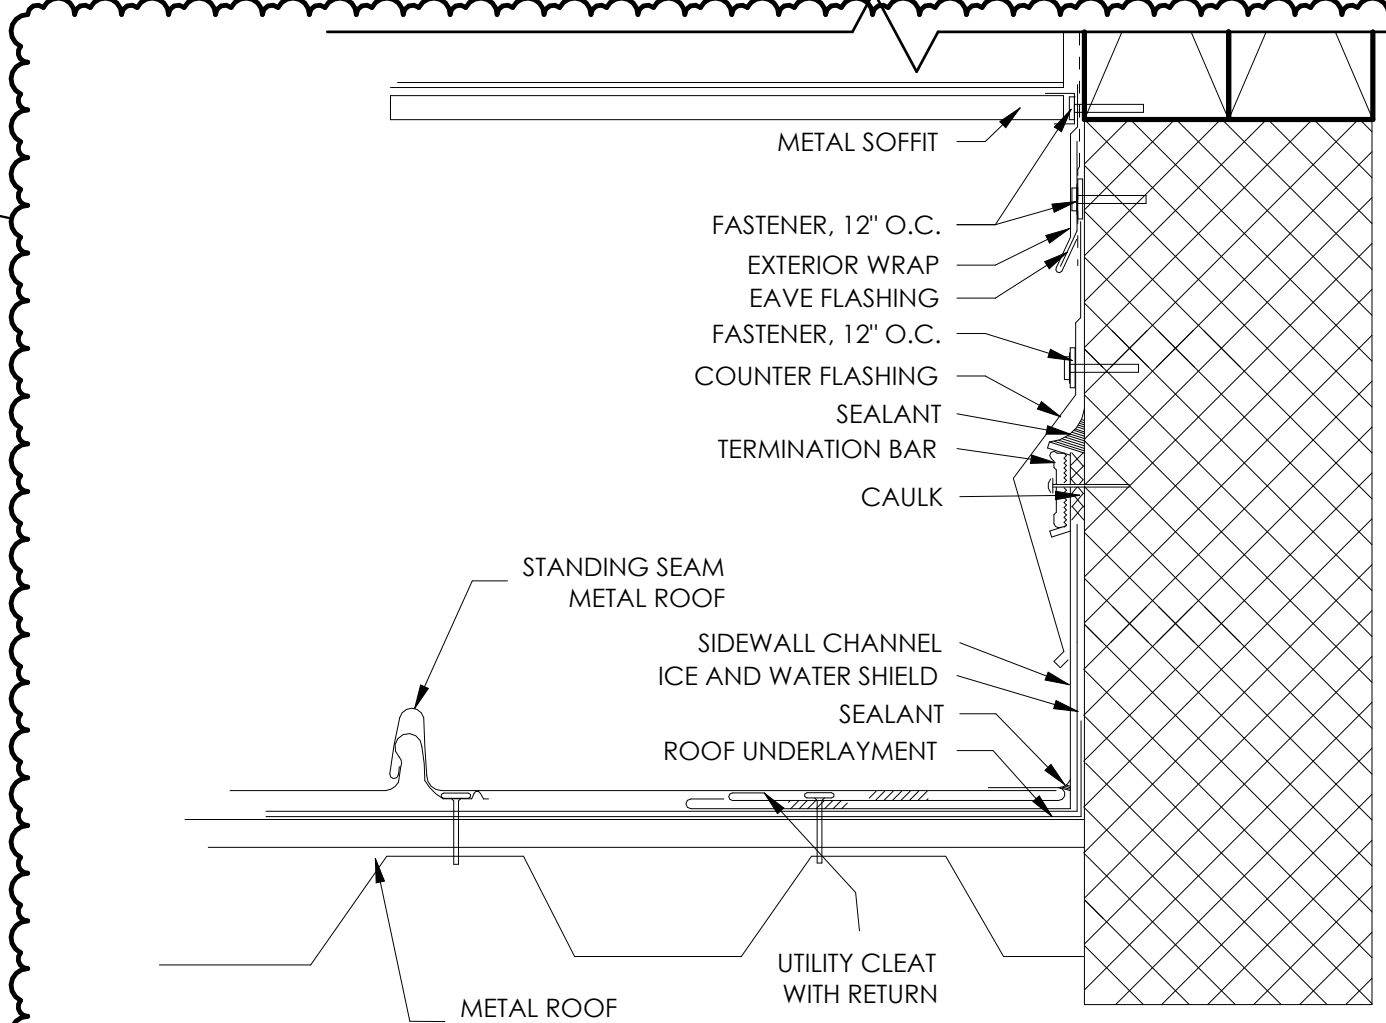



7 METAL ROOF SIDEWALL FLASHING AT DORMER

0' 1' 2' 4' 8'
6" = 1'-0"

KEYNOTES:


- TRIM FASTENERS ARE SELF-TAPPING PANCAKE HEAD AND MUST BE INSTALLED IN A STAGGERED PATTERN
- CLIP FASTENERS MUST PENETRATE WOOD SUBSTRATE BY 5/8" MINIMUM THREAD LENGTH
- FASTENER SPACING VARIES BASED ON PROJECT SPECIFIC LOADS AND/OR LOCAL BUILDING CODES

FLASHINGS

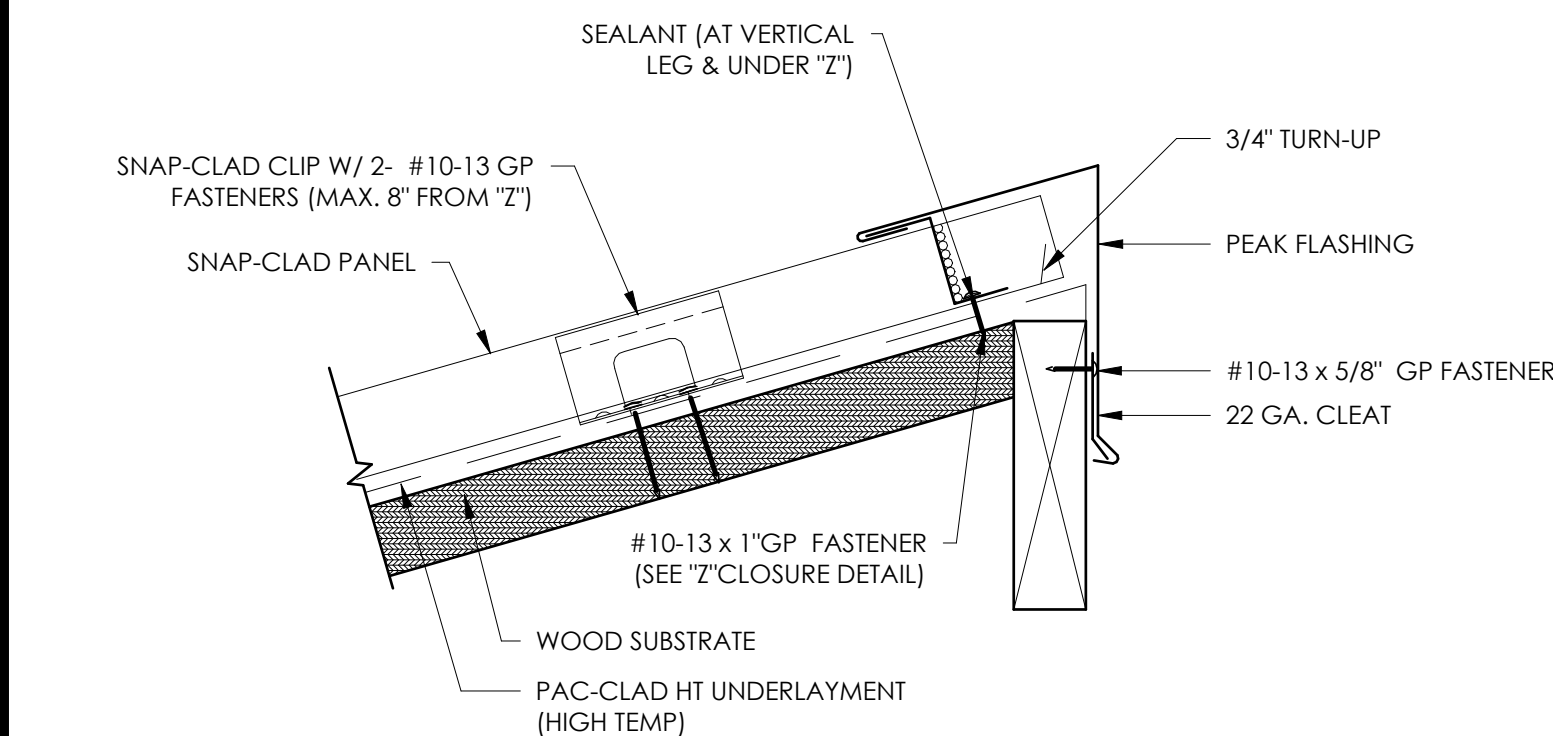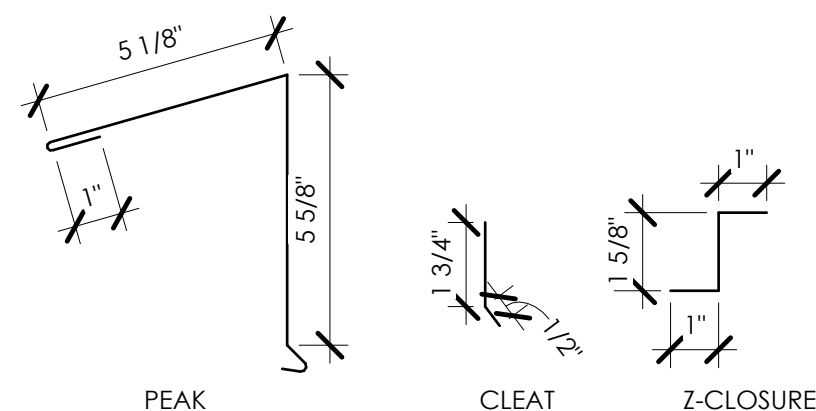

5 PEAK DETAIL



0' 3' 6' 1'
3" = 1'-0"

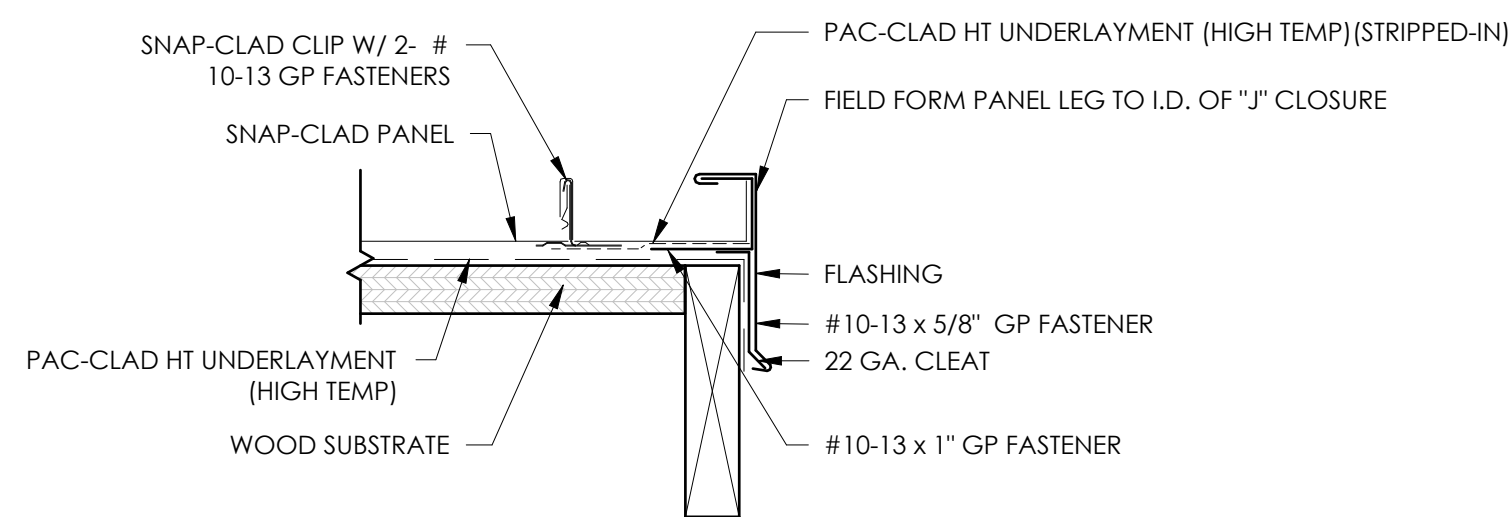

3 GABLE DETAIL

0' 3' 6' 1'
3" = 1'-0"

FLASHINGS

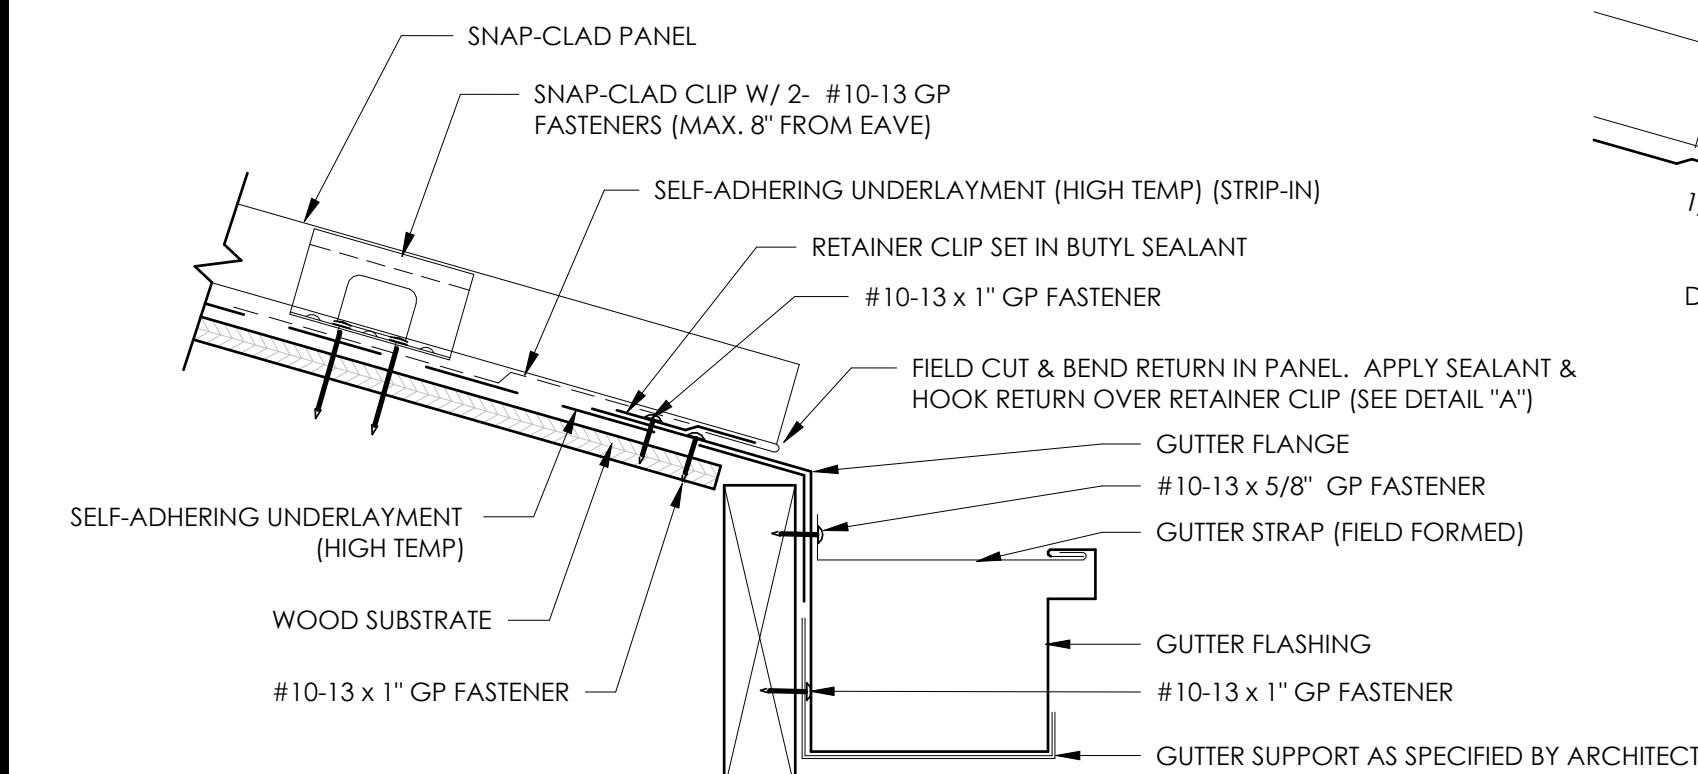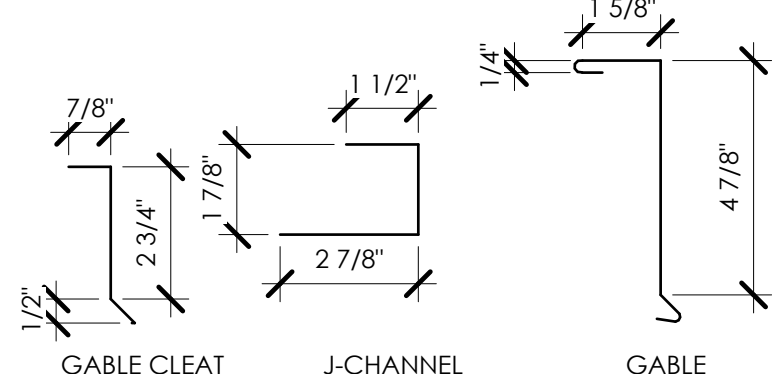


1 GUTTER DETAIL

0' 3' 6' 1'
3" = 1'-0"

8 EAVE DETAIL


0' 3' 6' 1'
3" = 1'-0"

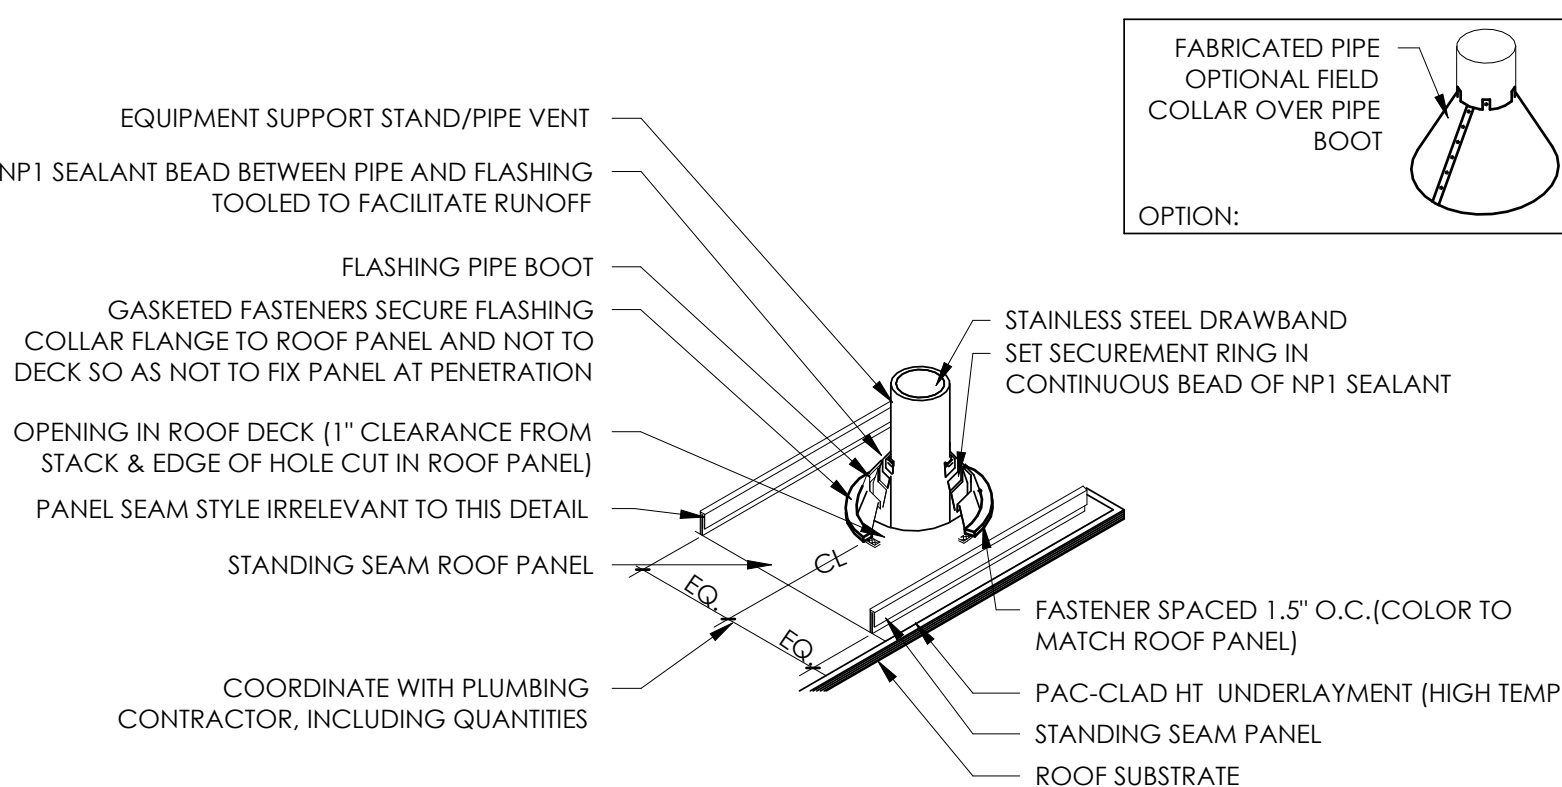

DISCLAIMER: DETAIL SHOWN FOR ILLUSTRATION PURPOSES ONLY. ACTUAL PROJECT DETAIL MAY VARY


4 PIPE PENETRATION DETAIL

0' 3' 6' 1'
3" = 1'-0"

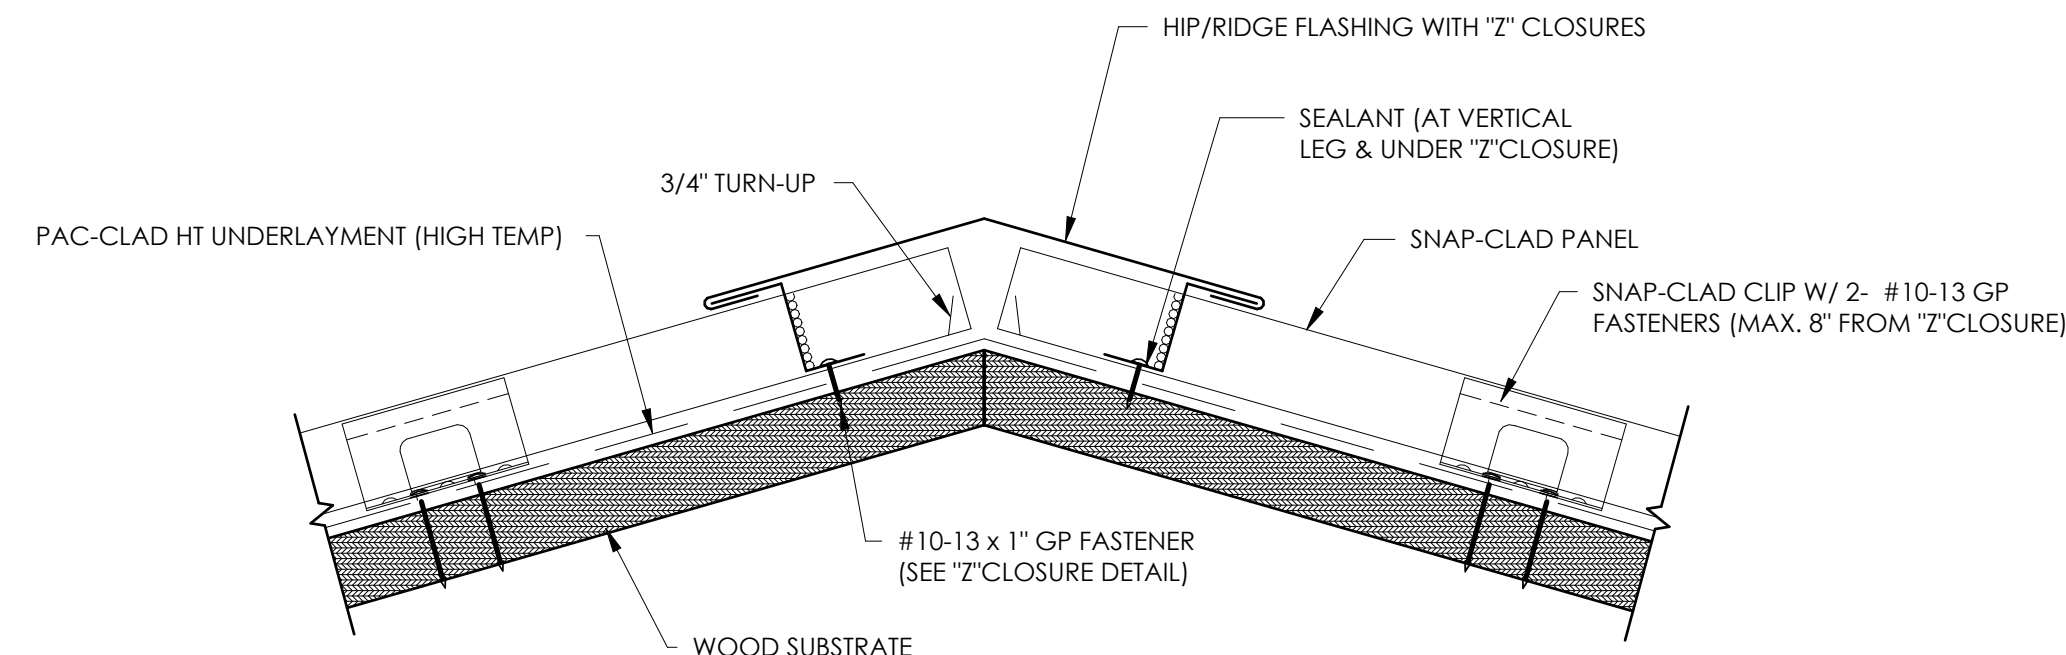

2 HIP RIDGE DETAIL

0' 3' 6' 1'
3" = 1'-0"

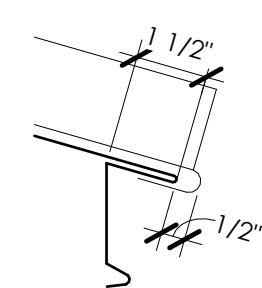


DETAIL "A"

KEYNOTES:

- TRIM FASTENERS ARE SELF-TAPPING PANCAKE HEAD AND MUST BE INSTALLED IN A STAGGERED PATTERN
- CLIP FASTENERS MUST PENETRATE WOOD SUBSTRATE BY 5/8" MINIMUM THREAD LENGTH
- FASTENER SPACING VARIES BASED ON PROJECT SPECIFIC LOADS AND/OR LOCAL BUILDING CODES

FLASHINGS

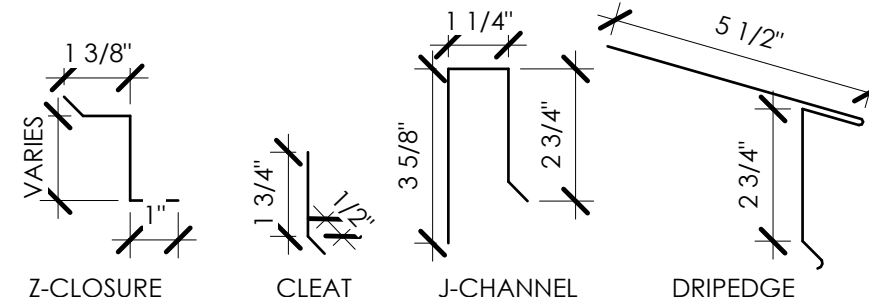

NOTES:

1. POSITION SQUARE BASED BOOTS IN A DIAMOND ORIENTATION WHERE POSSIBLE TO AID IN DIVERTING WATER.
2. PIPE PENETRATION TO BE IN PAN OF PANEL ONLY.
3. FIELD CUT HOLE IN PANEL 1" LESS THAN DIA. OF STACK. BACK CUT HOLE AND BEND PANEL UP AROUND STACK. SEAL CONTINUOUS.
4. IF PANELS ARE 30' OR LONGER, CUT OVERSIZE HOLE TO ALLOW FOR THERMAL MOVEMENT.
5. IF PIPE IS MADE OF METAL, IT MUST BE PAINTED TO PREVENT RUST RUN-OFF FROM STAINING PANELS. PAINT PVC PIPES TO MATCH COLOR OF ROOF PANEL.
6. ALL FASTENERS DRILLED THROUGH ALUMINUM MUST BE STAINLESS STEEL.

KEYNOTES:

- TRIM FASTENERS ARE SELF-DRILL PANCAKE HEAD ANDMUST BE INSTALLED IN A STAGGERED PATTERN
- CLIP FASTENERS MUST PENETRATE WOOD SUBSTRATE BY 5/8" MINIMUM THREAD LENGTH

STAMP:

CLIENT:
N. GREECE FIRE DISTRICT
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ROCHESTER, NY 14612

Passero Associates

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PROJECT MANAGER: TIM GEIER
PROJECT ARCHITECT: TIM GEIER
DESIGNER: QUILLIE HUGHES

NO.	DATE	BY	DESCRIPTION
1	01/30/25		ADDENDUM 1

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ROOF DETAILS

1816 ENGLISH RD

NGFD - ENGLISH ROAD
STATION

TOWN/CITY: GREECE

COUNTY: MONROE STATE: NY

20233530.0001

DRAWING NO.:





A-501

DATE:

JANUARY 22, 2025



BID SET

DOOR SCHEDULE																
DOOR #	DOOR MTL.	DOOR FIN.	# OF LEAVES	THICKNESS	DOOR					ELEV. LETTER	FRAME TYPE	FRAME FINISH	HEAD DTL	JAMB DTL	HW SET #s	REMARKS
					WIDTH	HEIGHT	LABEL RATING	LOUVER	GLASS							
LEVEL 1																
100	ALUM.	FACTORY	1	1 3/4"	3' - 0"	7' - 0"	-		FULL	D	F2	ALUM./FACTORY	11	12		
101	WOOD	STAIN	1	1 3/4"	3' - 0"	7' - 0"	-		HALF	D	F1	H.M./PT-3	5	6		
103	WOOD	STAIN	1	1 3/4"	3' - 0"	7' - 0"	-		-	B	F1	H.M./PT-3	5	6		
104	WOOD	STAIN	1	1 3/4"	3' - 0"	7' - 0"	-		HALF	E	F1	H.M./PT-3	5	6		
105	WOOD	STAIN	1	1 3/4"	3' - 0"	7' - 0"	-		-	B	F1	H.M./PT-3	5	6		
106A	WOOD	STAIN	1	1 3/4"	3' - 0"	7' - 0"	-		-	B	F1	H.M./PT-3	5	6		
106B	ALUM.	FACTORY	1	1 3/4"	3' - 0"	7' - 0"	-		-	B	F2	ALUM./FACTORY	11	12		
108	WOOD	STAIN	1	1 3/4"	3' - 6"	7' - 0"	-		HALF	E	F1	H.M./PT-3	5	6		
109A	WOOD	STAIN	1	1 3/4"	3' - 0"	7' - 0"	60 MIN.		HALF	E	F2	H.M./PT-3	7	8		
109B	ALUM.	FACTORY	1	1 3/4"	3' - 0"	7' - 0"	60 MIN.		VP	C	F2	ALUM./FACTORY	11	12		
110	WOOD	STAIN	1	1 3/4"	3' - 0"	7' - 0"	-		-	B	F1	H.M./PT-3	5	6		
111	WOOD	STAIN	1	1 3/4"	3' - 0"	7' - 0"	-		-	B	F1	H.M./PT-3	5	6		
112	WOOD	STAIN	1	1 3/4"	3' - 0"	7' - 0"	-		HALF	E	F1	H.M./PT-3	5	6		
113A	WOOD	STAIN	1	1 3/4"	3' - 0"	7' - 0"	-		-	B	F1	H.M./PT-3	5	6		
113B	H.M.	PT-3	1	1 3/4"	2' - 8"	7' - 0"	-		-	B	F2	H.M./PT-3	5	6		
116A	WOOD	STAIN	1	1 3/4"	3' - 0"	7' - 0"	-		HALF	E	F1	H.M./PT-3	5	6		
116B	WOOD	STAIN	1	1 3/4"	3' - 0"	7' - 0"	-		HALF	E	F1	H.M./PT-3	5	6		
117	WOOD	STAIN	1	1 3/4"	3' - 0"	7' - 0"	-		HALF	E	F2	H.M./PT-3	7	8		
120A	ALUM.	FACTORY	1	1 3/4"	3' - 0"	7' - 0"	-		VP	C	F2	ALUM./FACTORY	11	12		
120B	WOOD	STAIN	1	1 3/4"	3' - 0"	7' - 0"	-		-	E	F2	H.M./PT-3	7	8		
120C	WOOD	STAIN	1	1 3/4"	3' - 0"	7' - 0"	-		-	E	F2	H.M./PT-3	7	8		
121	WOOD	STAIN	1	1 3/4"	3' - 0"	7' - 0"	-		-	B	F2	H.M./PT-3	7	8		
122	WOOD	STAIN	1	1 3/4"	3' - 0"	7' - 0"	-		-	B	F2	H.M./PT-3	7	8		
123	WOOD	STAIN	1	1 3/4"	3' - 0"	7' - 0"	-		-	B	F1	H.M./PT-3	5	6		
124	H.M.	PT-3	1	1 3/4"	3' - 6"	7' - 0"	-		VP	F	F2	H.M./PT-3	7	8		
125	WOOD	STAIN	1	1 3/4"	3' - 0"	7' - 0"	-		-	B	F1	H.M./PT-3	5	6		
125A	H.M.	PT-3	2	1 3/4"	6' - 0"	7' - 0"	-		-	A	F2	H.M./PT-3	7	8		
125B	ALUM.	FACTORY	1	1 3/4"	3' - 0"	7' - 0"	-		VP	C	F2	ALUM./FACTORY	11	12		
125C	H.M.	PT-3	2	1 3/4"	6' - 0"	7' - 0"	-		-	A	F1	H.M./PT-3	5	6		
126A	ALUM.	FACTORY	1	1 3/4"	3' - 0"	7' - 0"	-		FULL	D	F7	ALUM./FACTORY	11	12		
126B	ALUM.	FACTORY	1	1 3/4"	3' - 0"	7' - 0"	-		VP	C	F2	ALUM./FACTORY	11	12		
126C	ALUM.	FACTORY	1	1 3/4"	3' - 0"	7' - 0"	-		VP	C	F2	ALUM./FACTORY	11	12		
126D	ALUM.	FACTORY	4	2 1/4"	14' - 0"	14' - 0"	-		FULL	H	-	ALUM./FACTORY	-	-		
126E	ALUM.	FACTORY	4	2 1/4"	14' - 0"	14' - 0"	-		FULL	H	-	ALUM./FACTORY	-	-		
126F	ALUM.	FACTORY	4	2 1/4"	14' - 0"	14' - 0"	-		FULL	H	-	ALUM./FACTORY	-	-		
126G	ALUM.	FACTORY	-	1 1/2"	14' - 0"	14' - 0"	-		VP	G	-	ALUM./FACTORY	15	16		
LEVEL 2																
201	WOOD	STAIN	1	1 3/4"	3' - 0"	7' - 0"	20 MIN.		-	B	F1	H.M./PT-3	5	6		
202	WOOD	STAIN	1	1 3/4"	3' - 0"	7' - 0"	20 MIN.		-	B	F1	H.M./PT-3	5	6		
203	WOOD	STAIN	1	1 3/4"	3' - 0"	7' - 0"	20 MIN.		-	B	F1	H.M./PT-3	5	6		
204	WOOD	STAIN	1	1 3/4"	3' - 0"	7' - 0"	20 MIN.		-	B	F1	H.M./PT-3	5	6		
205	WOOD	STAIN	1	1 3/4"	3' - 0"	7' - 0"	20 MIN.		-	B	F1	H.M./PT-3	5	6		
206	WOOD	STAIN	1	1 3/4"	3' - 0"	7' - 0"	20 MIN.		HALF	E	F1	H.M./PT-3	5	6		
207	WOOD	STAIN	1	1 3/4"	3' - 0"	7' - 0"	20 MIN.		-	B	F1	H.M./PT-3	5	6		
208	WOOD	STAIN	1	1 3/4"	3' - 0"	7' - 0"	20 MIN.		HALF	E	F1	H.M./PT-3	5	6		
209	WOOD	STAIN	1	1 3/4"	3' - 0"	7' - 0"	60 MIN.		HALF	E	F2	H.M./PT-3	7	8		
210	WOOD	STAIN	1	1 3/4"	3' - 0"	7' - 0"	-		HALF	E	F2	H.M./PT-3	7	8		
211	WOOD	STAIN	1	1 3/4"	3' - 0"	7' - 0"	-		HALF	E	F1	H.M./PT-3	5	6		
212	WOOD	STAIN	1	1 3/4"	3' - 0"	7' - 0"	-		HALF	E	F1	H.M./PT-3	5	6		
213	WOOD	STAIN	1	1 3/4"	3' - 0"	7' - 0"	-		-	B	F1	H.M./PT-3	5	6		
215	WOOD	STAIN	1	1 3/4"	3' - 0"	7' - 0"	60 MIN.		HALF	E	F1	H.M./PT-3	5	6		
216	WOOD	STAIN	1	1 3/4"	3' - 0"	7' - 0"	60 MIN.		HALF	E	F1	H.M./PT-3	5	6		
217	WOOD	STAIN	1	1 3/4"	3' - 0"	7' - 0"	60 MIN.		HALF	E	F1	H.M./PT-3	5	6		
218	WOOD	STAIN	1	1 3/4"	3' - 0"	7' - 0"	-		HALF	E	F1	H.M./PT-3	5	6		
219	WOOD	STAIN	1	1 3/4"	3' - 0"	7' - 0"	-		-	B	F1	H.M./PT-3	5	6		
220	WOOD	STAIN	1	1 3/4"	2' - 6"	6' - 8"	-		-	B	F1	H.M./PT-3	5	6		
221	WOOD	STAIN	1	1 3/4"	3' - 0"	7' - 0"	60 MIN.		-	B	F1	H.M./PT-3	5	6		
223	H.M.	PT-3	1	1 3/4"	3' - 0"	7' - 0"	-		VP	C	F2	H.M./PT-3	7	8		
226	H.M.	PT-3	2	1 3/4"	6' - 0"	7' - 0"	-		-	A	F2	H.M./PT-3	7	8		
ATTIC																
233	ALUM.	FACTORY	1	1 3/4"	3' - 0"	7' - 0"	-		-	B	F1	ALUM./FACTORY				

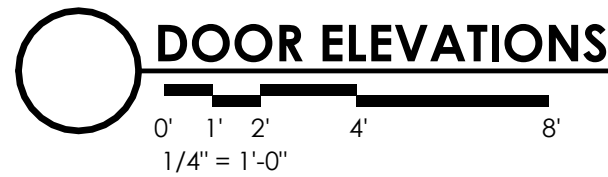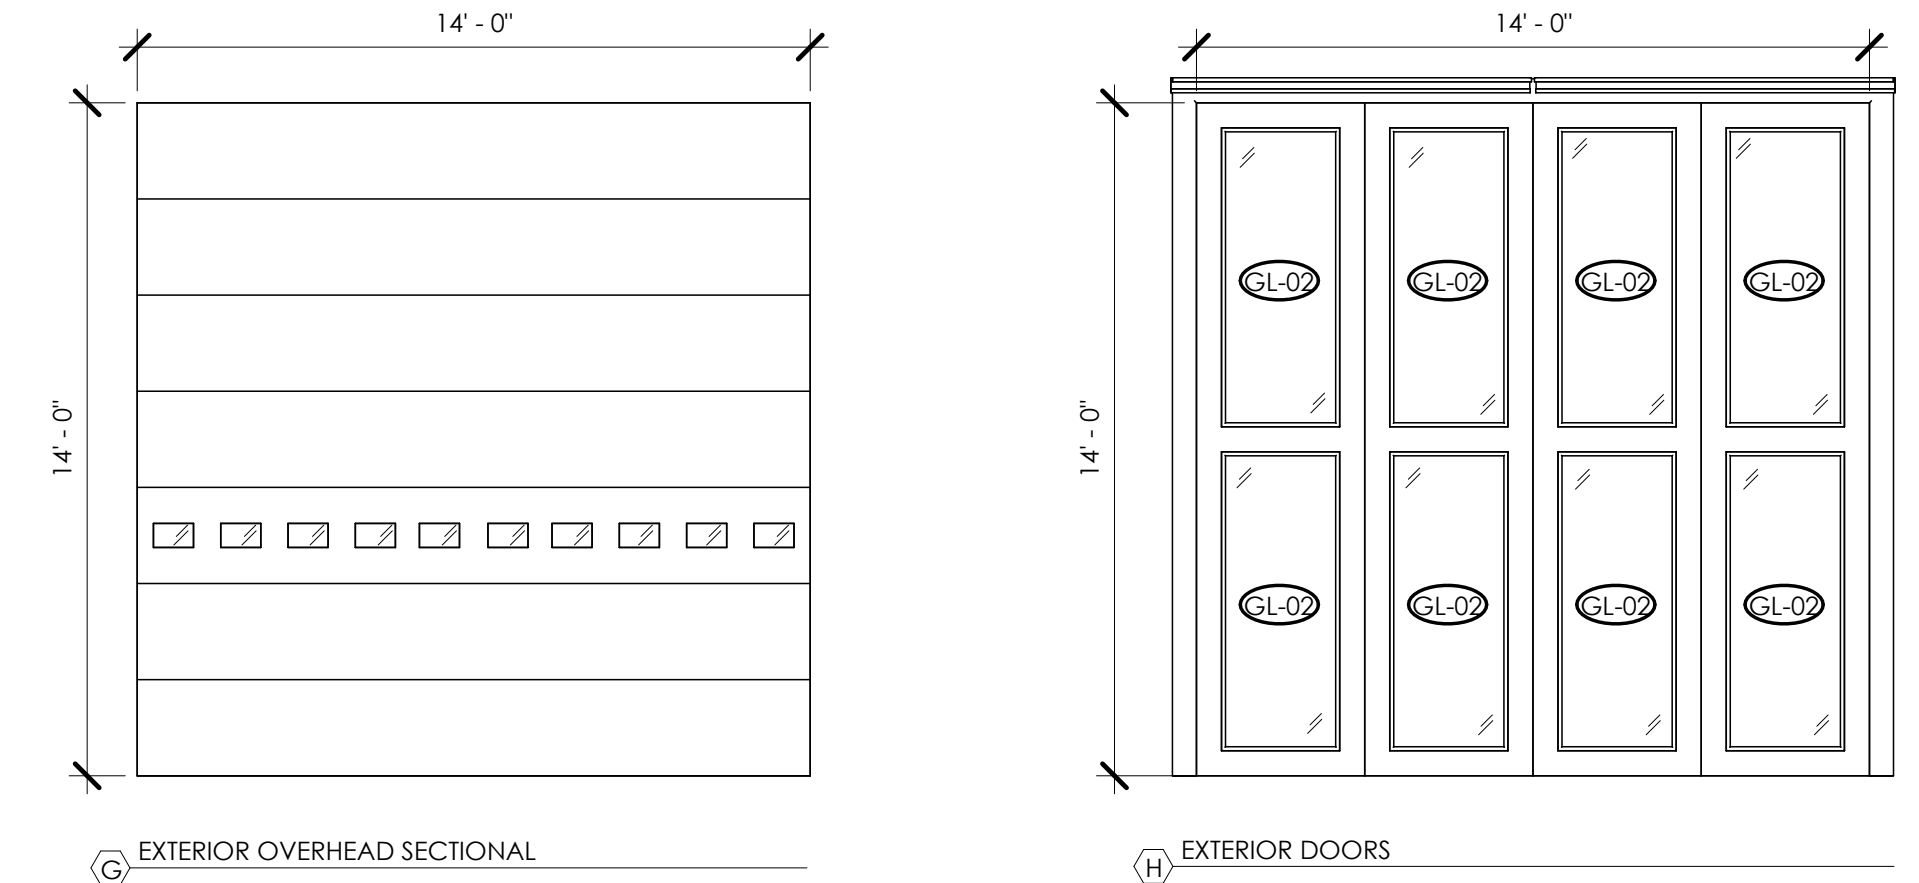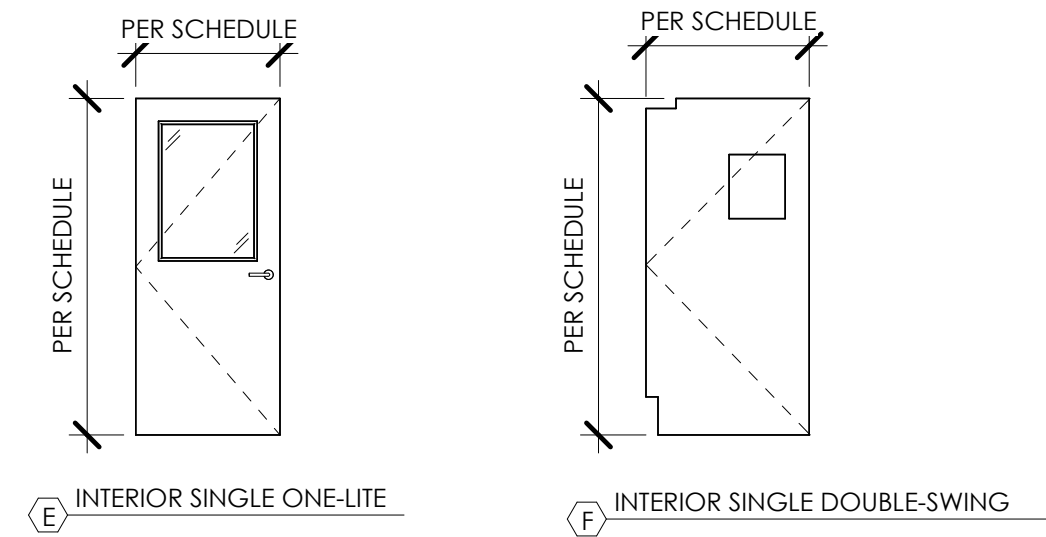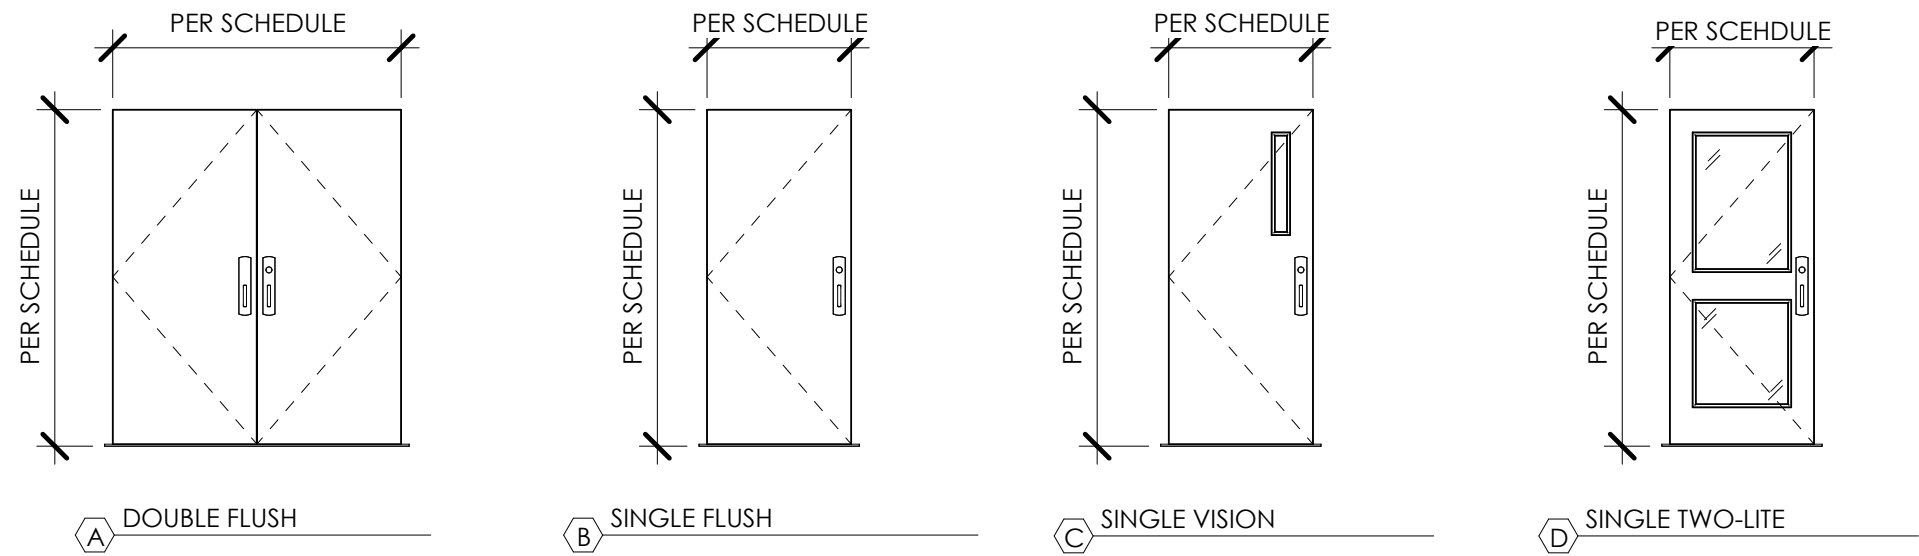

GLAZING TYPES

- GL-01 INSULATED, LOW-E
- GL-02 INSULATED, LOW-E, TEMPERED SAFETY GLAZING, CLEAR
- GL-03 INSULATED, LOW-E, TINTED

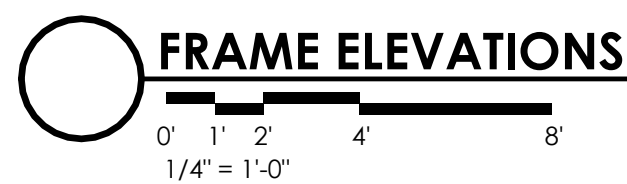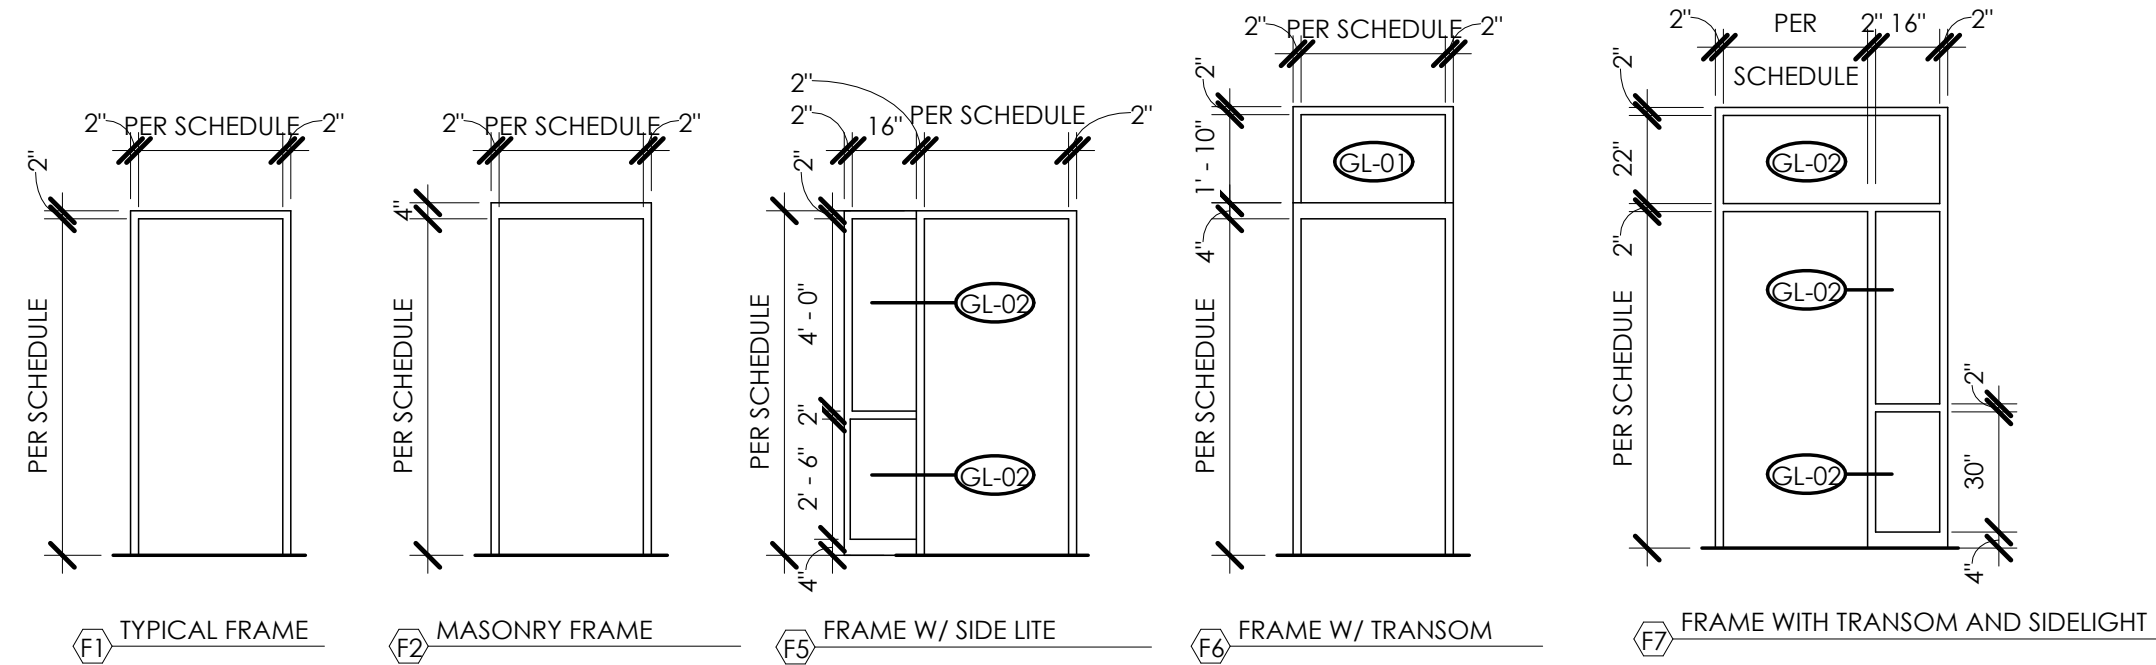

BID SET

STAMP:

CLIENT:
N. GREECE FIRE DISTRICT
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PROJECT MANAGER: TIM GEIER
PROJECT ARCHITECT: TIM GEIER
DESIGNER: QUILL HUGHES

NO.	DATE	BY	DESCRIPTION
1	01/30/25		ADDENDUM 1

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DOOR SCHEDULE

1816 ENGLISH RD

NGFD - ENGLISH ROAD
STATION
TOWN/CITY: GREECE

COUNTY: MONROE STATE: NY

PROJECT NO.:

20233530.0001

DRAWING NO.:

A-600

DATE:

JANUARY 22, 2025